

Westchester  
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WESTCHESTER COUNTY, NEW YORK  
DEPARTMENT OF PUBLIC WORKS AND TRANSPORTATION  
DIVISION OF ENGINEERING

CONTRACT No. 17-539  
NEW GOLF CART STORAGE FACILITY,  
AND CLUBHOUSE UPGRADES  
MOHANSIC GOLF COURSE  
YORKTOWN, NEW YORK



SITE

LOCATION PLAN

SHEET NO.	SHEET TITLE	DPW FILE NO.
T - 100	TITLE, INDEX TO THE DRAWINGS	10-02-T-34-0
L - 100	EROSION CONTROL, CODE NOTES	10-02-L-35-0
L - 101	SITE PLAN & EX'G. UTILITIES - TEST BORING	10-02-L-36-0
L - 102	EX'G. GOLF CART STORAGE SHED - STAGING PLAN	10-02-L-37-0
L - 103	NEW GOLF CART STORAGE SHED - SITE PLAN	10-02-L-38-0
D - 101	EX'G. GOLF CART STORAGE SHED - DEMOLITION PLAN	10-02-D-39-0
D - 102	EX'G. CLUBHOUSE - BATHRM. & LOCKER - DEMOLITION	10-02-D-40-0
A - 101	NEW GOLF CART STORAGE SHED - PLAN	10-02-A-41-0
A - 102	CLUBHOUSE - NEW BATHRM. & LOCKERS - PLAN & ELEVATIONS	10-02-A-42-0
A - 103	NEW GOLF CART STORAGE SHED - ROOF & CEILING PLANS	10-02-A-43-0
A - 201	NEW GOLF CART STORAGE SHED - EXTERIOR ELEVATIONS	10-02-A-44-0
A - 202	NEW GOLF CART STORAGE SHED - INTERIOR ELEVATIONS	10-02-A-45-0
A - 301	NEW GOLF CART STORAGE SHED - WALL SECTIONS - ELEVATIONS	10-02-A-46-0
A - 302	NEW GOLF CART STORAGE SHED - WALL SECTIONS - DETAILS	10-02-A-47-0
A - 303	NEW GOLF CART STORAGE SHED - WALL SECTIONS - ELEVATIONS	10-02-A-48-0
A - 501	DETAILS	10-02-A-49-0
A - 601	DOOR SCHEDULE & DETAILS	10-02-A-50-0
S - 001	STRUCTURAL NOTES	10-02-S-51-0
F - 101	FOUNDATION PLANS	10-02-F-52-0
F - 501	FOUNDATION SECTIONS & DETAILS	10-02-F-53-0
S - 101	STRUCTURAL FRAMING PLANS	10-02-S-54-0
S - 501	STRUCTURAL SECTIONS & DETAILS	10-02-S-55-0
EQ- 101	WASHING, MIXING & RECYCLE EQUIPMENT	10-02-EQ-56-0
C - 101	OVERALL SITE PLAN	10-02-C-57-0
C - 102	GOLF CART STORAGE FACILITY	10-02-C-58-0
C - 103	CONSTRUCTION DETAILS	10-02-C-59-0
C - 104	CONSTRUCTION DETAILS	10-02-C-60-0
C - 105	SEPTIC TANK REPLACEMENT	10-02-C-61-0

SHEET NO.	SHEET TITLE	DPW FILE NO.
P - 001	PLUMBING SYMBOLS, ABBREVIATIONS & NOTES	10-02-P-62-0
P - 101	CART STORAGE SHED -- PLUMBING DEMOLITION PLAN	10-02-P-63-0
P - 102	BATHROOM & LOCKERS -- PLUMBING DEMOLITION PLAN	10-02-P-64-0
P - 201	CART STORAGE SHED -- PLUMBING NEW WORK PLAN	10-02-P-65-0
P - 202	BATHROOM & LOCKERS -- PLUMBING NEW WORK PLAN	10-02-P-66-0
P - 601	PLUMBING SCHEDULES	10-02-P-67-0
P - 701	PLUMBING DETAILS 1 OF 2	10-02-P-68-0
P - 702	PLUMBING DETAILS 2 OF 2	10-02-P-69-0
M - 001	MECHANICAL SYMBOLS, ABBREVIATIONS & NOTES	10-02-M-70-0
M - 201	CART STORAGE SHED -- MECHANICAL NEW WORK PLAN	10-02-M-71-0
M - 202	BATHROOM & LOCKERS -- MECHANICAL NEW WORK PLAN	10-02-M-72-0
M - 601	MECHANICAL SCHEDULES	10-02-M-73-0
M - 701	MECHANICAL DETAILS 1 OF 2	10-02-M-74-0
M - 702	MECHANICAL DETAILS 2 OF 2	10-02-M-75-0
E - 001	ELECTRICAL SYMBOLS, ABBREVIATIONS & NOTES	10-02-E-76-0
E - 002	ELECTRICAL NOTES	10-02-E-77-0
E - 010	ELECTRICAL SITE DEMOLITION PLAN	10-02-E-78-0
E - 020	ELECTRICAL NEW WORK SITE PLAN	10-02-E-79-0
E - 101	CART STORAGE SHED -- ELEC. DEMOLITION PLAN	10-02-E-80-0
E - 102	BATHROOM & LOCKERS -- ELEC. DEMOLITION PLAN	10-02-E-81-0
E - 201	CART STORAGE SHED -- ELEC. LIGHTING PLAN	10-02-E-82-0
E - 202	BATHROOM & LOCKERS -- ELEC. LIGHTING PLAN	10-02-E-83-0
E - 301	CART STORAGE SHED -- ELEC. NEW WORK PLAN	10-02-E-84-0
E - 302	BATHROOM & LOCKERS -- ELEC. NEW WORK PLAN	10-02-E-85-0
E - 401	CART STORAGE SHED -- FIRE ALARM NEW WORK PLAN	10-02-E-86-0
E - 402	BATHROOM & LOCKERS -- FIRE ALARM NEW WORK PLAN	10-02-E-87-0
E - 501	ELECTRICAL ONE-LINE DIAGRAM	10-02-E-88-0
E - 502	FIRE ALARM RISER DIAGRAM	10-02-E-89-0
E - 601	ELECTRICAL SCHEDULES	10-02-E-90-0
E - 701	ELECTRICAL DETAILS	10-02-E-91-0
E - 702	ELECTRICAL DETAILS	10-02-E-92-0

PROJECT INFORMATION	
CLIENT:	PARKS DEPT.: WESTCHESTER COUNTY DEPARTMENT OF PUBLIC WORKS & TRANSPORTATION
NAME & ADDRESS:	MOHANSIC GOLF COURSE, YORKTOWN, NEW YORK
TYPE OF WORK:	NEW GOLF CART STORAGE FACILITY AND CLUBHOUSE UPGRADES
DESCRIPTION:	DEMOLISH THE ENTIRE EXISTING CART STORAGE SHED. CONSTRUCT NEW SLAB, DRIVEWAY & PRE-FABRICATED METAL BUILDING. CART STORAGE BLDG. SHALL HAVE: STONE BASE BAND, WOOD CLAPBOARD, SLATE ROOF, WINDOWS & GARAGE DOORS. BATHROOM IS RENOVATED WITH NEW LAYOUT, FIXTURES, SHOWERS & LOCKERS.
CONSTRUCTION CODES	
TYPE	APPLICABLE CODES
BUILDING	2015 IBC - INTERNATIONAL BUILDING CODE*
PLUMBING	2015 IPC - INTERNATIONAL PLUMBING CODE*
MECHANICAL	2015 IMC - INTERNATIONAL MECHANICAL CODE*
ELECTRICAL	2015 NEC - NATIONAL ELECTRICAL CODE*
FIRE PROTECTION	2015 IFP - INTERNATIONAL FIRE CODE*
ENERGY	2015 IECC - INTERNATIONAL ENERGY CONSERVATION CODE*
EXISTING BUILDING	2015 IBC - INTERNATIONAL EXISTING BUILDING CODE*
RESIDENTIAL	2015 IRC - INTERNATIONAL RESIDENTIAL CODE*
FUEL GAS	2015 IFGC - INTERNATIONAL FUEL GAS CODE*
PROPERTY	2015 IPMC - INTERNATIONAL PROPERTY MAINTENANCE CODE*
* ALL CODES AS ADOPTED BY NEW YORK STATE WITH APPLICABLE STATE & LOCAL AMENDMENTS	

CODE DATA				
CATEGORY	REQUIREMENT	CODE REF.	PROVIDED	REMARKS
CONSTRUCTION TYPE	I-B	TABLE 601	TABLE 601	
USE GROUP	S-1	SEC. 311.2	SEC. 311.2	
ALLOWABLE AREA	UNLIMITED	TABLE 503	TABLE 503	
ALLOWABLE HEIGHT	11 STORIES			
OCCUPANT LOAD	NA			
NUMBER OF EXITS	NA			
DISTANCE TO EXIT	NA			
EXIT WIDTH	NA			
FIRE SEPARATION	NA			
FINISHES				
EXIT CORRIDORS	NA			
EXIT PASSAGE	NA			
ROOMS	NA			
FLOORS	NA			

ENERGY CODE NOTE:  
THE GOLF CART STORAGE FACILITY IN THIS PROJECT COMPRISES A NEW STORAGE FACILITY THAT IS SEASONAL USE ONLY & AS SUCH AN 'UN-CONDITIONED' STRUCTURE. THE BATHROOM UPGRADES COMPRISE IMPROVEMENTS TO LAYOUT, FIXTURES, SHOWERS & LOCKERS WITHIN THE EXISTING BUILDING. THERE ARE NO ALTERATIONS TO THE EXISTING BUILDING THERMAL ENVELOPE.

OCCUPANCY			
TOTAL AREA	NA		
CALCULATIONS			
NA = NOT APPLICABLE FOR PROJECT			
ZONING: TOWN OF YORKTOWN			
SECTION	BLOCK	LOT	
ZONING DISTRICT: R1-180 (WESTCHESTER COUNTY)			
ZONING ITEM	REQUIRED	EXISTING	PROPOSED
LOT AREA	NA		
LOT FRONTAGE	NA		
FRONT YARD	NA		
REAR YARD	NA		
SIDE YARD (ONE SIDE)	NA		
SIDE YARD (TWO SIDES)	NA		
HEIGHT	NA		
BUILDING AREA	NA		
SITE COVERAGE	NA		
FAR (FLOOR AREA RATIO)	NA		
ENERGY CODE COMPLIANCE			
PER IECC 811.1 ALTERATIONS SHALL CONFORM TO THE ENERGY REQUIREMENTS OF THE IECC AS THEY RELATE TO NEW CONSTRUCTION ONLY.			
NEW YORK STATE CLIMATE ZONE: 4 - PER EECCHYS-2016 COMMERCIAL PRESCRIPTIVE TABLE C402.1.3 BUILDING IS NON-CONDITIONED, SEASONAL USE ONLY.			

		OLA Consulting Engineers 50 Broadway Hawthorne New York 10532 914.747.2800 ola.com		HILLMAN & MILEY CONSULTING ENGINEERS, PLLC 235 Mamaroneck Avenue White Plains, NY 10605 914-428-0709	
REVISION NUMBER	DATE	MADE BY	APP'D BY	REVISION	
RECORD DRAWING CERTIFICATION					
<input type="checkbox"/> AS BUILT - CHANGES AS NOTED <input type="checkbox"/> AS BUILT - NO CHANGES					
CONTRACTOR NAME: _____ SIGNATURE: _____ TITLE: _____			PROJECT COORDINATOR NAME: _____ SIGNATURE: _____ TITLE: _____		
WESTCHESTER COUNTY, NEW YORK DEPARTMENT OF PUBLIC WORKS DIVISION OF ENGINEERING					
NEW GOLF CART STORAGE FACILITY AND CLUBHOUSE UPGRADES MOHANSIC GOLF COURSE, YORKTOWN, NEW YORK TITLE, INDEX TO THE DRAWINGS					
CONTRACT NUMBER 17-539		SHEET NUMBER 1-100		SHEET NO. 1 OF 59	
SCALE: DATE: 6/4/21		DPW FILE NO. 10-02-T-34		REV. NO. 0	

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IN CHARGE OF: ADAM KAPLINSKI, R.A.  
CHECKED BY: ADAM KAPLINSKI, R.A.  
MADE BY: JOHN W. LEVY, R.A.


ADAM KAPLINSKI, R.A.  
ASSOCIATE ARCHITECT  
DEPARTMENT OF PUBLIC WORKS  
& TRANSPORTATION

GAYLE KATZMAN, P.E.  
FIRST DEPUTY COMMISSIONER  
DEPARTMENT OF PUBLIC WORKS  
& TRANSPORTATION

KATHLEEN M. O'CONNOR  
COMMISSIONER  
DEPARTMENT OF PARKS, RECREATION  
& CONSERVATION

HUGH J. GREECHAN JR., P.E.  
COMMISSIONER  
DEPARTMENT OF PUBLIC WORKS  
& TRANSPORTATION



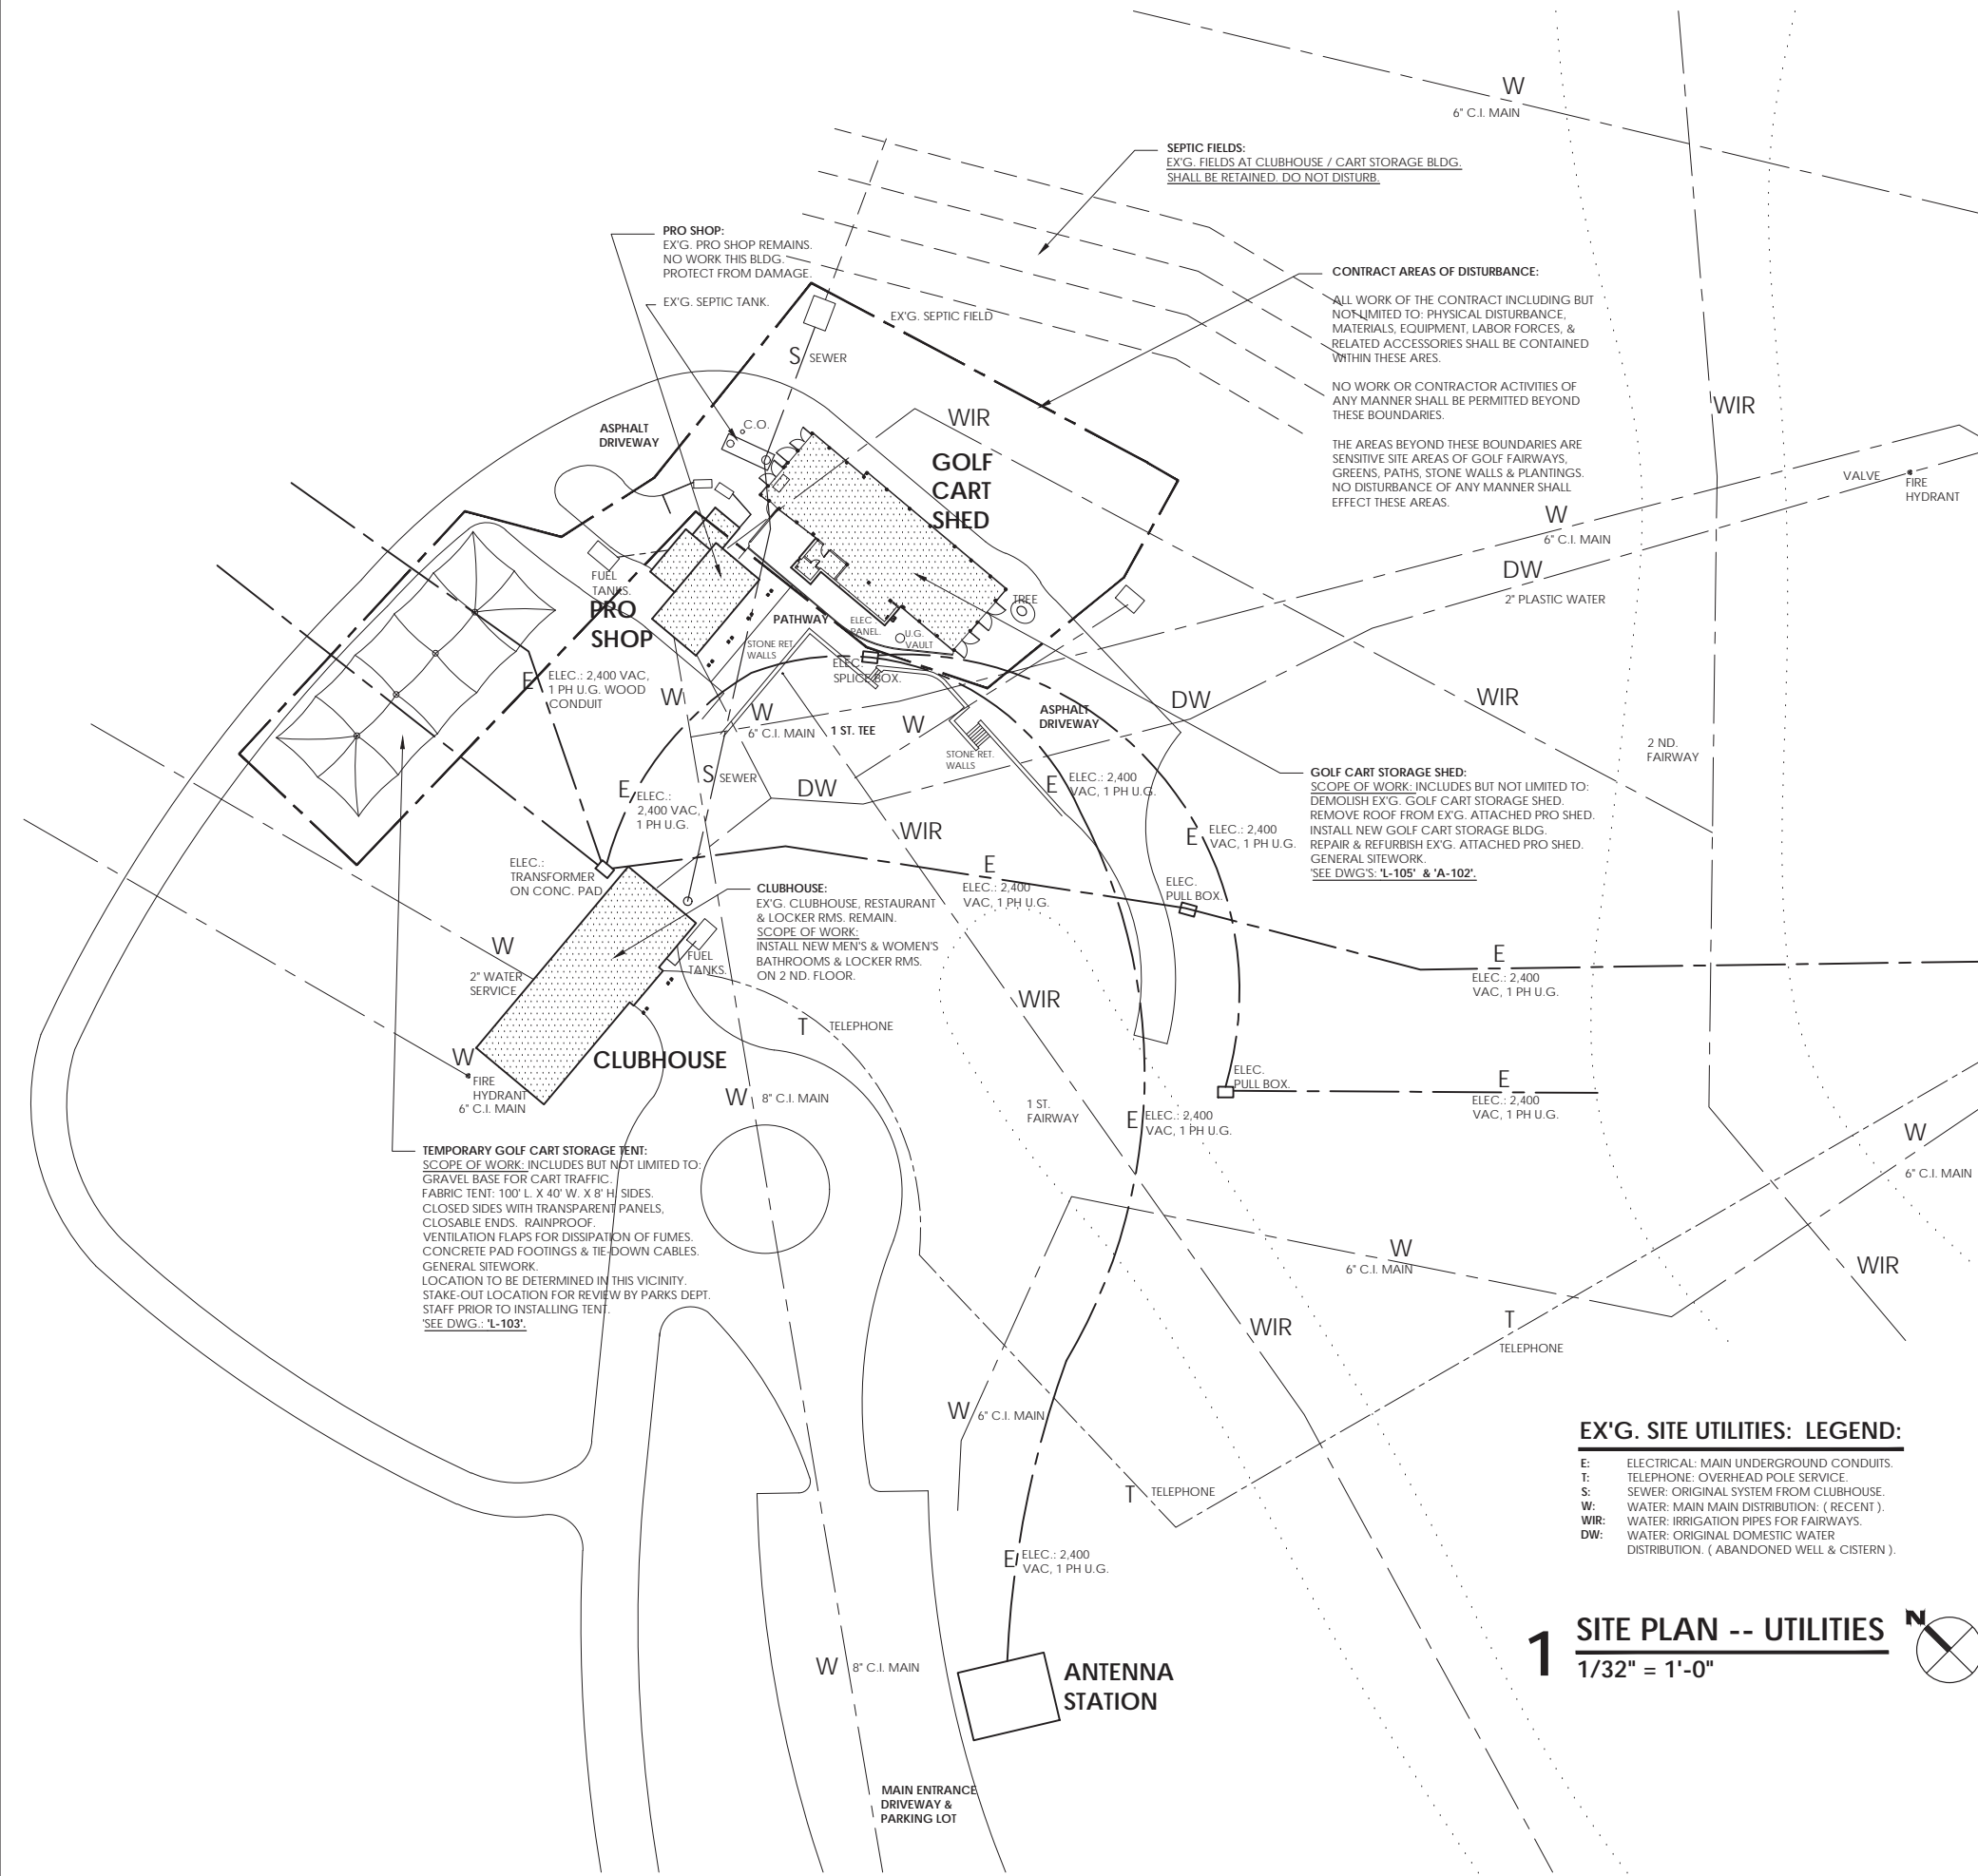

TOPOGRAPHIC ELEVATION NOTE:


TOPOGRAPHIC ELEVATIONS SHOWN ON THE TEST BORING PLANS ARE BASED ON INFORMATION DERIVED FROM PRIOR TOPOGRAPHIC SURVEY PLANS, THAT PRE-DATE RECENT SURVEYS.

REFER TO: SITE & STAGING PLANS: 'L-102' & 'L-103' FOR CURRENT TOPOGRAPHIC SURVEY INFORMATION.

GENERAL CONTRACTOR SHALL PERFORM LIMITED NEW SURVEYS TO CONFIRM CRITICAL TOPOGRAPHIC ELEVATIONS & ESTABLISH BUILDING LOCATIONS.

(NOTE: BORINGS # 1, 2 & 3 WERE FOR OTHER AREAS OF THE FACILITY. ONLY BORING # 4 PERTAINS TO THIS CONTRACT SITE.)

SOILTESTING, INC. 90 DONOVAN RD. OXFORD, CT 06457 CT (203) 262-6328 NY (914) 946-4850		CLIENT: Busing Associates PROJECT NO: 0193-0495-16 PROJECT NAME: Mohansic Golf Club LOCATION: 1500 Baldwins Road Yorktown, NY	SHEET: 1_OF_1 HOLE NO. B-4 BORING LOCATIONS: per Plan
FORMER - DRILLER TPiden INSPECTOR:	TYPE: HSA SIZE (D): 4.5" HOLE DEPTH: 1.33" HOLE DEPTH: 1.33" HOLE DEPTH: 1.33"	SAMPLES: HSA DATE START: 8/8/16 DATE FINISH: 8/8/16 SURFACE ELEV.: 102' GROUND WATER ELEV.: 102'	FIELD IDENTIFICATION OF SOIL REMARKS (INC. COLOR, LOSS OF WASH WATER, BEANS IN ROCK, ETC.) 1-4' ASPHALT 5-10' FINE SAND, 10-15' F. gravel, 1 weathered rock 15-20' partially weathered BEDROCK 20-25' White Tan partially weathered BEDROCK 25-30' Gray Tan partially weathered BEDROCK 30-35' AUGER REFUSAL 35-40' E.O.B. 100'
NOTE: Subsoil conditions revealed by this investigation represent conditions at specific locations and may not represent conditions at other locations or times.			
GROUND SURFACE TO: USED: T = TRENCH, V = VANE TEST A = AUGER, SP = SPHERICAL PENETROMETER W = WEIGHT OF RODS HSA = HOLLOW STEM AUGER PROPORTIONS LISTED: GRADE = 0 - 10%, LITTLE = 10 - 20%, SOME = 20 - 30%, AND = 30 - 50%		C = COARSE M = MEDIUM F = FINE	

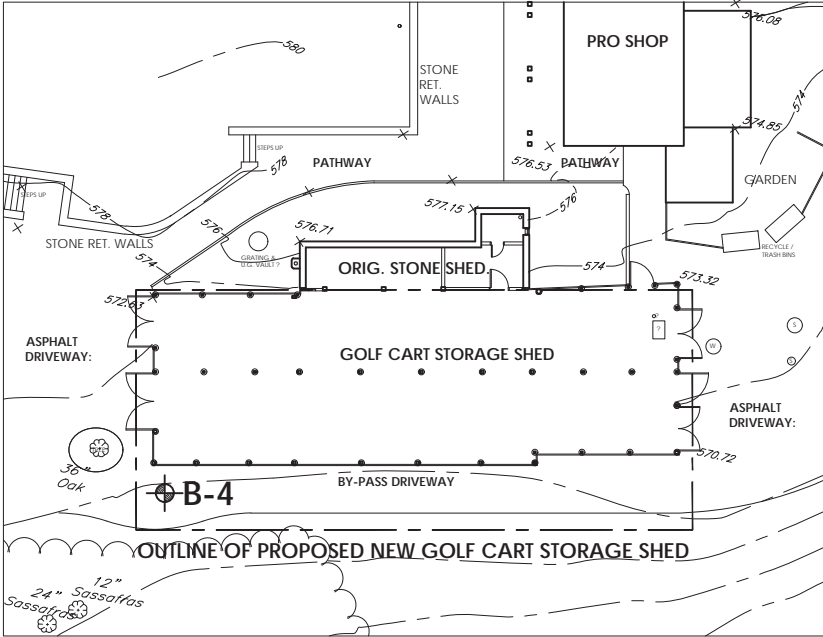

GOLF CART STORAGE SHED BORING LOCATION  
1  
1/16" = 1'-0"



EX'G. SITE UTILITIES: LEGEND:

- E: ELECTRICAL: MAIN UNDERGROUND CONDUITS.
- T: TELEPHONE: OVERHEAD POLE SERVICE.
- S: SEWER: ORIGINAL SYSTEM FROM CLUBHOUSE.
- W: WATER: MAIN MAIN DISTRIBUTION: ( RECENT ).
- WIR: WATER: IRRIGATION PIPES FOR FAIRWAYS.
- DW: WATER: ORIGINAL DOMESTIC WATER DISTRIBUTION. ( ABANDONED WELL & CISTERN ).


1 SITE PLAN -- UTILITIES  
1/32" = 1'-0"



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CHECKED BY ADAM KAPLINSKI RA  
MADE BY JOHN W. LEVY RA

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REVISION NUMBER	DATE	MADE BY	APP'D BY	REVISION
RECORD DRAWING CERTIFICATION				
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CONTRACTOR		PROJECT COORDINATOR		
NAME	SIGNATURE	NAME	SIGNATURE	DATE
TITLE	DATE	TITLE	DATE	DATE
WESTCHESTER COUNTY, NEW YORK DEPARTMENT OF PUBLIC WORKS DIVISION OF ENGINEERING				
NEW GOLF CART STORAGE FACILITY AND CLUBHOUSE UPGRADES MOHANSIC GOLF COURSE, YORKTOWN, NEW YORK SITE PLAN -- EXISTING UTILITIES, TEST BORING				
CONTRACT NUMBER 17-539	SHEET NUMBER L-101	SHEET NO. 3 OF 59		
SCALE: 1/32" = 1'-0"		DATE: 6/4/21		
DPW FILE NO. 10-02-L-36		REV. NO. 0		

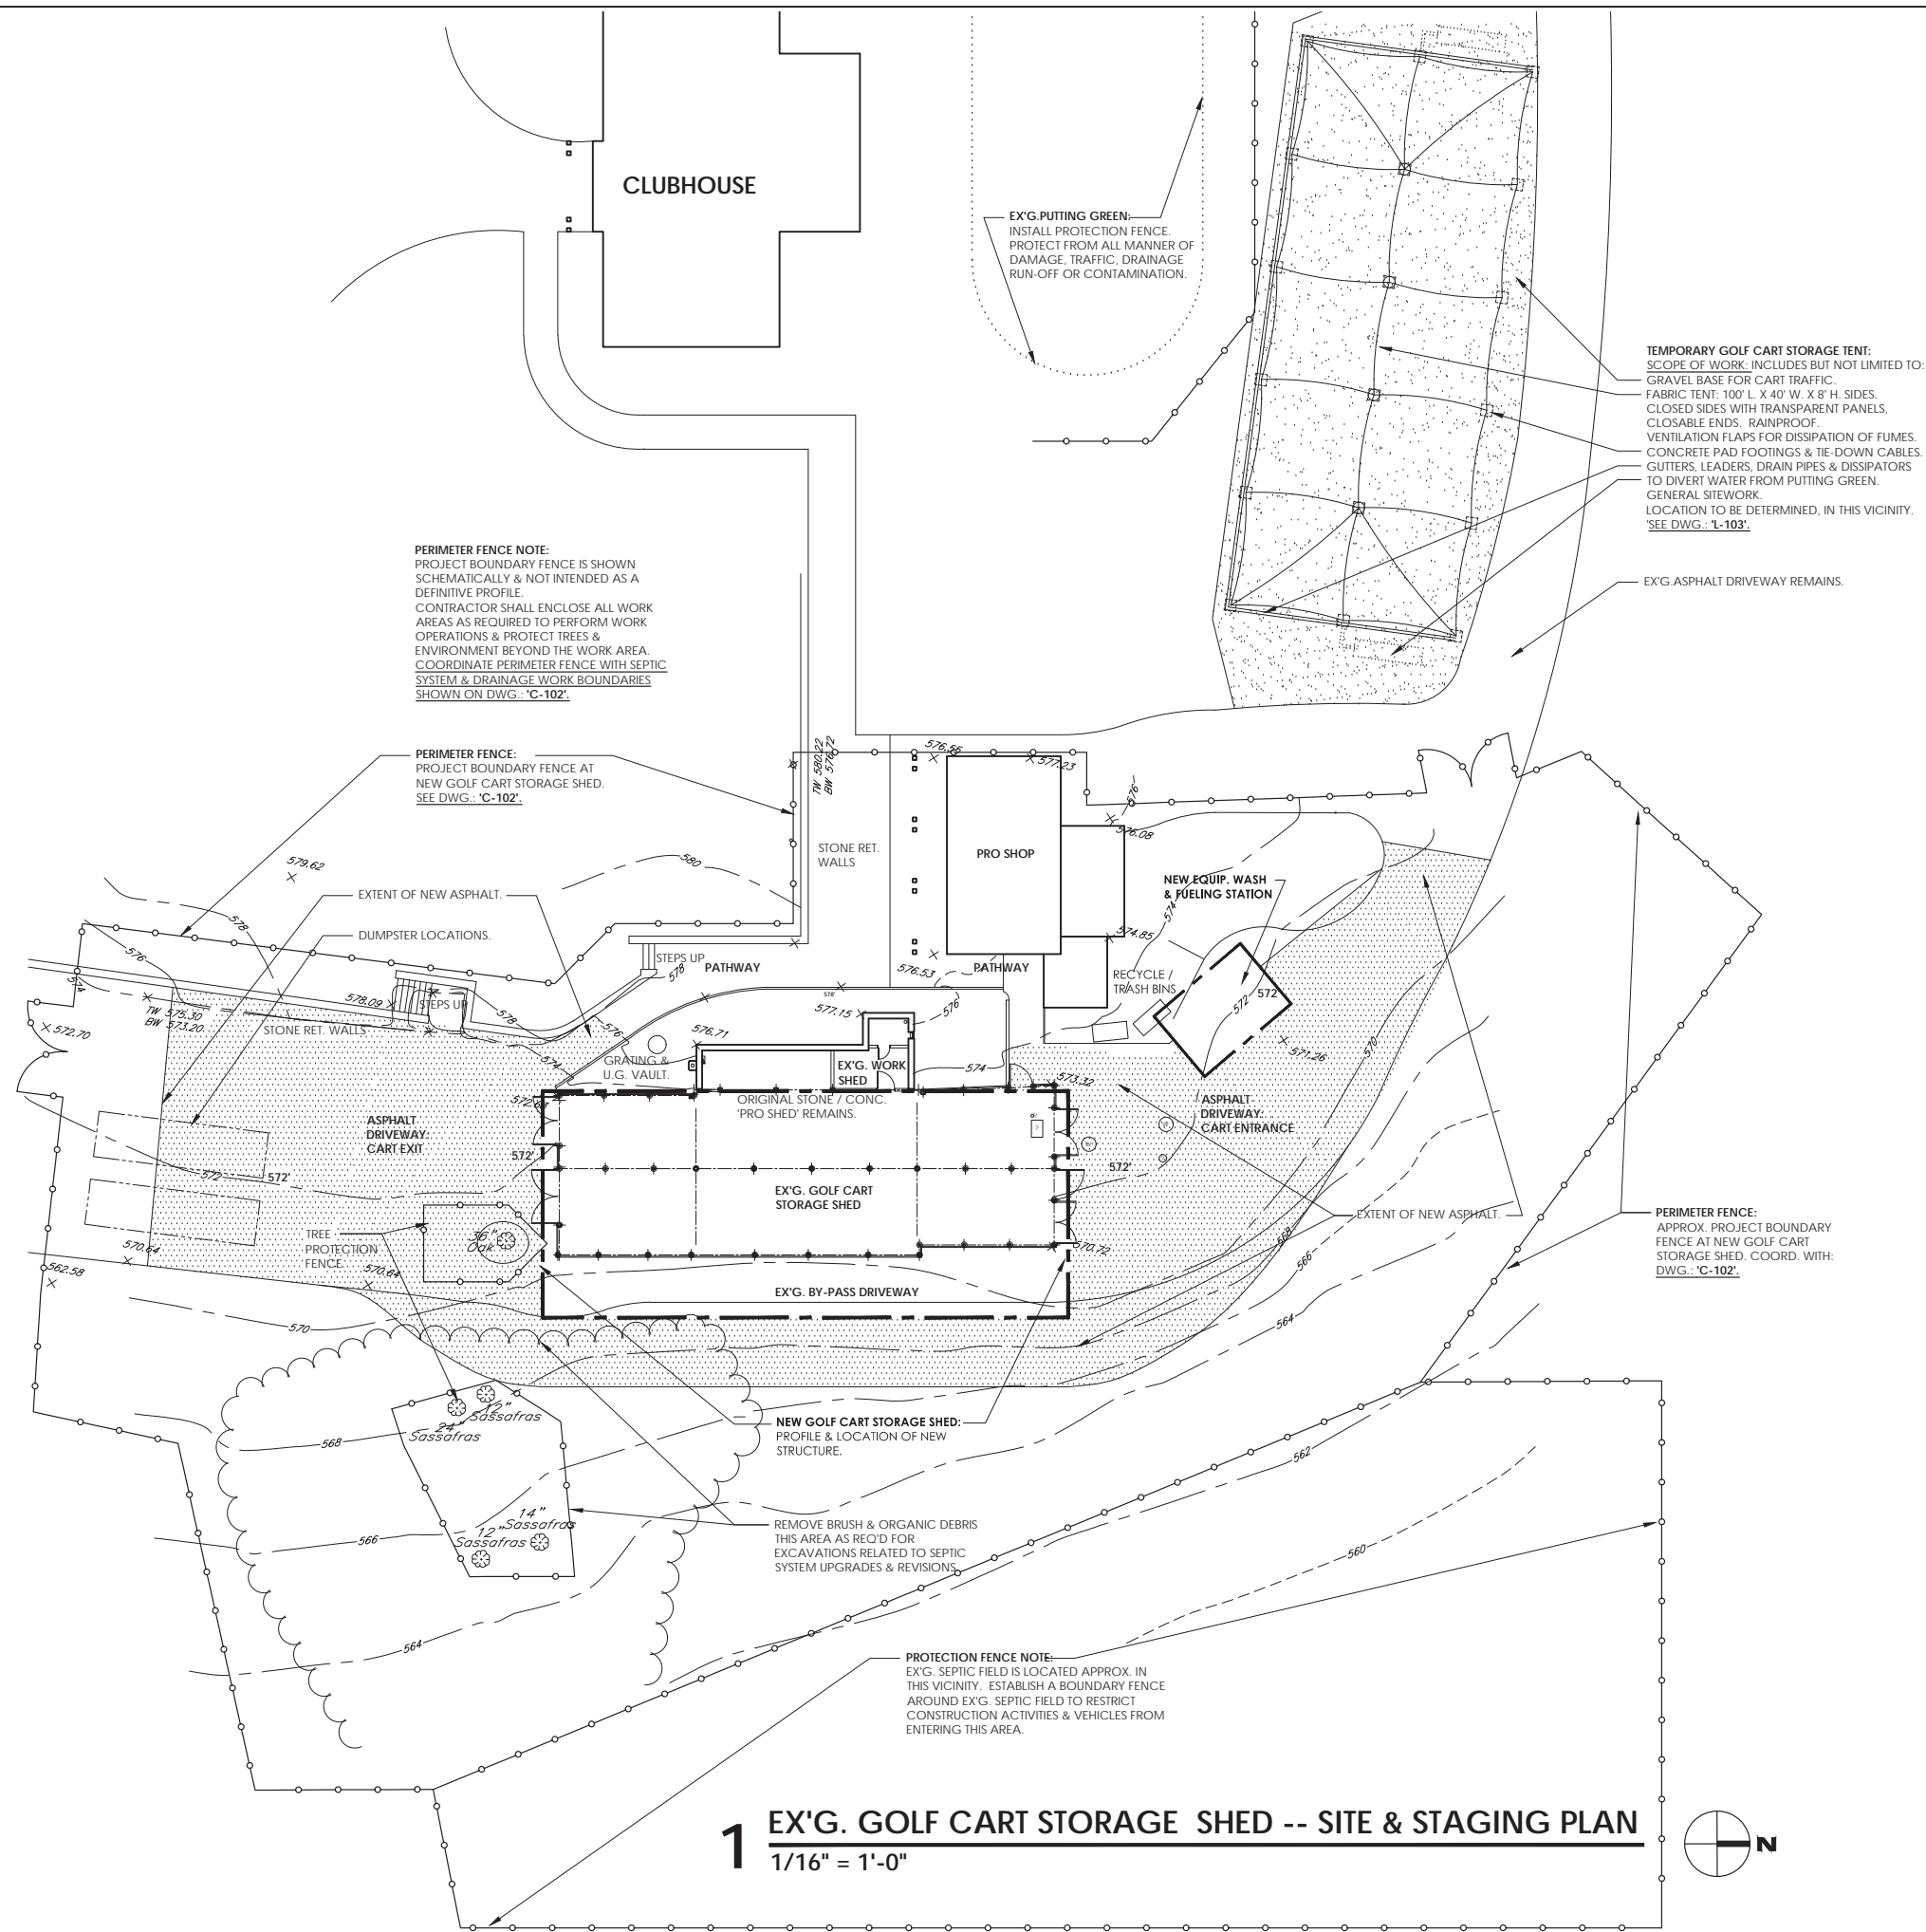

**1 EX'G. GOLF CART STORAGE SHED -- SITE & STAGING PLAN**  
1/16" = 1'-0"

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MADE BY JOHN W. LEVY RA

**LEGAL NOTICE:**  
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WRITTEN DIMENSIONS ON THIS DRAWING SHALL HAVE PRECEDENCE OVER SCALED DIMENSIONS AND CONDITIONS ON THE JOB. THIS OFFICE MUST BE NOTIFIED OF ANY VARIATIONS FROM DIMENSIONS AND CONDITIONS SHOWN BY THESE DRAWINGS. SHOP DETAILS MUST BE SUBMITTED TO THIS OFFICE FOR APPROVAL BEFORE PROCEEDING WITH FABRICATION.

**SITE & STAGING NOTES:**

REFER TO GENERAL CONDITIONS & SITE SPECIFIC REQUIREMENTS FOR SAFETY & SECURITY OF WORK AREAS & PUBLIC SPACES.

**WORK AREA BOUNDARY:**

1. ALL WORK & EQUIPMENT SHALL BE CONTAINED WITHIN THE PERIMETER FENCE.
2. REVIEW OTHER REQUIRED WORK AREAS WITH OWNER IN ADVANCE.

**PERIMETER FENCE:**

1. INSTALL 8'-0" CHAIN LINK FENCE ENCLOSING ALL WORK AREAS.
2. CHAIN LINK FENCE SHALL BE DARK GREEN VINYL COATED.
3. INSTALL GREEN PCV NEEDLE 'HEDGELINK' PRIVACY INSERTS IN ENTIRE FENCE AREA & GATES.
4. ASSURE POSITIVE SEPARATION FROM WORK AREA TO PUBLIC AREAS.
5. INSTALL VEHICULAR & PERSONNEL GATES WHERE REQUIRED FOR THE WORK.

**SECURITY:**

1. MAINTAIN ALL GATES & ACCESS TO WORK AREAS IN A LOCKED POSITION TO RESTRICT UNAUTHORIZED ACCESS INTO WORK AREA.
2. DURING ACCESS OPERATIONS & MATERIAL MOVEMENT INTO THE WORK AREA, ESTABLISH PERSONNEL MONITORS TO PROTECT THE PUBLIC.
3. COORDINATE SCHEDULE OF OPERATIONS & MOVEMENTS 2 DAYS IN ADVANCE WITH MONITORS.

**ACTIVE DRIVEWAYS:**

1. DRIVEWAYS & PARKING AREAS ARE IN USE AT ALL TIMES.
2. ARRANGE TRUCK & DELIVERY TRAFFIC TO CREATE A MINIMUM OF DISTURBANCE TO DRIVEWAYS & PARKING.
3. NOTIFY OWNER 2 DAYS IN ADVANCE OF POTENTIAL VEHICULAR OBSTRUCTIONS TO DRIVEWAYS & PARKING.

**GENERAL PROTECTIONS:**

1. ASSURE FULL PROTECTION OF PUBLIC SAFETY AT ALL TIMES, DAY & NIGHT.
2. PROTECT EX'G. PROPERTY FROM DAMAGE DUE TO WORK OR RELATED OPERATIONS.
3. PROTECT TREES, SHRUBS, PATHS & CURBS FROM DAMAGE.
4. ITEMS DAMAGED AS A CONSEQUENCE OF THE WORK SHALL BE REPAIRED OR REPLACED BY THE CONTRACTOR AS PART OF THE SCOPE OF THE CONTRACT.
5. REVIEW ALL CONDITIONS & POTENTIAL DAMAGE TO PROPERTY WITH THE OWNER'S REPRESENTATIVE PRIOR TO COMMENCING WORK.

**GENERAL SITEWORK REVIEW NOTE:**

REVIEW ALL SITE DISTURBANCE IN THE FIELD PRIOR TO PERFORMING ANY SITE MOBILIZATION OR OPERATIONS.  
REVIEW PROPOSED METHODS, EQUIPMENT, MATERIALS & EXTENTS WITH ARCH., CIVIL ENGINEER & OWNER PRIOR TO OCCUPYING SITE.  
MAINTAIN POSITIVE BOUNDARY FENCE A MIN. 50' CLEAR OF ALL FAIRWAYS AT ALL TIMES.

**TREE PROTECTIONS & REMOVALS:**


**TREE PROTECTIONS:**  
EX'G. TREES SHALL REMAIN UNLESS SPECIFICALLY NOTED FOR REMOVAL.  
REVIEW EXTENT OF ALL EXCAVATION & CONSTRUCTION ACTIVITIES & EQUIPMENT MOVEMENT IN VICINITY OF TREES.  
LAYOUT ALL BOUNDARIES IN FIELD WITH ARCH. PRIOR TO ANY WORK.  
PROTECT ALL TREES WITHIN THE CONSTRUCTION BOUNDARY TO REMAIN.  
ENCLOSE TREES IN A BARRIER FENCE UP TO THE DRIP LINE TO PROTECT GROUND ROOTS.  
REVIEW ALL TREE PROTECTIONS WITH ARCH. & OWNER PRIOR TO ANY WORK.

**TREE REMOVALS:**  
REVIEW PROCEDURE FOR REMOVALS WITH ARCH. & OWNER PRIOR TO WORK.  
ESTABLISH DIRECTION & EXTENT OF FALL, EXTENT OF DAMAGE TO ADJACENT TREES & PLANTINGS, & EXTENT OF GRADE DISTURBANCE TO PROCESS THE TREE FOR REMOVAL.  
REMOVE STUMP & ROOTS TO A DEPTH OF 4'-0".  
REMOVE ALL TRUNKS, BRANCHES, TWIGS, LEAVES, CHIPPINGS & OTHER REMNANTS OF THE TREE FROM THE SITE.

**TOPOGRAPHIC SURVEY NOTE:**

TOPOGRAPHIC SURVEY INFORMATION WAS FURNISHED BY:  
**WARD CARPENTER ENGINEERS, INC.**  
76 MAMARONECK AVE.  
WHITE PLAINS, NY 10601 914-949-6000  
SURVEYS WERE PREPARED: 2 / 14 / 17 & 2 / 31 / 17.

REVISION NUMBER	DATE	MADE BY	APP'D BY	REVISION
RECORD DRAWING CERTIFICATION				
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CONTRACTOR		PROJECT COORDINATOR		
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<b>WESTCHESTER COUNTY, NEW YORK DEPARTMENT OF PUBLIC WORKS DIVISION OF ENGINEERING</b>				CONTRACT NUMBER 17-539
NEW GOLF CART STORAGE FACILITY AND CLUBHOUSE UPGRADES MOHANSIC GOLF COURSE, YORKTOWN, NEW YORK EXIST. CART STORAGE SHED -- STAGING PLAN				SHEET NUMBER L-102
SCALE: 1/16" = 1'-0" DATE: 6 / 4 / 21				SHEET NO. 4 OF 59
DPW FILE NO. 10-02-L-37				REV. NO. 0

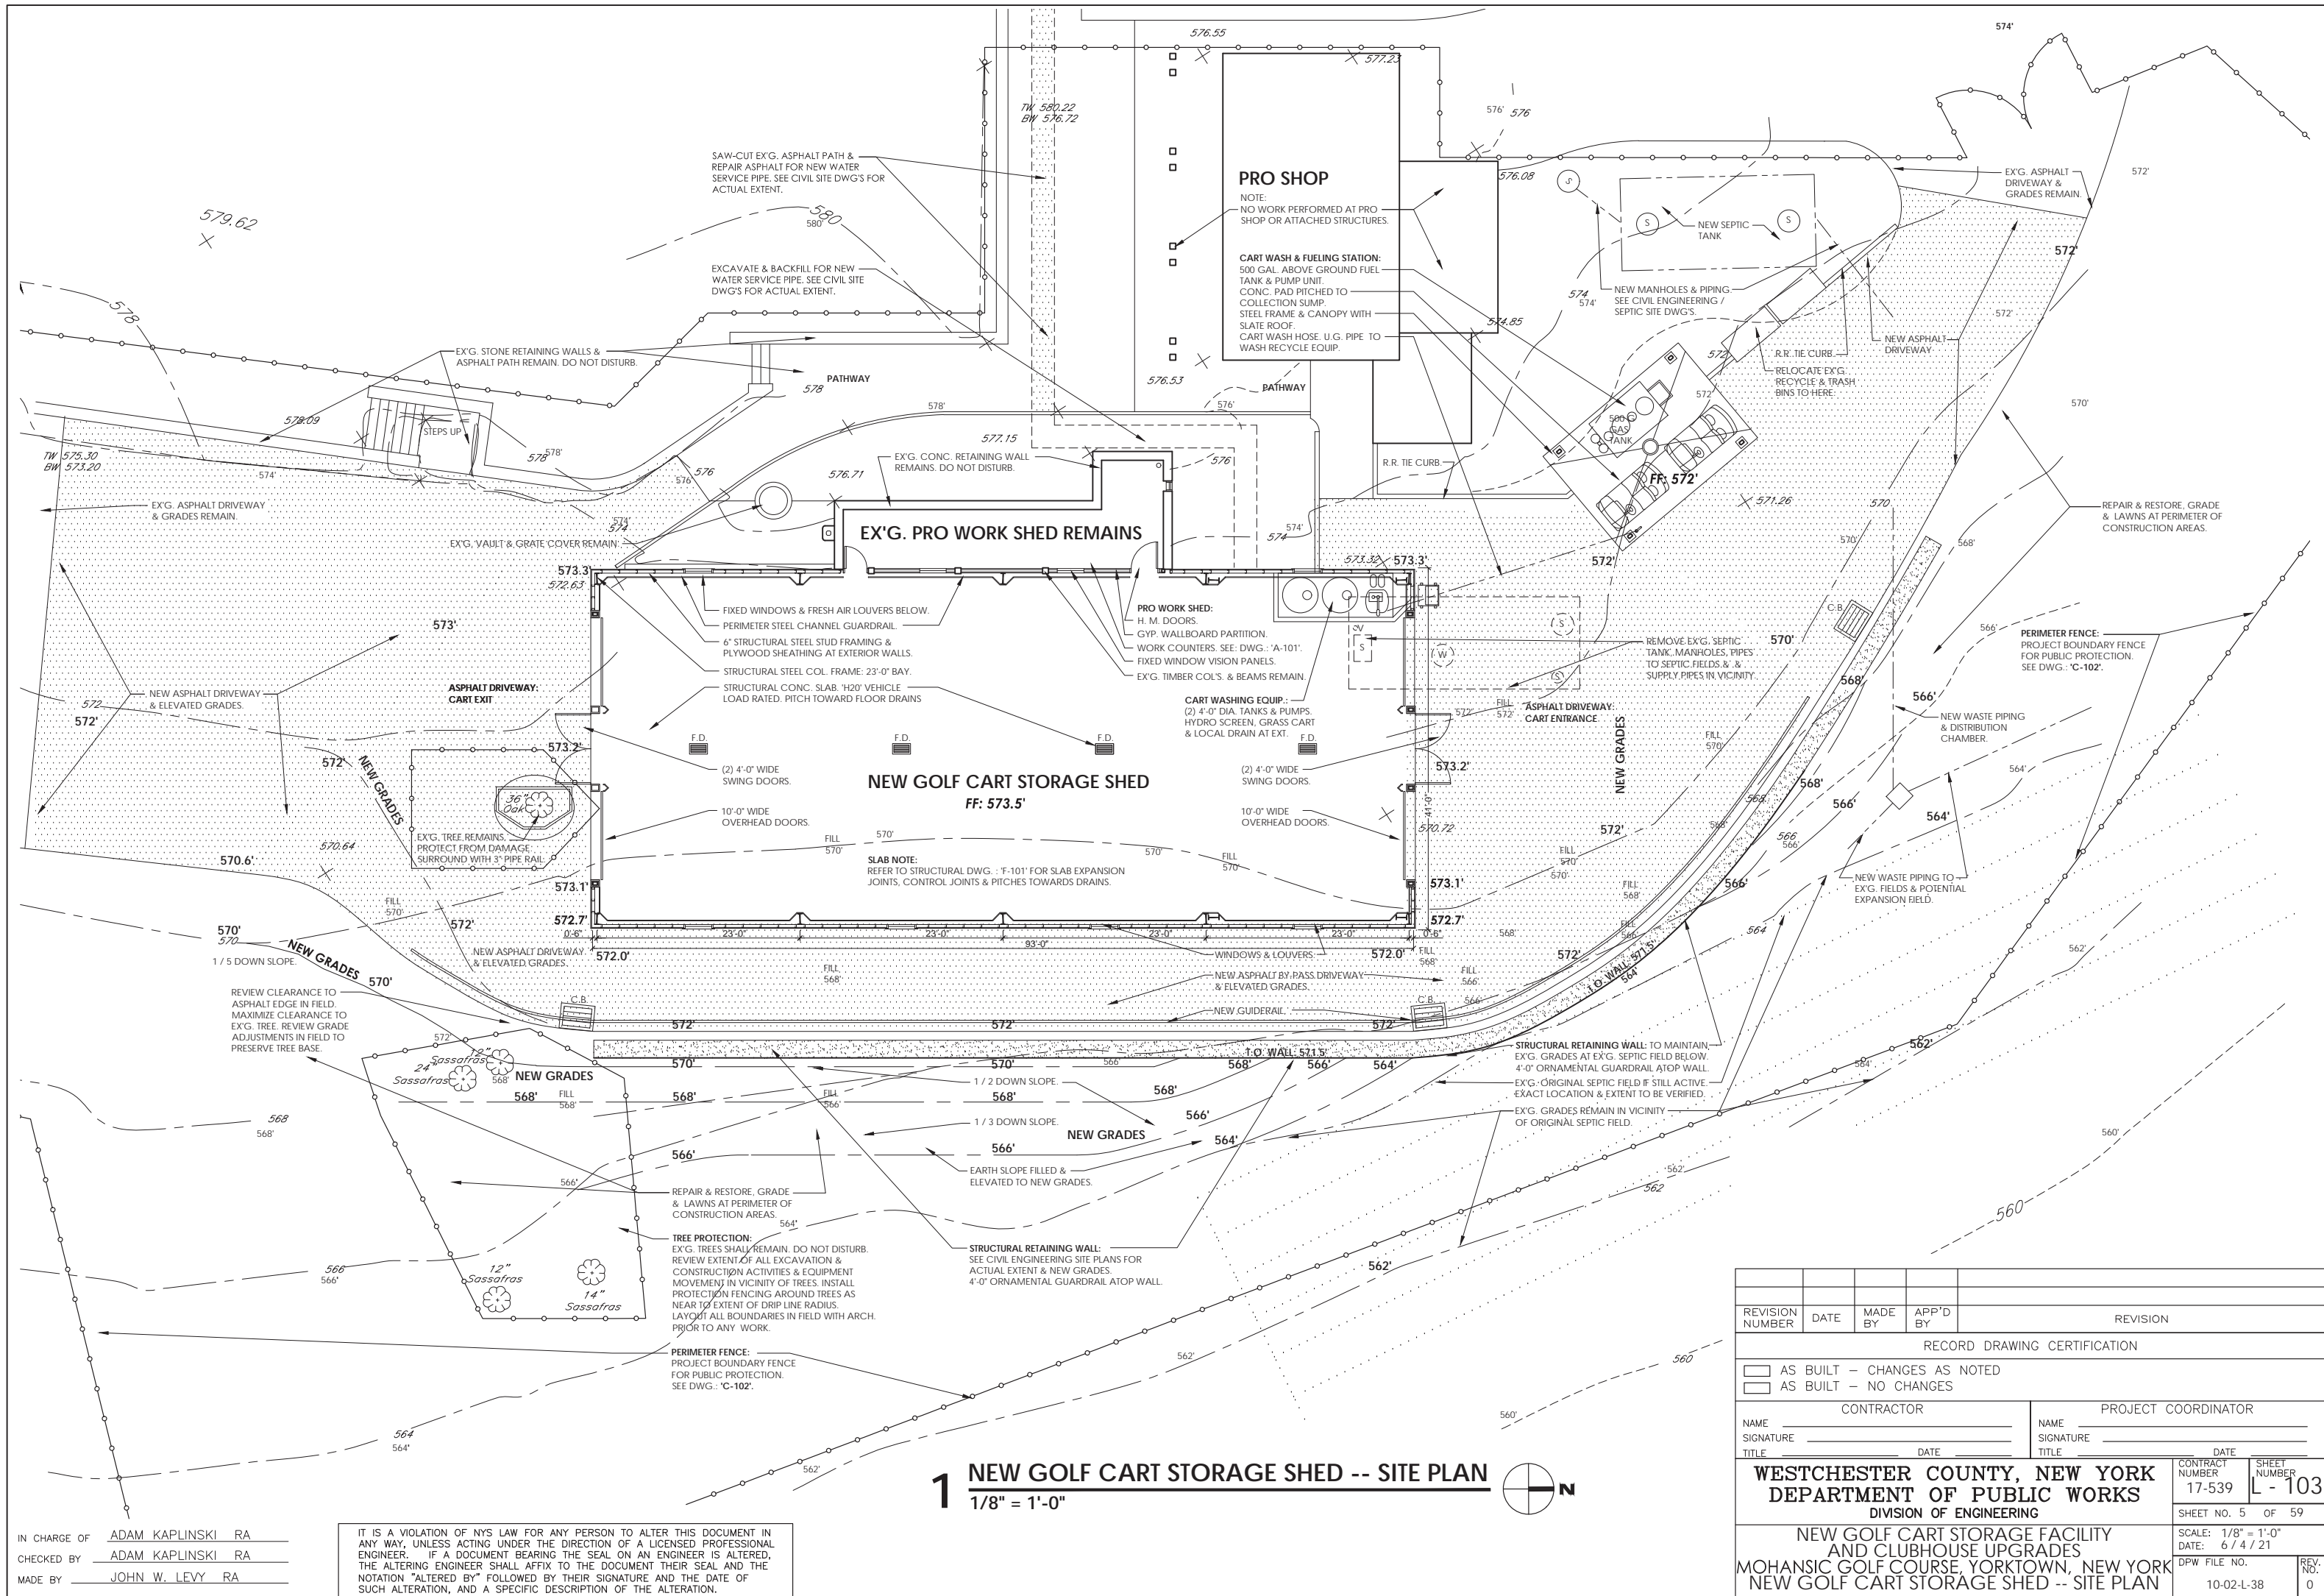

IN CHARGE OF ADAM KAPLINSKI RA  
CHECKED BY ADAM KAPLINSKI RA  
MADE BY JOHN W. LEVY RA


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# 1 NEW GOLF CART STORAGE SHED -- SITE PLAN

1/8" = 1'-0"




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CONTRACTOR			PROJECT COORDINATOR	
NAME SIGNATURE TITLE			NAME SIGNATURE TITLE	
DATE			DATE	
WESTCHESTER COUNTY, NEW YORK DEPARTMENT OF PUBLIC WORKS DIVISION OF ENGINEERING			SHEET NUMBER 17-539 L - 103	
NEW GOLF CART STORAGE FACILITY AND CLUBHOUSE UPGRADES MOHANSIC GOLF COURSE, YORKTOWN, NEW YORK NEW GOLF CART STORAGE SHED -- SITE PLAN			SHEET NO. 5 OF 59 SCALE: 1/8" = 1'-0" DATE: 6/4/21 DPW FILE NO. 10-02-L-38 REV. NO. 0	

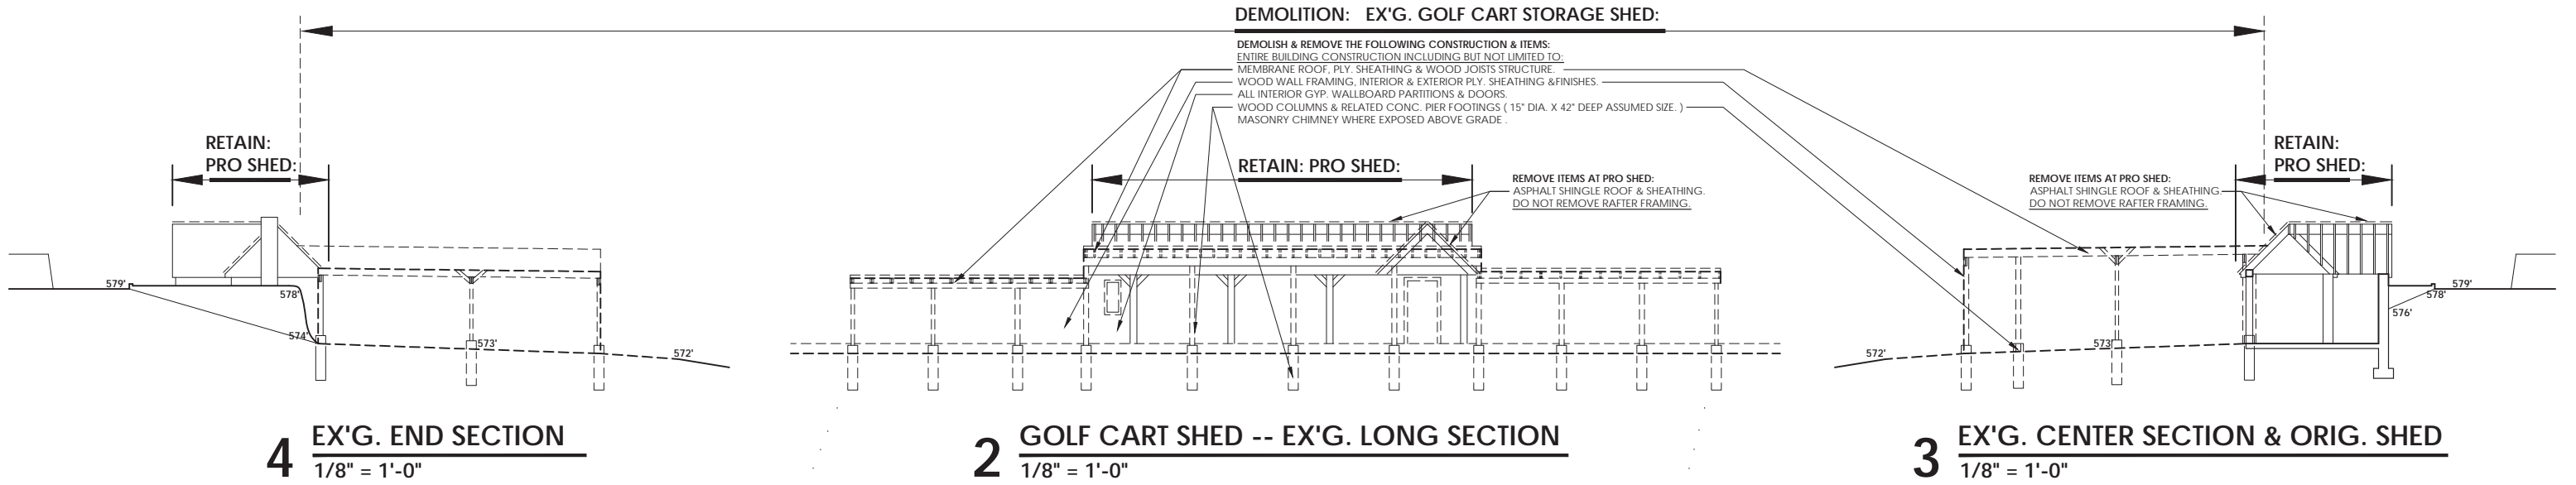

4 EX'G. END SECTION  
1/8" = 1'-0"

2 GOLF CART SHED -- EX'G. LONG SECTION  
1/8" = 1'-0"

3 EX'G. CENTER SECTION & ORIG. SHED  
1/8" = 1'-0"

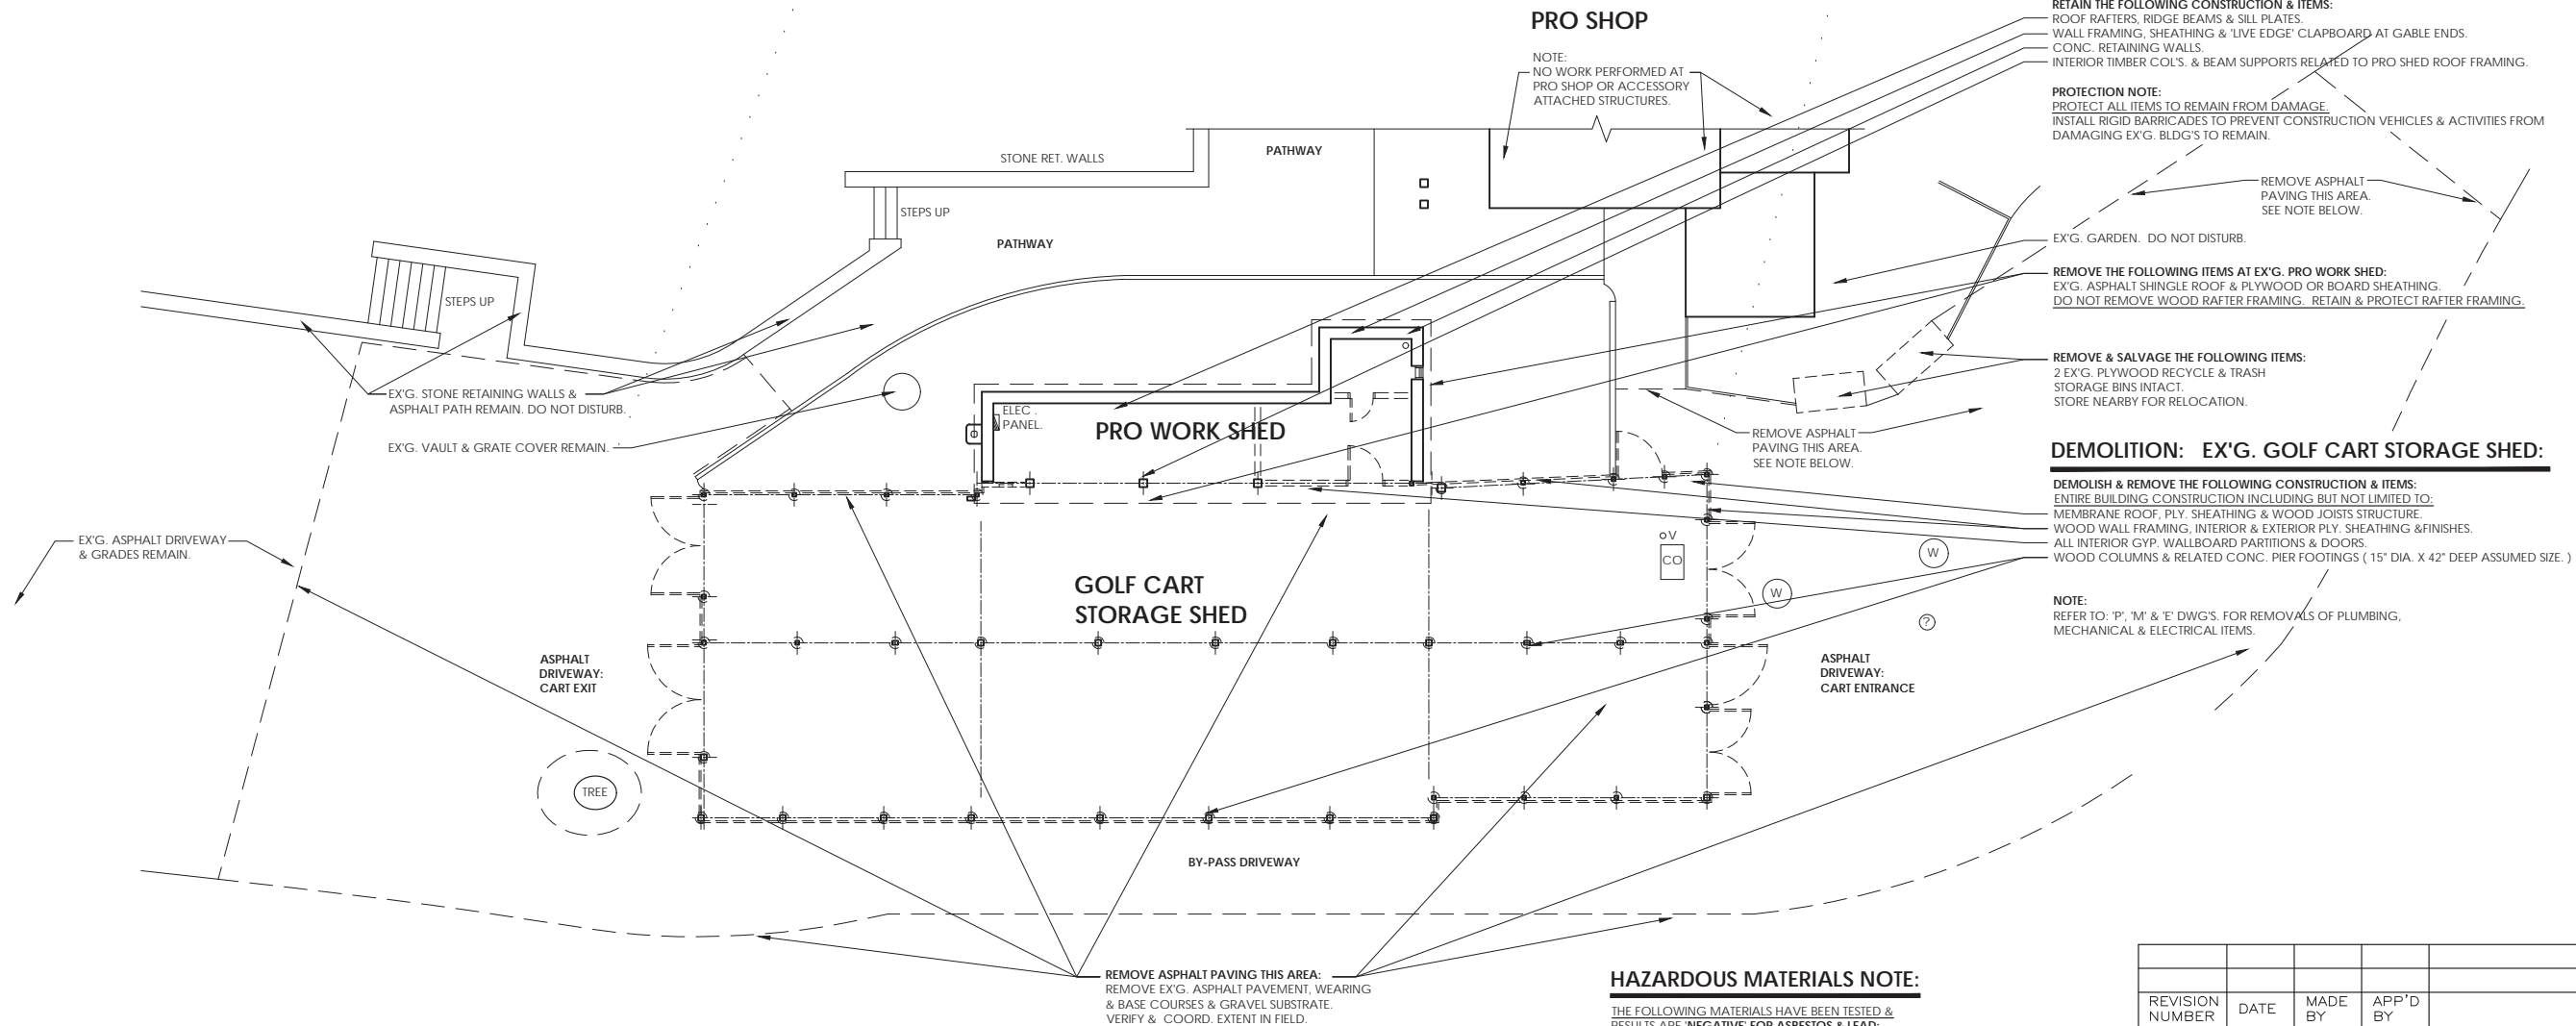


1 EX'G. GOLF CART SHED -- DEMOLITION PLAN  
1/8" = 1'-0"

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**HAZARDOUS MATERIALS NOTE:**  
THE FOLLOWING MATERIALS HAVE BEEN TESTED & RESULTS ARE **NEGATIVE** FOR ASBESTOS & LEAD:  
ASPHALT ROOF SHINGLES.  
SINGLE PLY MEMBRANE ROOFING.  
MEMBRANE ROOFING ADHESIVES.  
WINDOW GLAZING CAULKING.  
MORTAR & STUCCO.  
STAINS & PAINTS.  
SEALANTS.

REVISION NUMBER	DATE	MADE BY	APP'D BY	REVISION
RECORD DRAWING CERTIFICATION				
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NAME	SIGNATURE	NAME	SIGNATURE	DATE
TITLE	DATE	TITLE	DATE	DATE
WESTCHESTER COUNTY, NEW YORK DEPARTMENT OF PUBLIC WORKS DIVISION OF ENGINEERING				CONTRACT NUMBER 17-539
NEW GOLF CART STORAGE FACILITY AND CLUBHOUSE UPGRADES MOHANSIC GOLF COURSE, YORKTOWN, NEW YORK EXISTING CART STORAGE SHED -- DEMOLITION				SHEET NUMBER D-101
SCALE: 1/8" = 1'-0" DATE: 6 / 4 / 21				SHEET NO. 6 OF 59
DPW FILE NO. 10-02-D-39				REV. NO. 0



3 EX'G. CLUBHOUSE BATHRM. & LOCKERS -- SECTION DEMO  
1/4" = 1'-0"

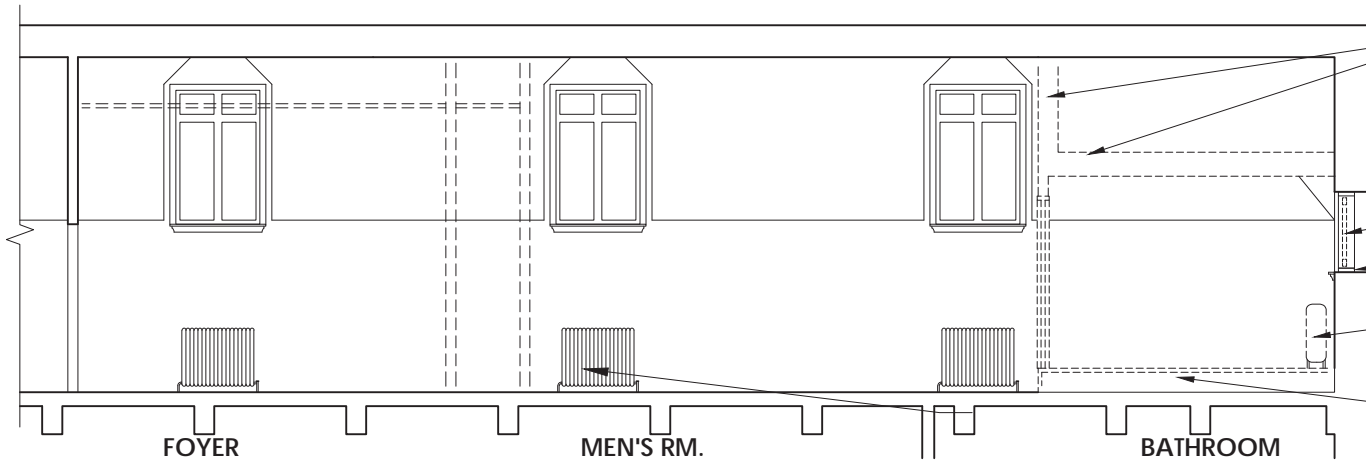
REMOVE FRONT WALL AT EX'G. BATHROOMS & SHOWERS.  
REMOVE RELATED CEILING & FRAMING.

**DEMOLITION NOTE:**  
PERFORM REMOVAL CAREFULLY & REVIEW PROCEDURE WITH PROJECT REPRESENTATIVE PRIOR TO ANY WORK. PERFORM SEVERAL TEST OPENINGS IN EX'G. WALLS PRIOR TO FULL DEMOLITION TO DETERMINE EX'G. METHOD OF ATTACHMENT TO THE EXTERIOR WALLS & ROOF OF THE CLUBHOUSE.


REMOVE (2) EX'G. QUARTER-ROUND WINDOW SASHES & GLAZING INTACT FROM PERIMETER FRAMES. SAW-CUT SASHES FROM FRAMES IF NECESSARY.  
EX'G. (2) QUARTER-ROUND PERIMETER FRAMES REMAIN.

REMOVE EX'G. STEAM RADIATORS.  
REMOVE EXTENSION PIPING AT RAISED RADIATORS.  
RETURN RADIATORS TO ORIGINAL POSITION ON EX'G. 2 ND. FLOOR OF BLDG.

REMOVE RAISED FLOOR, RELATED WALLS & FINISHES.  
SEE REMOVAL NOTE BELOW.

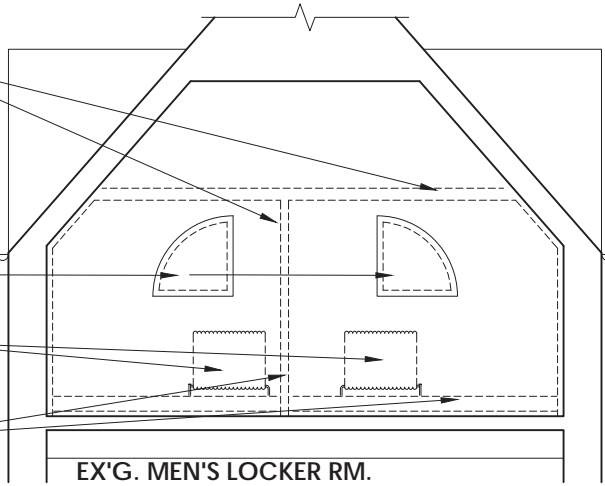

4 EX'G. BATHRMS. & SHOWERS -- SECTION  
1/4" = 1'-0"

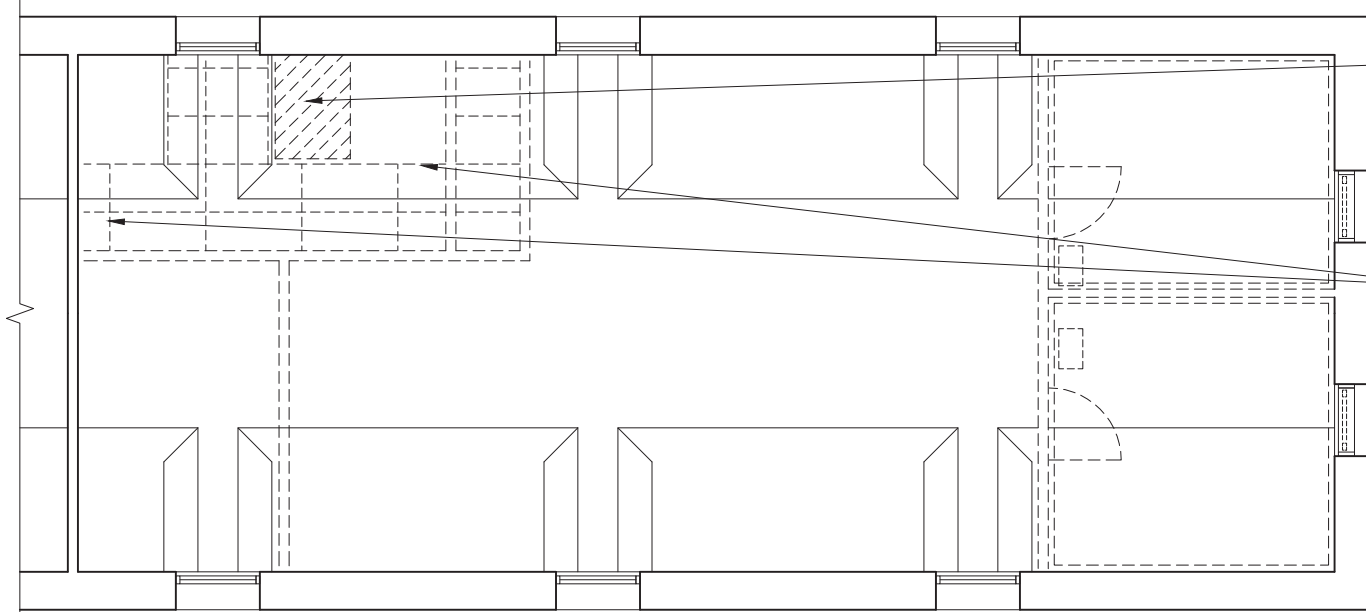

2 EX'G. CLUBHOUSE BATHRM. & LOCKERS -- CLG. DEMO  
1/4" = 1'-0"

**DEMOLITION: CEILINGS:**

**PLASTER CEILING DAMAGE NOTE:**  
REMOVE ALL SPALLED PLASTER & RELATED DAMAGED METAL LATH AT ROOF LEAK.  
SAW-CUT PLASTER TO NEAREST SOUND MATERIAL.  
RE-SUPPORT OR RE-FRAME METAL TO MAINTAIN CLG. INTEGRITY IN AREA OF REPAIR.


**ROOF LEAK REPAIR NOTE:**  
CONTRACTOR SHALL INVESTIGATE AREA OF SUSPECTED ROOF LEAK WITH ARCH.  
DETERMINE SOURCE OF ROOF LEAK & REVIEW REPAIR PROGRAM WITH ARCH.

**GRID CLG.:**  
REMOVE EX'G. SUSP. GRID & TILE CLG. IN STORAGE RM. & CLOSET.


**HAZARDOUS MATERIALS NOTE:**  
THE FOLLOWING MATERIALS HAVE BEEN TESTED & RESULTS ARE **'NEGATIVE' FOR ASBESTOS**:  
PLASTER, GYPSUM DRYWALL, COMPOUND, CAULK, CLG. TILES, CERAMIC TILE & GROUT.

THE FOLLOWING MATERIALS HAVE BEEN TESTED & RESULTS ARE **'POSITIVE FOR LEAD'**:  
PAINT AT WOOD INTERIOR.  
PAINT AT PLASTER INTERIOR.  
PAINT AT CONC. FLOOR.  
PAINT AT RADIATOR PIPING.

REMOVE PAINT COATINGS FROM CONC. FLOOR THIS ENTIRE FLOOR AREA IN PREPARATION FOR NEW FLOOR TILE FINISHES.  
DEMOLITION, REMOVAL & FLOOR PREPARATION ACTIVITIES SHALL BE PERFORMED IN ACCORDANCE WITH:  
**'NYS CODE RULE 56' & 'LEAD SAFE PRACTICE GUIDELINES.'**

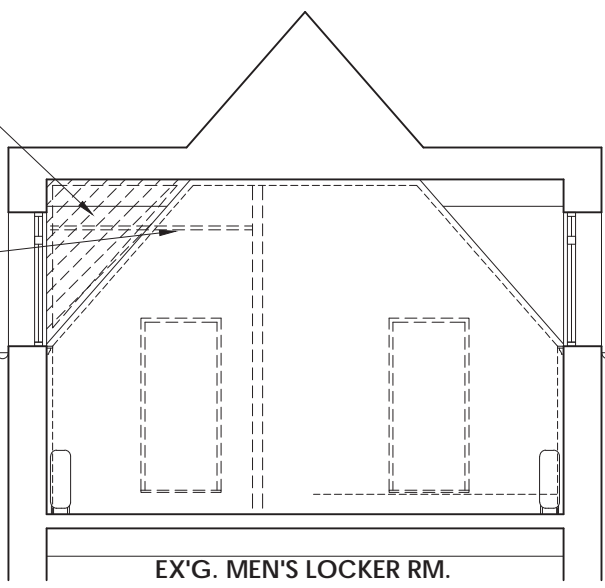

3 EX'G. MEN'S LOCKERS -- SECTION  
1/4" = 1'-0"

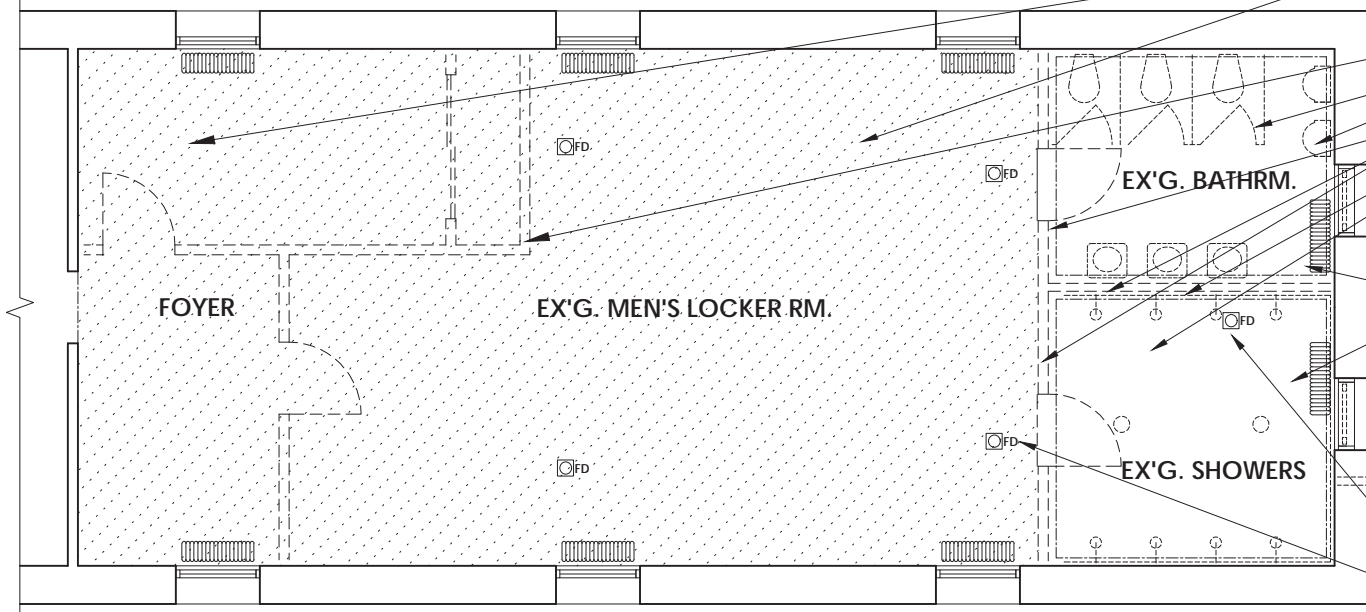

1 EX'G. CLUBHOUSE BATHRM. & LOCKERS -- DEMO PLAN  
1/4" = 1'-0"

**DEMOLITION:**  
**EX'G. MEN'S LOCKER & BATHROOM.**

**DEMOLISH & REMOVE THE FOLLOWING CONSTRUCTION & ITEMS:**  
GYP. WALLBOARD PARTITIONS & RELATED DOORS AT FRONT WALL.  
STORAGE RM. & CLOSET.  
TOILET STALL PARTITIONS AT EX'G. BATHRM.  
TOILETS, URINALS, LAVATORIES & ALL RELATED PIPING ABOVE FLOOR.  
MIRRORS & ALL BATHROOM ACCESSORIES.  
REMOVE DIVIDING WALLS, DOORS & CENTER DIVIDING PARTITIONS AT EX'G. BATHRM. & SHOWER RM.  
CERAMIC TILE FINISH ON SHOWER WALLS.  
SHOWER HEADS, FLOOR DRAINS & ALL RELATED PIPING ABOVE FLOOR.  
PIPING REMOVAL NOTE:  
REMOVE PIPING TO 3" BELOW SURFACE OF EX'G. RAISED FLOOR.  
CAP & SEAL PIPING WITHIN RAISED FLOOR.

**NOTE:**  
REFER TO 'P', 'M' & 'E' DWG'S. FOR REMOVALS OF PLUMBING, MECHANICAL & ELECTRICAL ITEMS.

**RAISED FLOOR NOTE: EX'G. BATHROOM & SHOWER RM.:**  
THESE EX'G. SPACES ARE BUILT ON AN 8" HIGH RAISED FLOOR. FLOOR WAS RAISED ABOVE THE EX'G. 2 ND. FLOOR SLAB TO ACCOMMODATE THE NEW PLUMBING FOR THE BATHROOM & SHOWER RMs.

**REMOVE THE EX'G. RAISED FLOORS:**  
REMOVALS INCLUDES BUT ARE NOT LIMITED TO:  
FLOOR FINISHES, TOPPING, SLABS, SHEATHING.  
FRAMING & RELATED ATTACHMENTS & SHIMS.  
DOORS & FRAMES.

**PLUMBING NOTE:**  
DISCONNECT EX'G. STEAM RADIATORS FROM EX'G. PIPING.


**REFRIGERANT PIPING PASSAGE:**  
CORE DRILL EXTERIOR WALL WITH UP TO A 4" HOLE THROUGH MASONRY WALL & STONE VENEER. COORD. CORE DIA. WITH (3) 1" PIPES TO PENETRATE WALL.

**FLOOR DRAINS: QTY. 5:**  
CORE DRILL EX'G. CONC. SLAB WITH UP TO A 6" HOLE.  
COORD. CORE DIA. WITH FLOOR DRAIN BODY & 3" DISCHARGE PIPE.  
REVIEW & CONFIRM LOCATIONS IN THE FIELD WITH COUNTY REP. PRIOR TO WORK.  
COORDINATE LOCATIONS TO AVOID CONFLICTS WITH EX'G. STRUCTURE, PIPING & OTHER OBSTRUCTIONS IN THE PRO SHOP AT THE 1 ST. FLOOR.

IN CHARGE OF ADAM KAPLINSKI RA  
CHECKED BY ADAM KAPLINSKI RA  
MADE BY JOHN W. LEVY RA

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NEW GOLF CART STORAGE FACILITY AND CLUBHOUSE UPGRADES MOHANSIC GOLF COURSE, YORKTOWN, NEW YORK EX'G. CLUBHOUSE -- BATH & LOCKER DEMO				SCALE: 1/4" = 1'-0" DATE: 6 / 4 / 21 DPW FILE NO. 10-02-D-40 REV. NO. 0

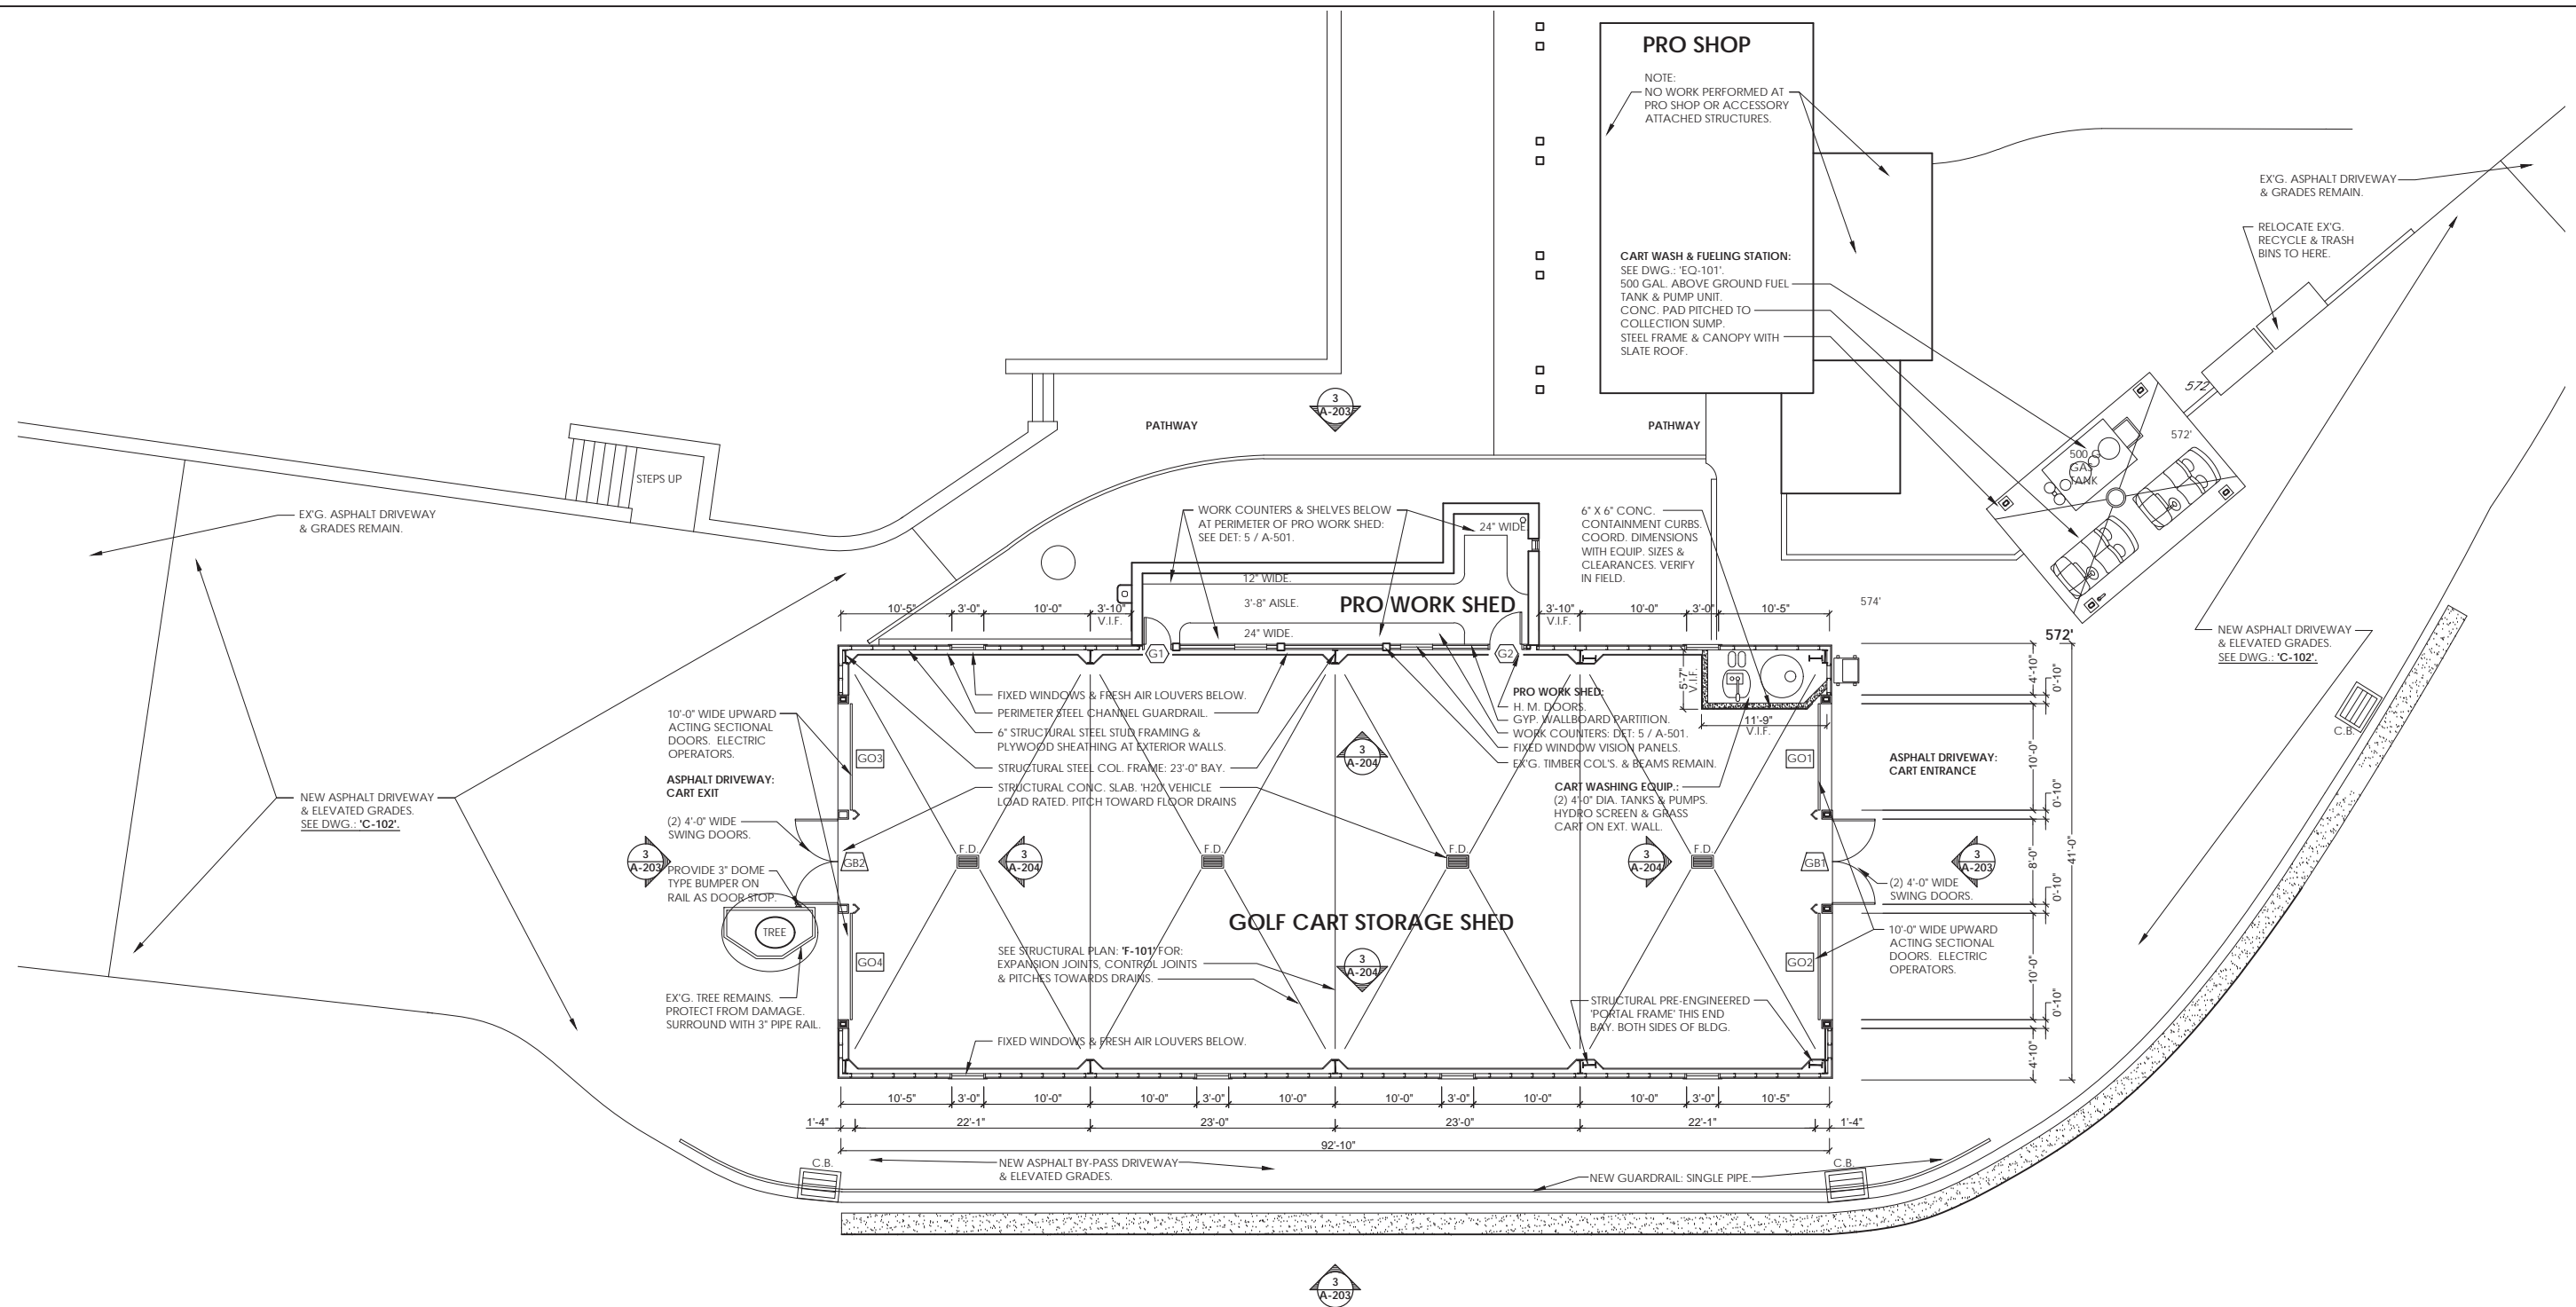




1 **NEW GOLF CART SHED -- PLAN**  
1/8" = 1'-0"



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CHECKED BY ADAM KAPLINSKI RA  
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<b>WESTCHESTER COUNTY, NEW YORK</b> <b>DEPARTMENT OF PUBLIC WORKS</b> <b>DIVISION OF ENGINEERING</b>				CONTRACT NUMBER 17-539
NEW GOLF CART STORAGE FACILITY AND CLUBHOUSE UPGRADES MOHANSIC GOLF COURSE, YORKTOWN, NEW YORK				SHEET NUMBER <b>A-101</b>
NEW GOLF CART STORAGE SHED -- PLAN				SHEET NO. 8 OF 59
SCALE: 1/8" = 1'-0" DATE: 6 / 4 / 21				REV. NO. 0
DPW FILE NO. 10-02-A-41				



**SLATE ROOF NOTE: PLUMBING VENTS:**  
PROVIDE PENETRATION IN SLATE ROOF & SHEATHING FOR PLUMBING VENT PIPES.  
INSTALL FLEXIBLE BOOT & COORD. WITH SLATE SHINGLES.  
REPAIR OR REPLACE SLATES AS REQ'D FOR NEW VENT PENETRATION & BOOT FLASHINGS.  
COORD. LOCATION IN FIELD.

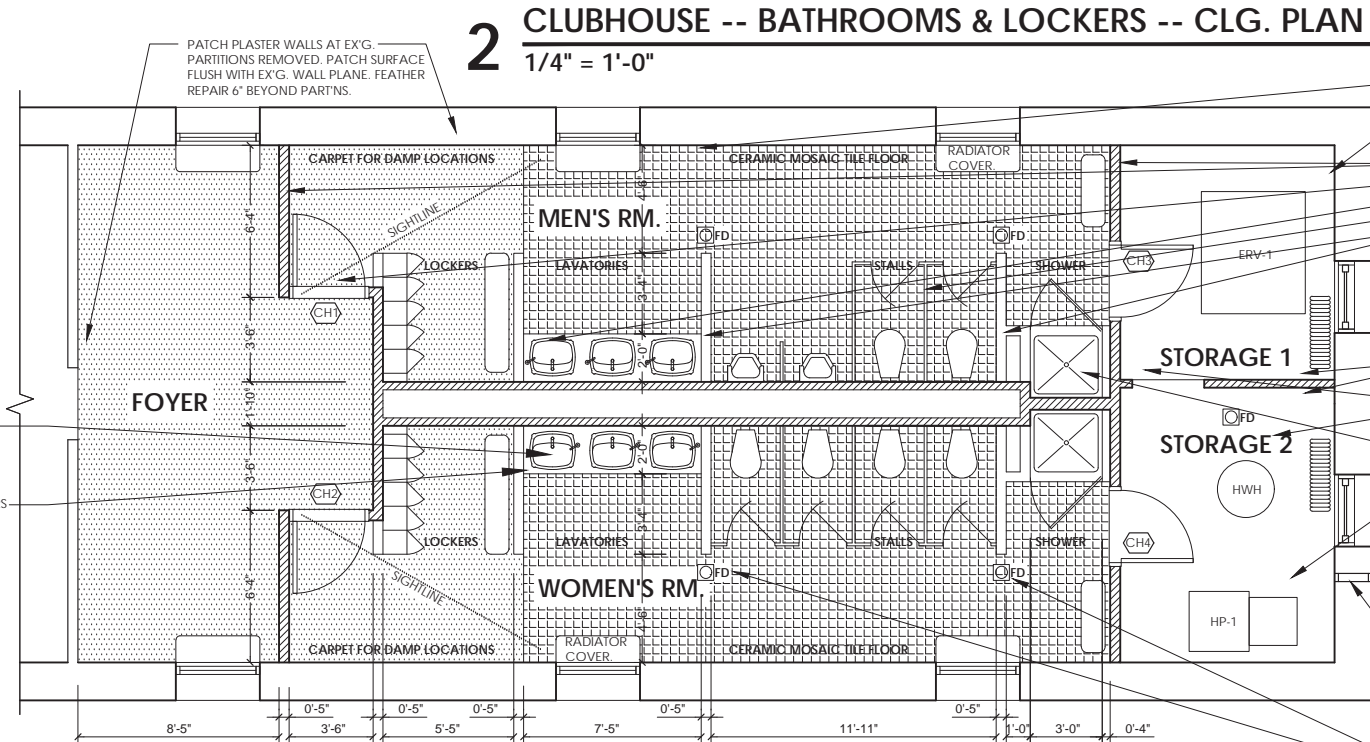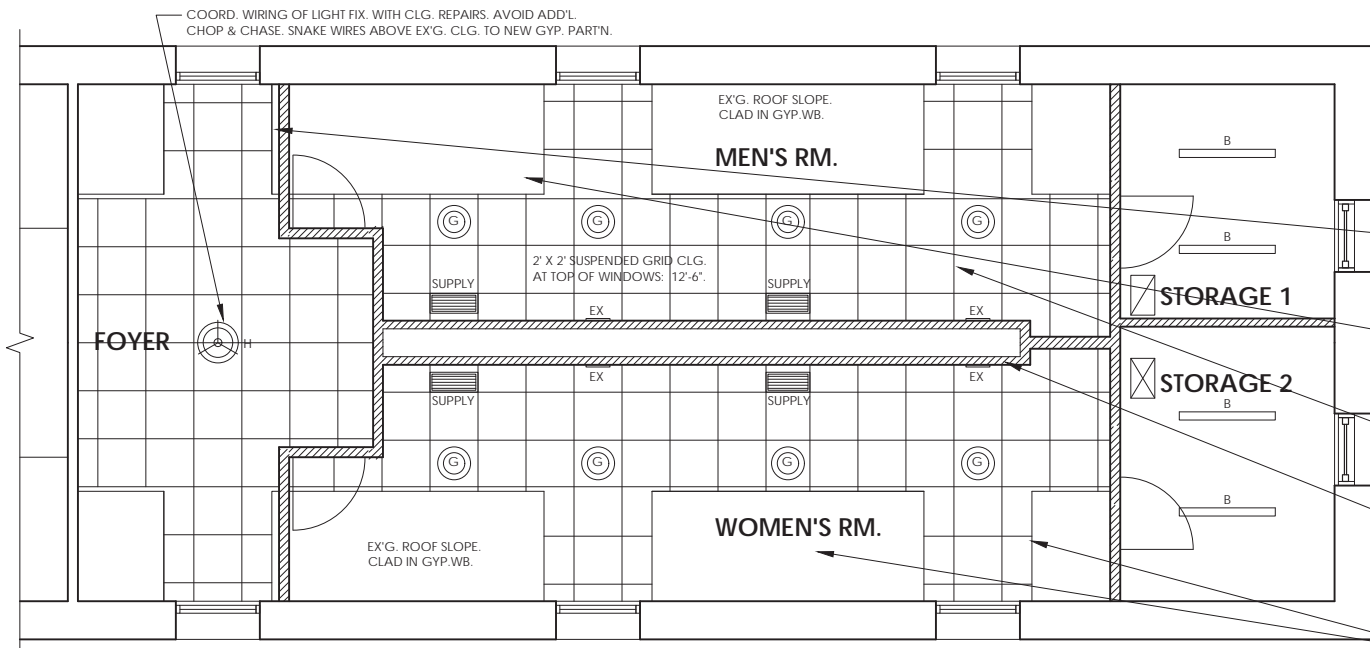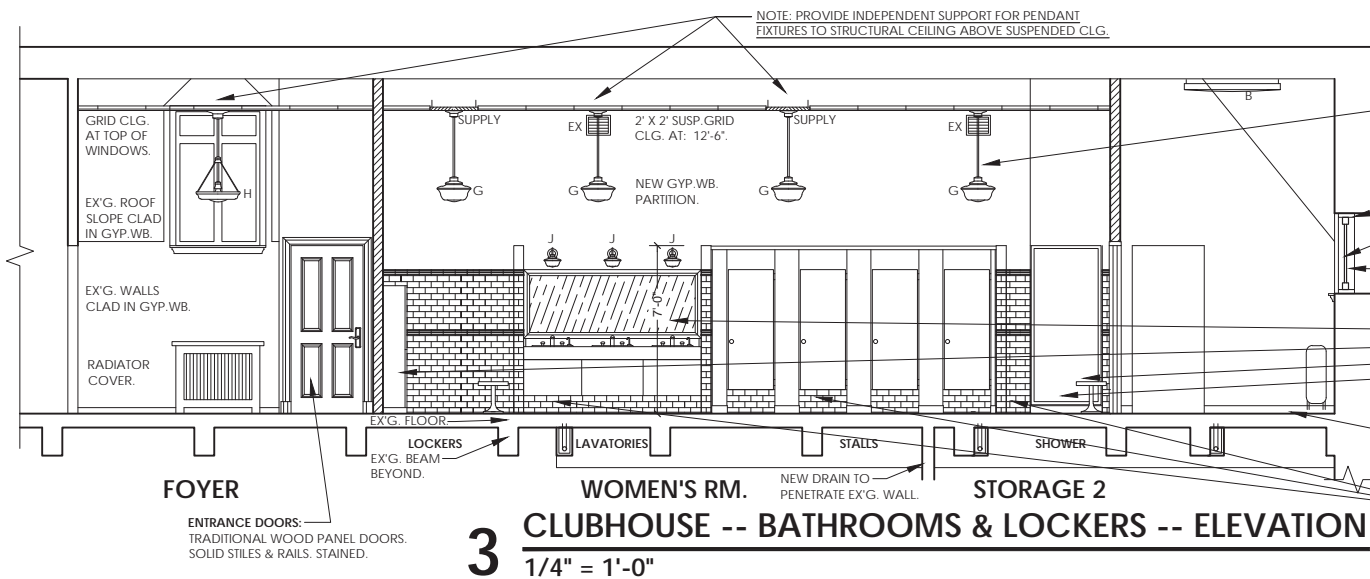**LIGHTING:** (4) SCHOOLHOUSE PENDANT FIXTURES IN BATHROOMS. AT 9'-0" A.F.F.  
(1) PENDANT DECORATIVE FIX. IN FOYER. AT 9'-0" A.F.F.  
(3) WALL SCONCES OVER MIRROR. AT 7'-0" A.F.F. VERIFY IN FIELD.  
PROVIDE EXTENSION STEMS TO 6'-0" MAX. LENGTH FOR ALL PENDANT FIXTURES.  
PROVIDE INDEPENDENT SUPPORT FOR PENDANT FIXTURES TO STRUCTURAL CEILING ABOVE.

EX'G. (2) QUARTER-ROUND PERIMETER FRAMES REMAIN.  
FABRICATE & INSTALL (2) NEW SASHES TO DUPLICATE APPEARANCE  
OF EX'G. MULLIONS. 1" MDO EXT. PLYWOOD.  
PRIME & PAINT ALL FACES & EDGES. INSTALL GRAY ALUM. INSECT  
SCREENS ON INTERIOR FACE OF NEW SASHES.  
SECURE SASH & SCREEN TO EX'G. WOOD FRAME. INSTALL 3/4" WOOD  
MOULDING TO CLOSE EXT. GAPS. PAINT MOULDING & EX'G. FRAME.

**INSTALL THE FOLLOWING ACCESSORIES:** SEE SPEC., DIVISION 10, 'SPECIALTIES':  
MIRRORS, SOAP DISPENSERS, PAPER TOWEL DISPENSERS, HAND DRIERS.  
LOCKERS: (3) CUSTOM LAMINATE. 2 TIER OFFSET HEIGHTS.  
BENCH AT LOCKERS & SHOWERS: CAST IRON PEDESTALS. HARDWOOD SEAT.  
SHOWER: PRE-CAST TERRAZZO FLOOR PAN. GLAZED TILE WALLS.  
OPSCURE TEMPERED GLASS SWING DOOR.

COUNTERTOP, LAVATORY & SOAP DISPENSER. SEE DETAIL: 'A-501'.

REPAIR EX'G. FLOOR SURFACE & FLASH PATCH SMOOTH AT WALLS REMOVED.  
INFILL CORE HOLES AT PIPES REMOVED WITH CONC. TO MAINTAIN FIRE  
SEPARATION AT FLOOR.

**TILE FINISH NOTE:**  
INSTALL WALL TILE AT: DIVIDING WALLS, LAVATORY & STALL: SIDE & REAR  
WALLS & SHOWER WALLS. INSTALL COVE BASE AND DECORATIVE BANDS  
AS DESCRIBED ON SECTION: '3 / A-501'. TILE EXTENDS TO 6'-0" HT.

**SANITARY & WASTEWATER PIPING CHASES:**  
CONSTRUCT A HORIZONTAL CHASES TO CONCEAL SANITARY & FLOOR DRAIN  
PIPING FROM BATHROOM ABOVE ( WHERE IT PENETRATES FLOOR & IS BELOW  
CEILING & BEAMS AT 1 ST. FLR. PRO SHOP ).  
CONSTRUCT 2 X 6 BACK-UP PLATE AGAINST EXT. CEILING, 1/2" MDO PLYWOOD  
SIDES & 1 X 8 CLEAR PINE BOTTOM AS PIPE ENCLOSURE CHASES.  
PRIME & PAINT TO MATCH EX'G. CLG. SEAL CHASE TO CLG. & OTHER EX'G.  
SURFACES. SEE DETAIL: DWG. 'A-501'. APPROX. LENGTH OF CHASES: 70 L.F.

REVIEW DUCT CONFIGURATION IN FIELD. COORD. WITH CHASE  
WALL & SUSP. CEILING ELEVATION.

#### NEW WORK: CEILINGS:

**PLASTER CEILING REPAIR NOTE:**  
RE-SUPPORT OR RE-FRAME METAL LATH TO MAINTAIN CLG. INTEGRITY AT REPAIR.  
INSTALL NEW METAL LATH AS REQ'D. FOR NEW PLASTER REPAIR AREAS.  
SUSPEND FROM ROOF FRAMING WITH GALV. WIRE.  
INSTALL 3 COAT CEMENT PLASTER TO MATCH EX'G. THICKNESS.  
CUT-BACK EX'G. PLASTER LAYERS IN 2" STEPS TO PROVIDE NEW LAYER OVERLAP.

REPAIR PLASTER CLG. FLUSH AT PARTNS. REMOVED. BLEND & FEATHER REPAIR 6"  
BEYOND PARTNS. SAND SMOOTH.

**ROOF LEAK REPAIR NOTE:**  
PERFORM REPAIRS TO DORMER & VALLEY FLASHINGS, ROOF WATER-PROOF  
MEMBRANES & SLATE SHINGLES AS REQUIRED TO REPAIR LEAK.

**NEW SUSPENDED GRID CEILING:**  
INSTALL NEW 2' X 2' SUSP. GRID: STD. 1" T". WITH ANTI-SAG, ANTI MICROBIAL TILES  
SUITABLE FOR DAMP LOCATIONS. SET CLG. HEIGHT AT TOP OF EX'G. WINDOWS.  
PROVIDE A TRIANGULAR WOOD BLOCK TO CLOSE GAP BETWEEN T' GRID &  
SLOPED CLG. PROVIDE INDEPENDENT SUPPORT FOR PENDANT LIGHT FIXTURES.

**NEW PARTITIONS:**  
SECURE NEW STUD PARTITIONS TO EX'G. METAL GRID STRUCTURE  
ABOVE PLASTER CLG.  
TAPE GYP. WALLBOARD SURFACES INTO EX'G. GYP. PLASTER FINISH.  
REPAIR PLASTER DAMAGE AT PARTITIONS REMOVED.

#### NEW WORK: MEN'S & WOMEN'S LOCKER & BATHROOM.

**INSTALL THE FOLLOWING NEW CONSTRUCTION & ITEMS:**  
GYP. WALLBOARD OVERLAY ON ALL VISIBLE & EXPOSED PLASTER WALLS, WINDOW  
DORMERS & SLOPED PLASTER CEILINGS: 3/8" GYP. WALLBOARD SCREW & ADHESIVE  
APPLIED TO EX'G. SURFACES. TAPE-IN CORNER BEADS & VARIABLE ANGLE METAL /  
PAPER TAPES TO CREATE STRAIGHT UNIFORM ANGLES & CORNERS.

**GENERAL SPACE ITEMS:**  
GYP. WALLBOARD PARTITIONS. FULL HEIGHT TO PLASTER CLG. ABOVE  
ENTRANCE DOORS: TRADITIONAL WOOD PANEL DOORS, STAINED. LEVER HARDWARE.  
LAVATORIES, URINALS & TOILETS. RELATED NEW PIPING.  
TOILET STALL PARTITIONS: STAINLESS STEEL. FLOOR MOUNTED WITH HEADRAIL.  
GYP. WALLBOARD PARTITIONS. PARTIAL HEIGHT TO 7'-0".

**FINISHES: MEN'S & WOMEN'S BATHROOM & LOCKERS:**  
FIXTURE WALLS: CERAMIC GLAZED TILE TO 6'-0" HT. PAINT ABOVE.  
EX'G. WALLS, NEW NON-FIXTURE WALLS & SLOPED CLG'S: GYP. W.B. & EPOXY PAINT.  
BATHROOM & SHOWER FLOORS: 2' X 2' CERAMIC MOSAIC TILE & 6" TILE COVE BASE.  
FOYER & LOCKER FLOORS: CARPET. ANTI-MICROBIAL, DAMP LOCATION.

**FINISHES: STORAGE RMS:**  
WALLS: NEW GYP. WALLBOARD, PAINT.  
CEILINGS: REPAIR DAMAGE AT WALL REMOVALS & PLUMBING  
REMOVALS: 100 S.F. REPAIR AREA. PAINT ENTIRE ROOM.  
FLOORS: 12" X 12" VCT, 4" RUBBER COVE BASE.  
OR SEAMLESS SHEET FLOORING, SELF COVED.

#### LOWERED FLOOR NOTE: NEW STORAGE 1 & 2:



**RESTORE EX'G. SLAB SURFACE:**  
REPAIRS INCLUDE BUT ARE NOT LIMITED TO:  
RESTORE & REPAIR EX'G. 2 ND. FLOOR SLAB IN STORAGE AREAS SHOWN WITH  
5,000 PSI SELF LEVELING CEMENT FLOOR TOPPINGS.

**PLUMBING NOTE:**  
MODIFY RADIATOR PIPING TO RE-INTEGRATE LOWERED RADIATORS.  
INSTALL PIPE UNIONS & RE-CONNECT EX'G. RADIATORS.  
PROVIDE SOLID PLASTIC OR NYLON 'PEDESTALS' TO RAISE RADIATORS A FEW INCHES IF  
PIPING EXTENSIONS REQUIRE MORE HEIGHT.

**REFRIGERANT PIPING EXTERIOR CHASE:**  
CONSTRUCT AN 8" X 8" APPROX. SIZE VERTICAL CHASE TO CONCEAL PIPING FROM  
CORED PASSAGE ABOVE TO CONDENSING UNIT AT GRADE: PPT 2 X 6 BACK-UP PLATE  
AGAINST EXT. WALL. 1 X 8 & 1 X 10 KNOTTY PINE BOARDS AS PIPE ENCLOSURE CHASE.  
STAIN DARK BROWN TO MATCH EX'G. BLDG. WOOD TRIMS. PROVIDE L.C. COPPER CAP  
AT TOP. SEAL CHASE TO EXT. WALL PROFILE. SEE DETAIL: DWG. 'A-501'

**REFRIGERANT PIPING PASSAGE:**  
FILL CORE PASSAGE WITH 1" DEEP LIQUID URETHANE SEALANT RINGS AT EXTERIOR &  
INTERIOR. FILL CAVITY BETWEEN SEALANT RINGS WITH 1" FOAM BACK-UP RODS.

**FLOOR DRAINS: QTY. 5:**  
SET NEW FLOOR DRAINS INTO CORES WITH MORTAR & GROUT. NOTCH DRAIN FLANGE INTO  
EX'G. FLOOR AS REQ'D. TO SET TOP OF DRAIN FLANGE 1/8" BELOW NEW TILE FLOOR.  
BED DRAIN BODY FLANGE IN SEALANT & SEAL FLANGE PERIMETER TO FLOOR TILES.  
CUT FLOOR TILES EDGE OF DRAIN FLANGE. PROVIDE A WATER-PROOF TRANSITION TO DRAIN.

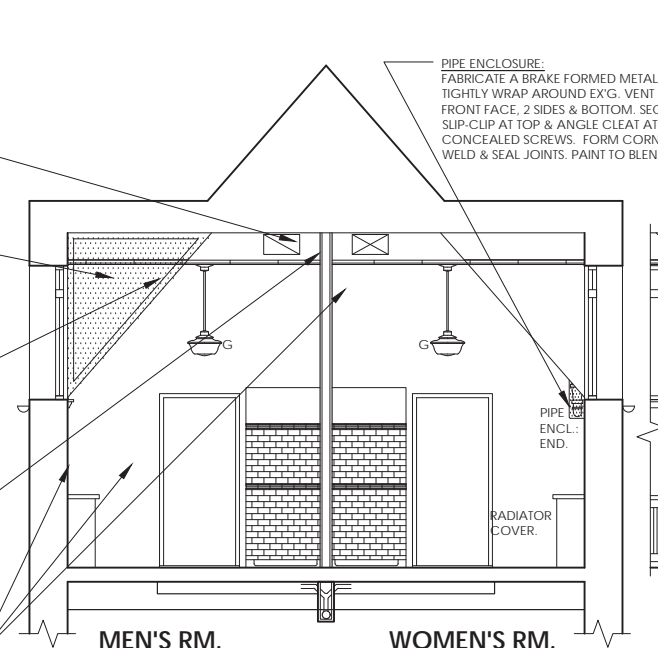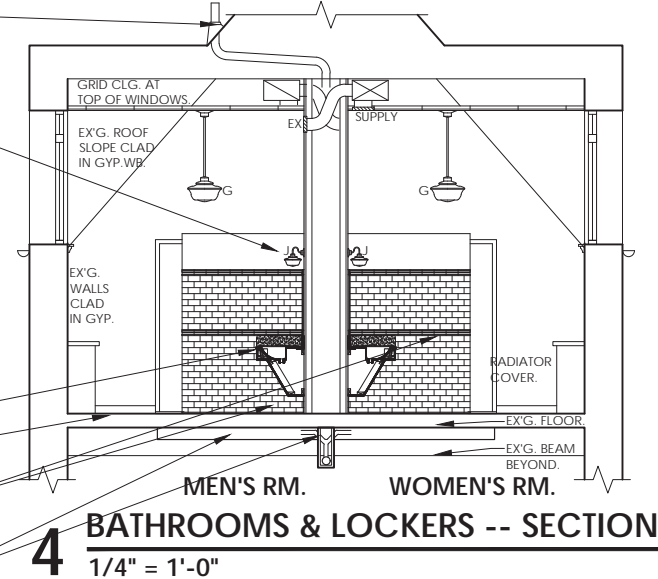

#### PAINTING NOTE:


PRIME AND PAINT ALL THE FOLLOWING ITEMS:  
EX'G. PLASTER WALLS & CLG'S  
EX'G. WINDOW FRAMES, SILLS, SASHES & MULLIONS.  
EX'G. PAINTED DOORS & FRAMES.  
NEW PLASTER PATCHES & REPAIRS.  
NEW GYP. WALLBOARD SURFACES.

**PLASTER REPAIR NOTE:**  
PATCH PLASTER WALLS & CLG'S. AT ALL EX'G.  
PARTITIONS REMOVED.  
PATCH SURFACE FLUSH WITH EX'G. WALL OR  
CLG. PLANE.


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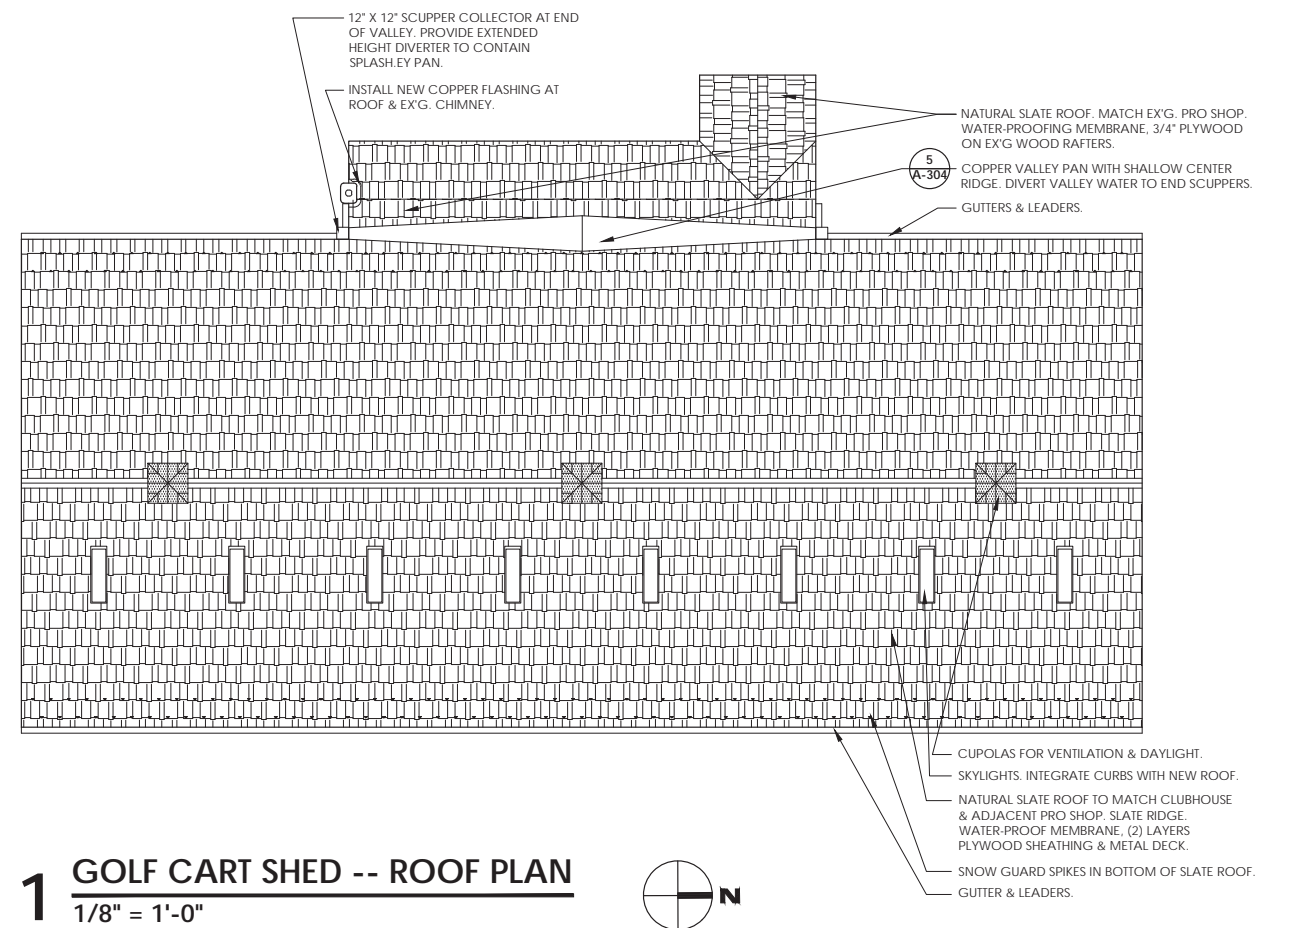
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DEPARTMENT OF PUBLIC WORKS		SHEET NUMBER A-102		
DIVISION OF ENGINEERING		SHEET NO. 9 OF 59		
NEW GOLF CART STORAGE FACILITY AND CLUBHOUSE UPGRADES		SCALE: 1/4" = 1'-0"		
MOHANSIC GOLF COURSE, YORKTOWN, NEW YORK		DATE: 6/4/21		
CLUBHOUSE -- NEW BATHROOMS & LOCKERS		DPW FILE NO. 10-02-A-42		
		REV. NO. 0		




**2 GOLF CART SHED -- CEILING PLAN**  
1/8" = 1'-0"

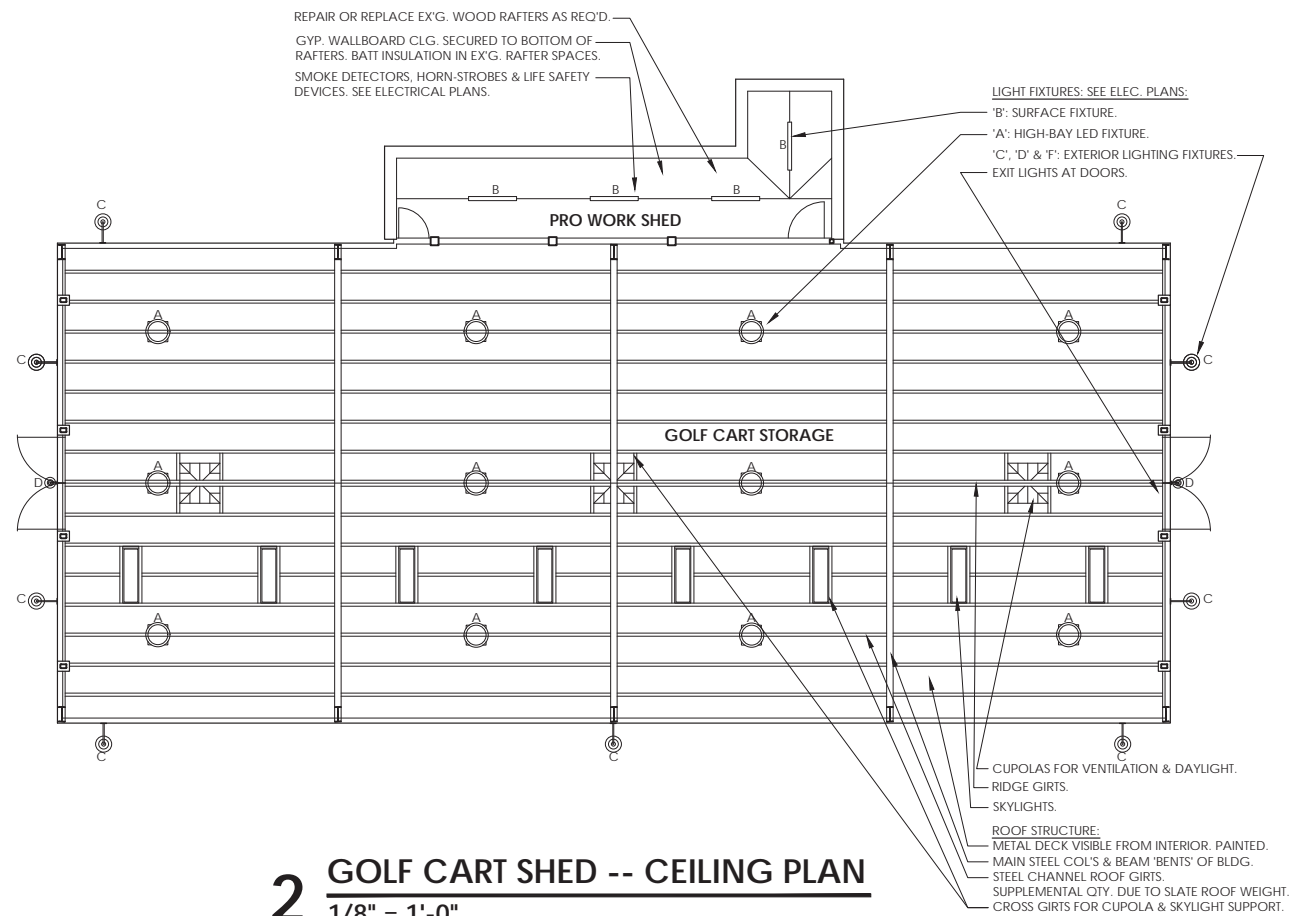

**4 EQUIP. WASH & FUEL STATION -- CLG. PLAN**  
1/8" = 1'-0"

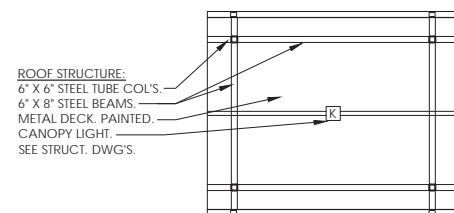

**1 GOLF CART SHED -- ROOF PLAN**  
1/8" = 1'-0"

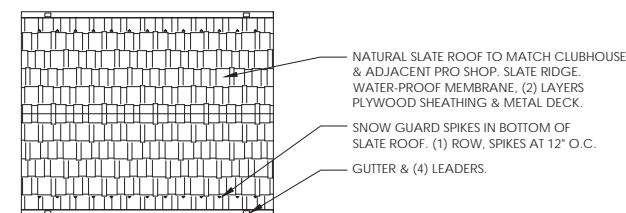


**3 EQUIP. WASH & FUEL STATION -- ROOF PLAN**  
1/8" = 1'-0"

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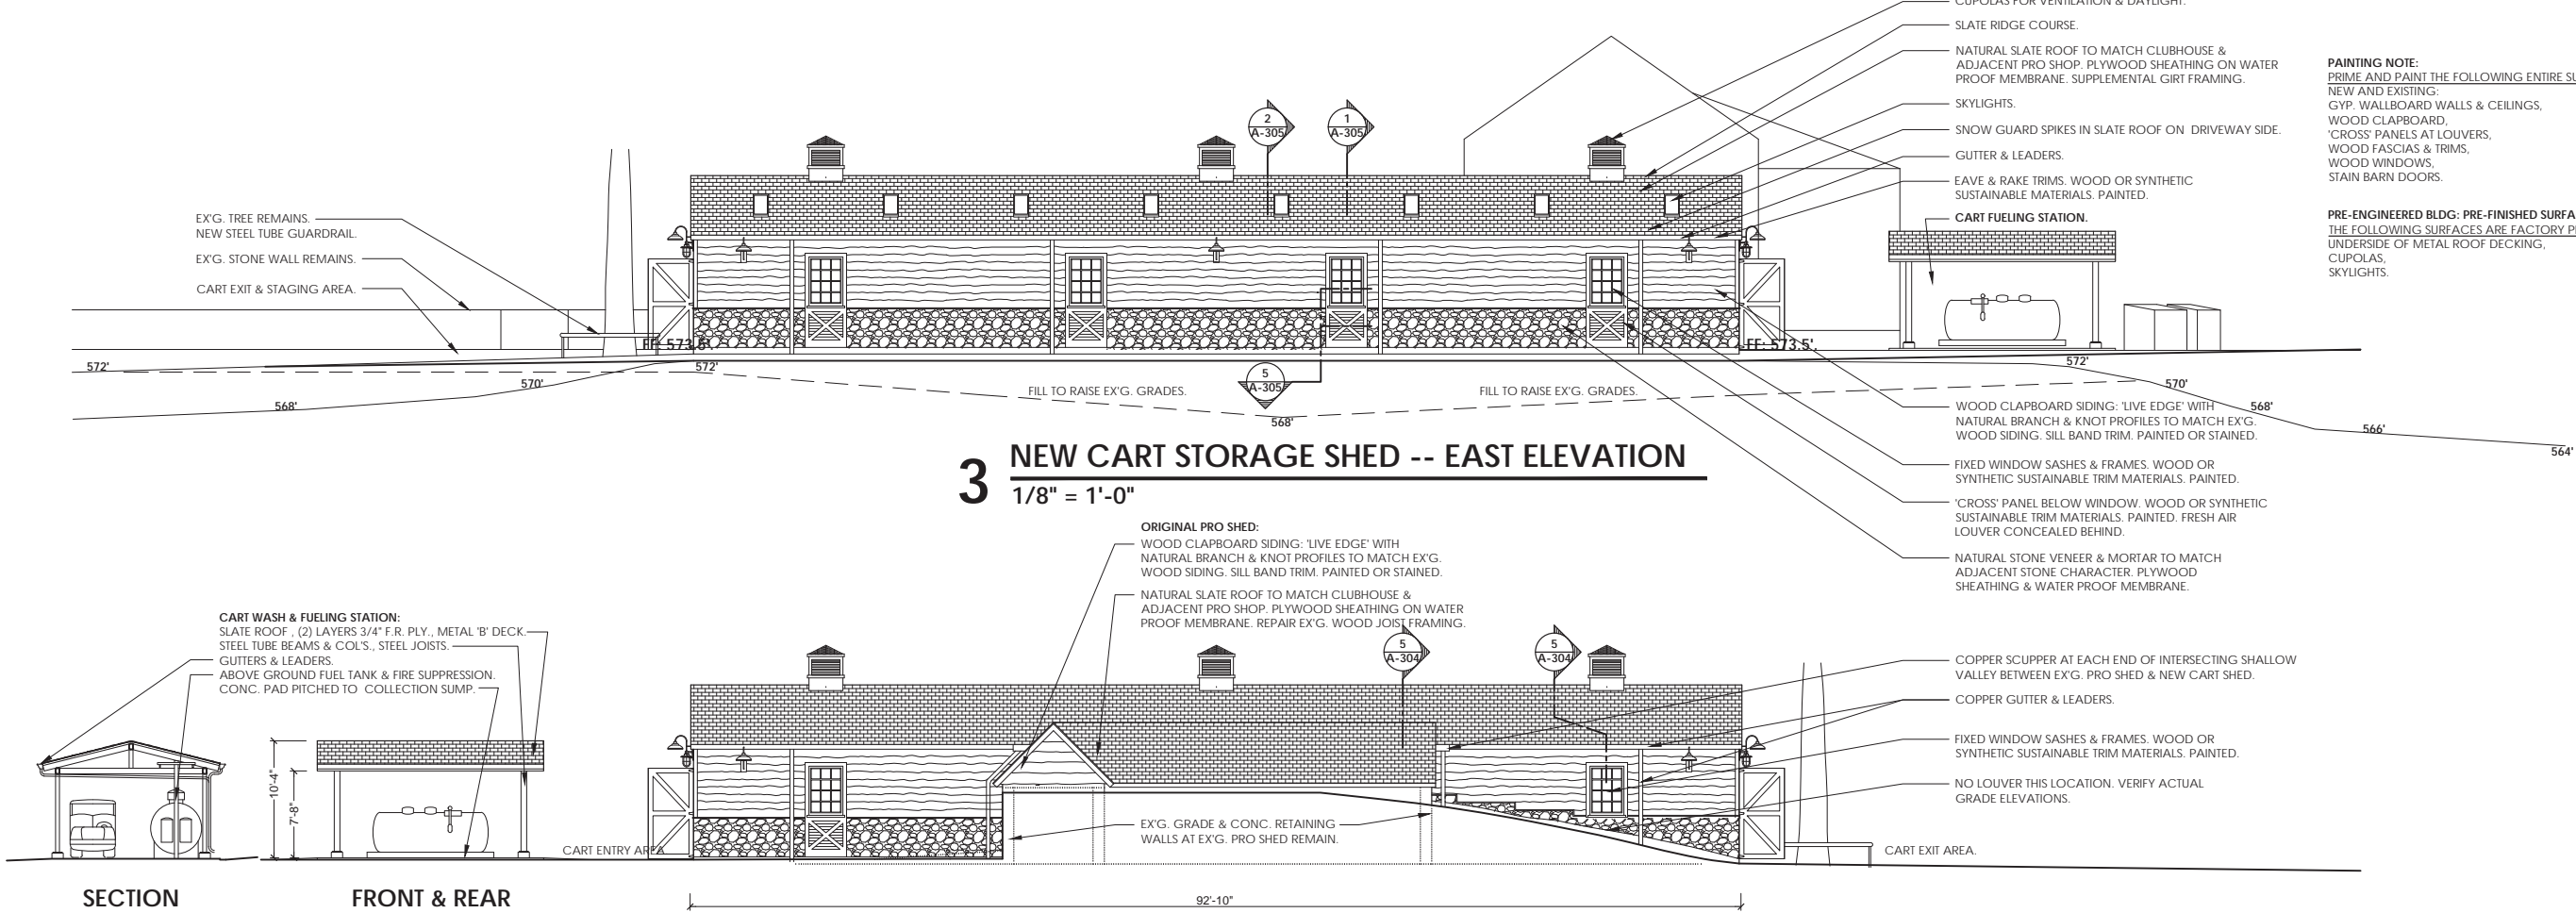
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TITLE	DATE			TITLE
<b>WESTCHESTER COUNTY, NEW YORK</b> <b>DEPARTMENT OF PUBLIC WORKS</b> <b>DIVISION OF ENGINEERING</b>				CONTRACT NUMBER 17-539 SHEET NUMBER <b>A-103</b>
NEW GOLF CART STORAGE FACILITY AND CLUBHOUSE UPGRADES MOHANSIC GOLF COURSE, YORKTOWN, NEW YORK NEW CART SHED -- ROOF & CEILING PLANS				SCALE: 1/8" = 1'-0" DATE: 6 / 4 / 21 DPW FILE NO. 10-02-A-43 REV. NO. 0



**2 NEW CART STORAGE SHED -- NORTH ELEVATION**  
1/8" = 1'-0"

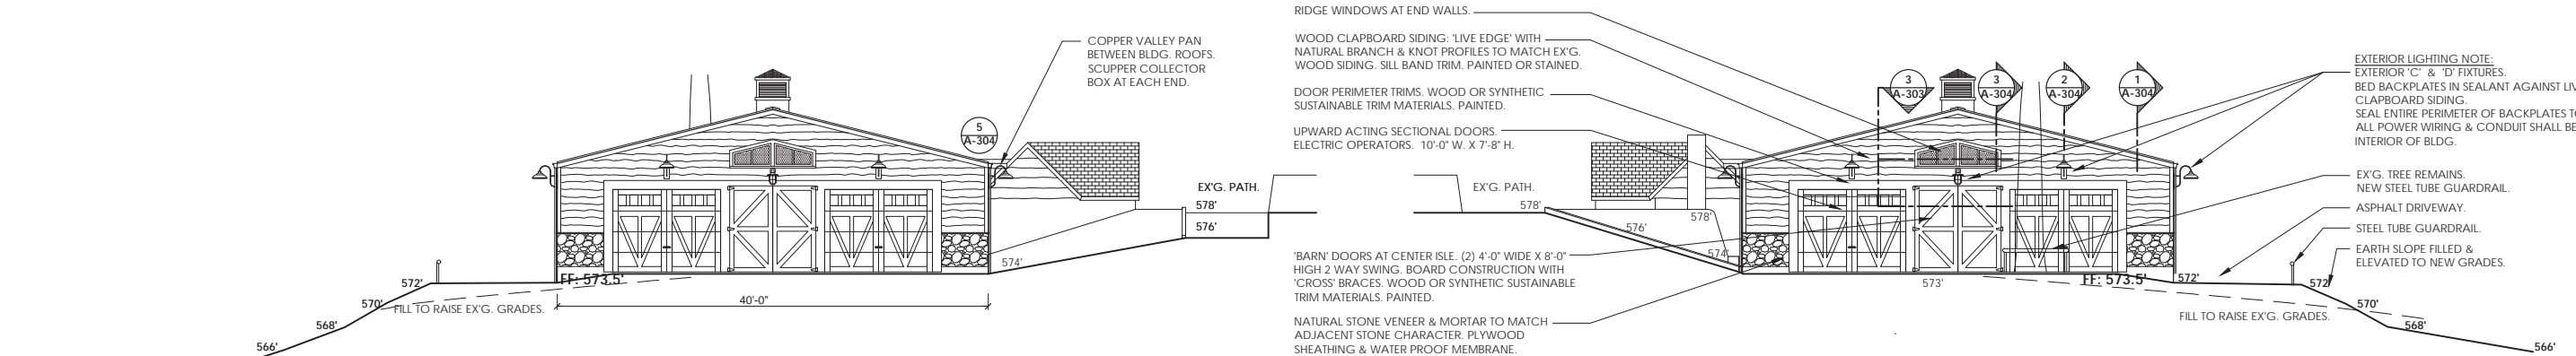**1 NEW CART STORAGE SHED -- SOUTH ELEVATION**  
1/8" = 1'-0"



**3 NEW CART STORAGE SHED -- EAST ELEVATION**  
1/8" = 1'-0"

**4 NEW CART STORAGE SHED -- WEST ELEVATION**  
1/8" = 1'-0"

**5 CART WASH & FUEL STATION -- CANOPY**  
1/8" = 1'-0"


IN CHARGE OF ADAM KAPLINSKI RA  
CHECKED BY ADAM KAPLINSKI RA  
MADE BY JOHN W. LEVY RA

IT IS A VIOLATION OF NYS LAW FOR ANY PERSON TO ALTER THIS DOCUMENT IN ANY WAY, UNLESS ACTING UNDER THE DIRECTION OF A LICENSED PROFESSIONAL ENGINEER. IF A DOCUMENT BEARING THE SEAL OF AN ENGINEER IS ALTERED, THE ALTERING ENGINEER SHALL AFFIX TO THE DOCUMENT THEIR SEAL AND THE NOTATION "ALTERED BY" FOLLOWED BY THEIR SIGNATURE AND THE DATE OF SUCH ALTERATION, AND A SPECIFIC DESCRIPTION OF THE ALTERATION.


**PAINTING NOTE: WASH & FUEL STATIONS:**  
PRIME AND PAINT THE FOLLOWING ENTIRE SURFACES:  
STRUCTURAL STEEL FRAMING, BASES & BRACES,  
UNDERSIDE OF METAL ROOF DECKING,  
FASCIAS & TRIMS.

**PRE-FINISHED SURFACES: WASH & FUEL STATIONS:**  
THE FOLLOWING SURFACES ARE FACTORY PRE-FINISHED:  
STANDING SEAM ROOF PANELS,  
GUTTERS & LEADERS,  
CEILING LINER PANELS,  
METAL FASCIAS & TRIMS.


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CONTRACTOR		PROJECT COORDINATOR		
NAME	SIGNATURE	NAME	SIGNATURE	DATE
TITLE	DATE	TITLE	DATE	DATE
WESTCHESTER COUNTY, NEW YORK DEPARTMENT OF PUBLIC WORKS DIVISION OF ENGINEERING				CONTRACT NUMBER 17-539
NEW GOLF CART STORAGE FACILITY AND CLUBHOUSE UPGRADES MOHANSIC GOLF COURSE, YORKTOWN, NEW YORK NEW GOLF CART STORAGE SHED -- EXT. ELEV.				SHEET NUMBER A-201
SCALE: 1/8" = 1'-0" DATE: 6/4/21				SHEET NO. 11 OF 59
DPW FILE NO. 10-02-A-44				REV. NO. 0

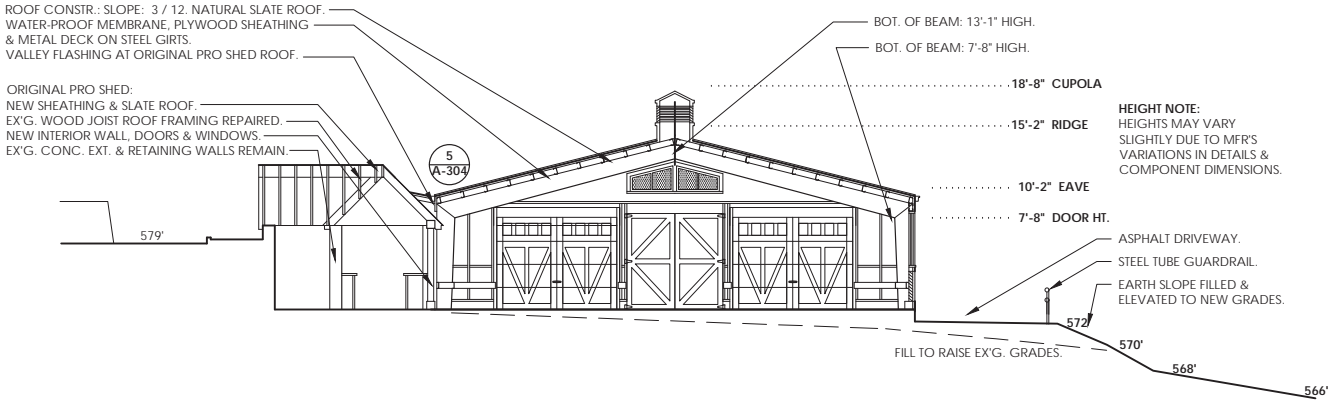

2 NEW CART STORAGE SHED -- NORTH ELEVATION  
1/8" = 1'-0"

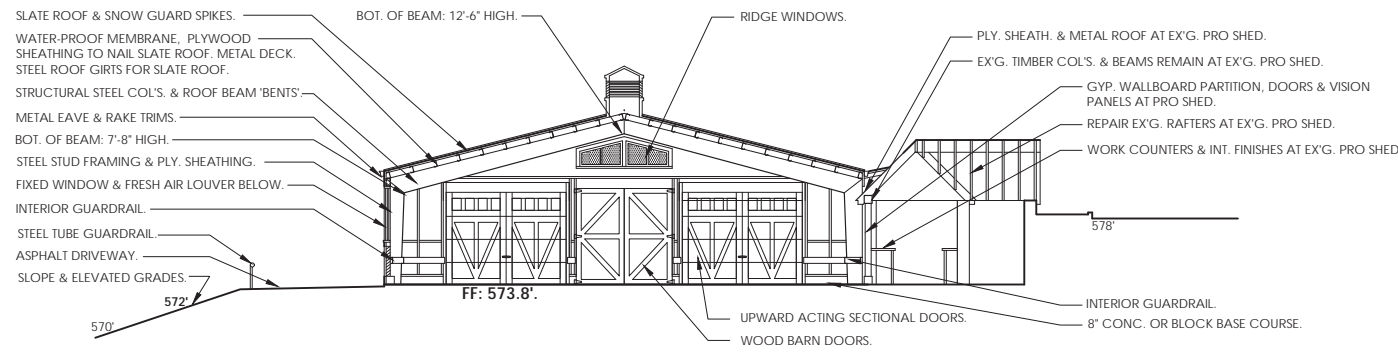


1 NEW CART STORAGE SHED -- SOUTH ELEVATION  
1/8" = 1'-0"

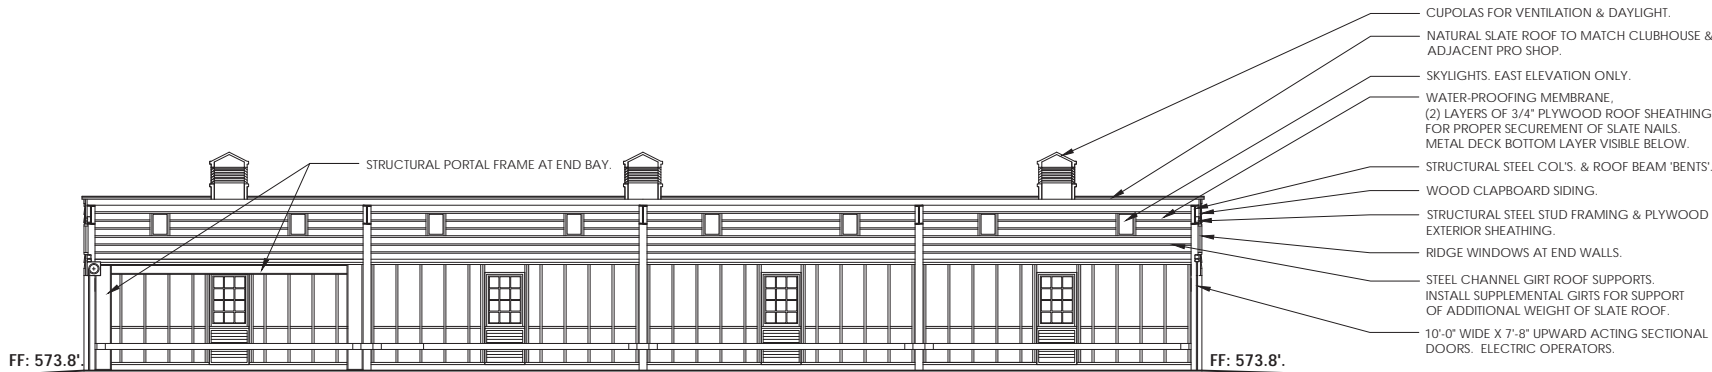

**PAINTING NOTE:**  
PRIME AND PAINT THE FOLLOWING ENTIRE SURFACES:  
NEW AND EXISTING:  
GYP. WALLBOARD WALLS & CEILINGS.  
WOOD CLAPBOARD,  
'CROSS' PANELS AT LOUVERS,  
WOOD FASCIAS & TRIMS,  
WOOD WINDOWS,  
STAIN BARN DOORS.

**PRE-ENGINEERED BLDG. PRE-FINISHED SURFACES:**  
THE FOLLOWING SURFACES ARE FACTORY PRE-FINISHED:  
UNDERSIDE OF METAL ROOF DECKING,  
CUPOLAS,  
SKYLIGHTS.

3 NEW CART STORAGE SHED -- EAST ELEVATION  
1/8" = 1'-0"

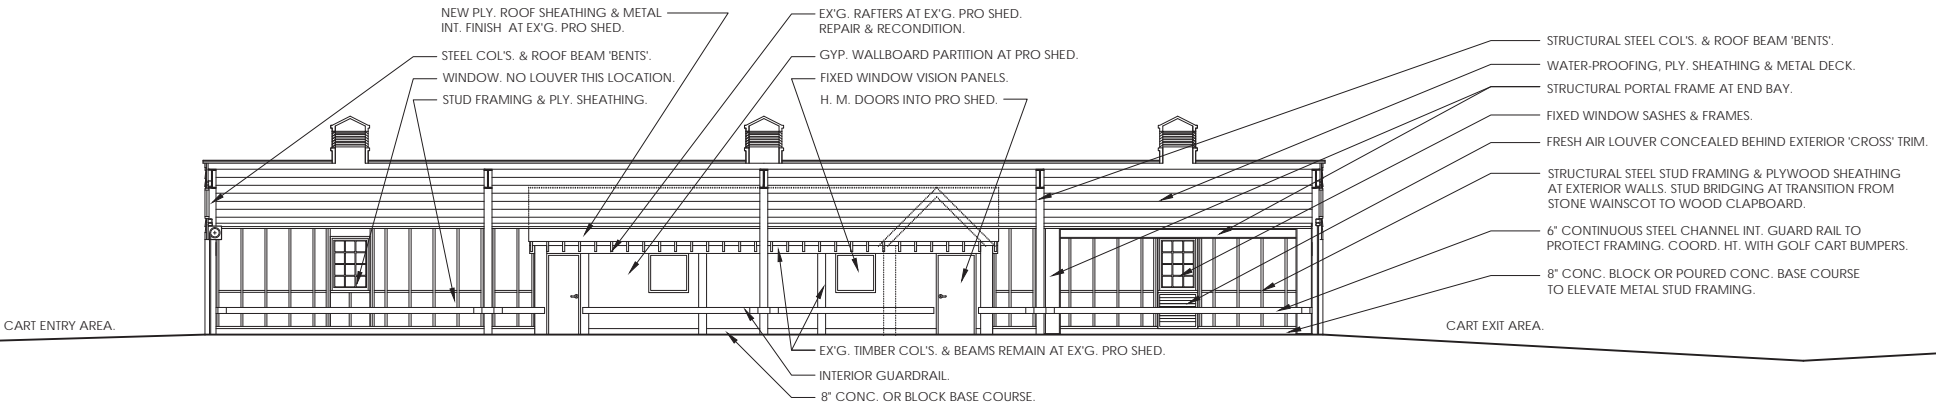

4 NEW CART STORAGE SHED -- WEST ELEVATION  
1/8" = 1'-0"



**PAINTING NOTE: MATERIALS STORAGE BINS:**  
PRIME AND PAINT THE FOLLOWING ENTIRE SURFACES:  
STRUCTURAL STEEL FRAMING, BASES & BRACES,  
SAFETY BAR.  
STAIN UNDERSIDE OF PLY. ROOF SHEATHING.  
STAIN WOOD FASCIAS & TRIMS.

**PRE-FINISHED SURFACES: MATERIALS STORAGE BINS:**  
THE FOLLOWING SURFACES ARE FACTORY PRE-FINISHED:  
STANDING SEAM ROOF PANELS,  
GUTTERS & LEADERS.

REVISION NUMBER	DATE	MADE BY	APP'D BY	REVISION
RECORD DRAWING CERTIFICATION				
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CONTRACTOR			PROJECT COORDINATOR	
NAME SIGNATURE TITLE			NAME SIGNATURE TITLE	
DATE			DATE	
WESTCHESTER COUNTY, NEW YORK DEPARTMENT OF PUBLIC WORKS DIVISION OF ENGINEERING			CONTRACT NUMBER 17-539	SHEET NUMBER A-202
NEW GOLF CART STORAGE FACILITY AND CLUBHOUSE UPGRADES MOHANSIC GOLF COURSE, YORKTOWN, NEW YORK NEW GOLF CART STORAGE SHED -- INT. ELEV.			SHEET NO. 12 OF 59 SCALE: 1/8" = 1'-0" DATE: 6 / 4 / 21 DPW FILE NO.	REV. NO. 0
			10-02-A-45	

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AS BUILT - NO CHANGES				
CONTRACTOR			PROJECT COORDINATOR	
NAME			NAME	
SIGNATURE			SIGNATURE	
TITLE	DATE		TITLE	DATE
WESTCHESTER COUNTY, NEW YORK				
DEPARTMENT OF PUBLIC WORKS				
DIVISION OF ENGINEERING				
NEW GOLF CART STORAGE FACILITY			CONTRACT NUMBER	SHEET NUMBER
AND CLUBHOUSE UPGRADES			17-539	A-301
MOHANSIC GOLF COURSE, YORKTOWN, NEW YORK			SHEET NO. 13 OF 59	
CART SHED -- WALL SECTIONS - ELEVATIONS			SCALE: 3/4" = 1'-0"	
			DATE: 6/4/21	
			DPW FILE NO.	REV. NO.
			10-02-A-46	0

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NOTE: VALLEY TAPERS IN WIDTH AS IT DESCENDS TOWARD END SCUPPERS. REVIEW PROFILE WITH ARCH. IN FIELD TO ESTABLISH PITCH, SHAPE & ANGLE OF DESCENT.

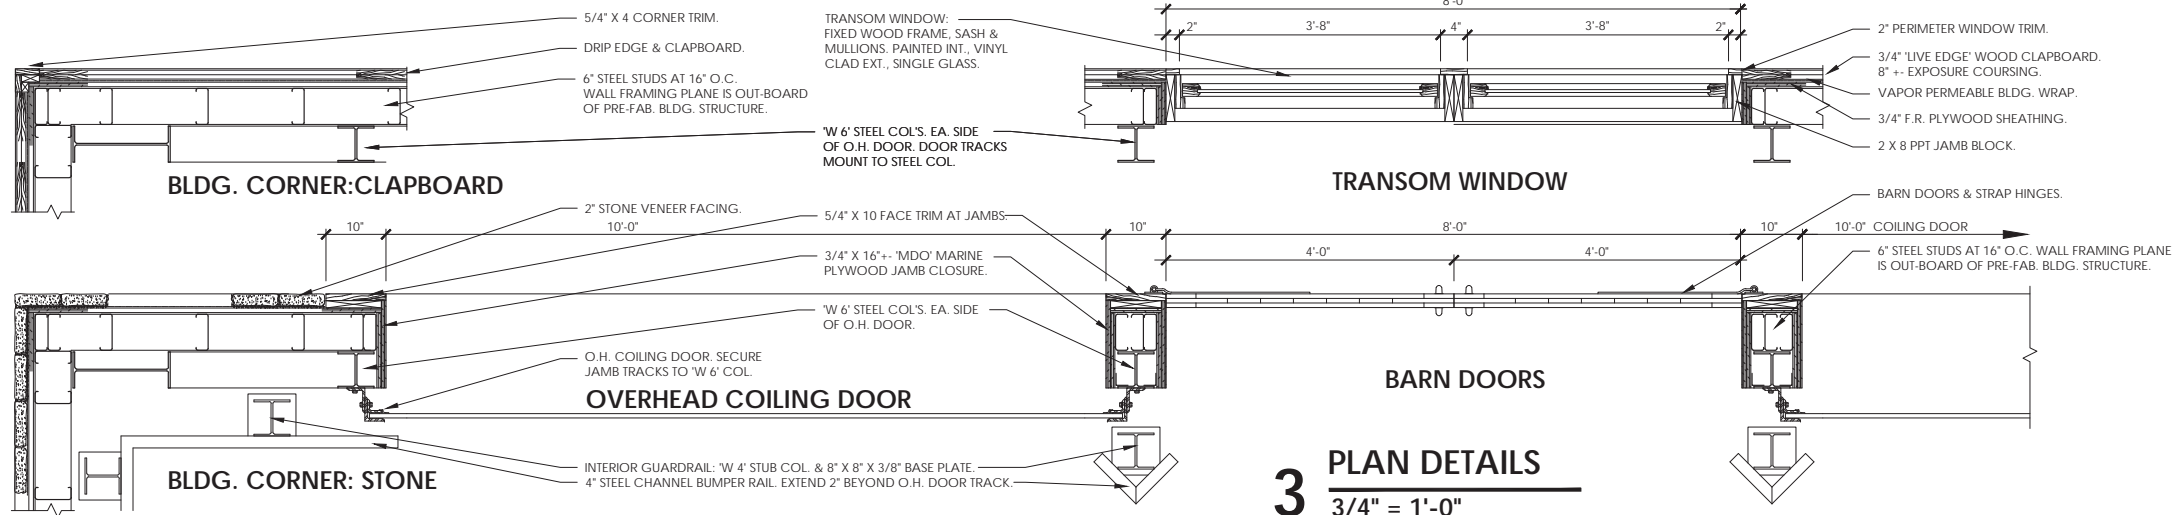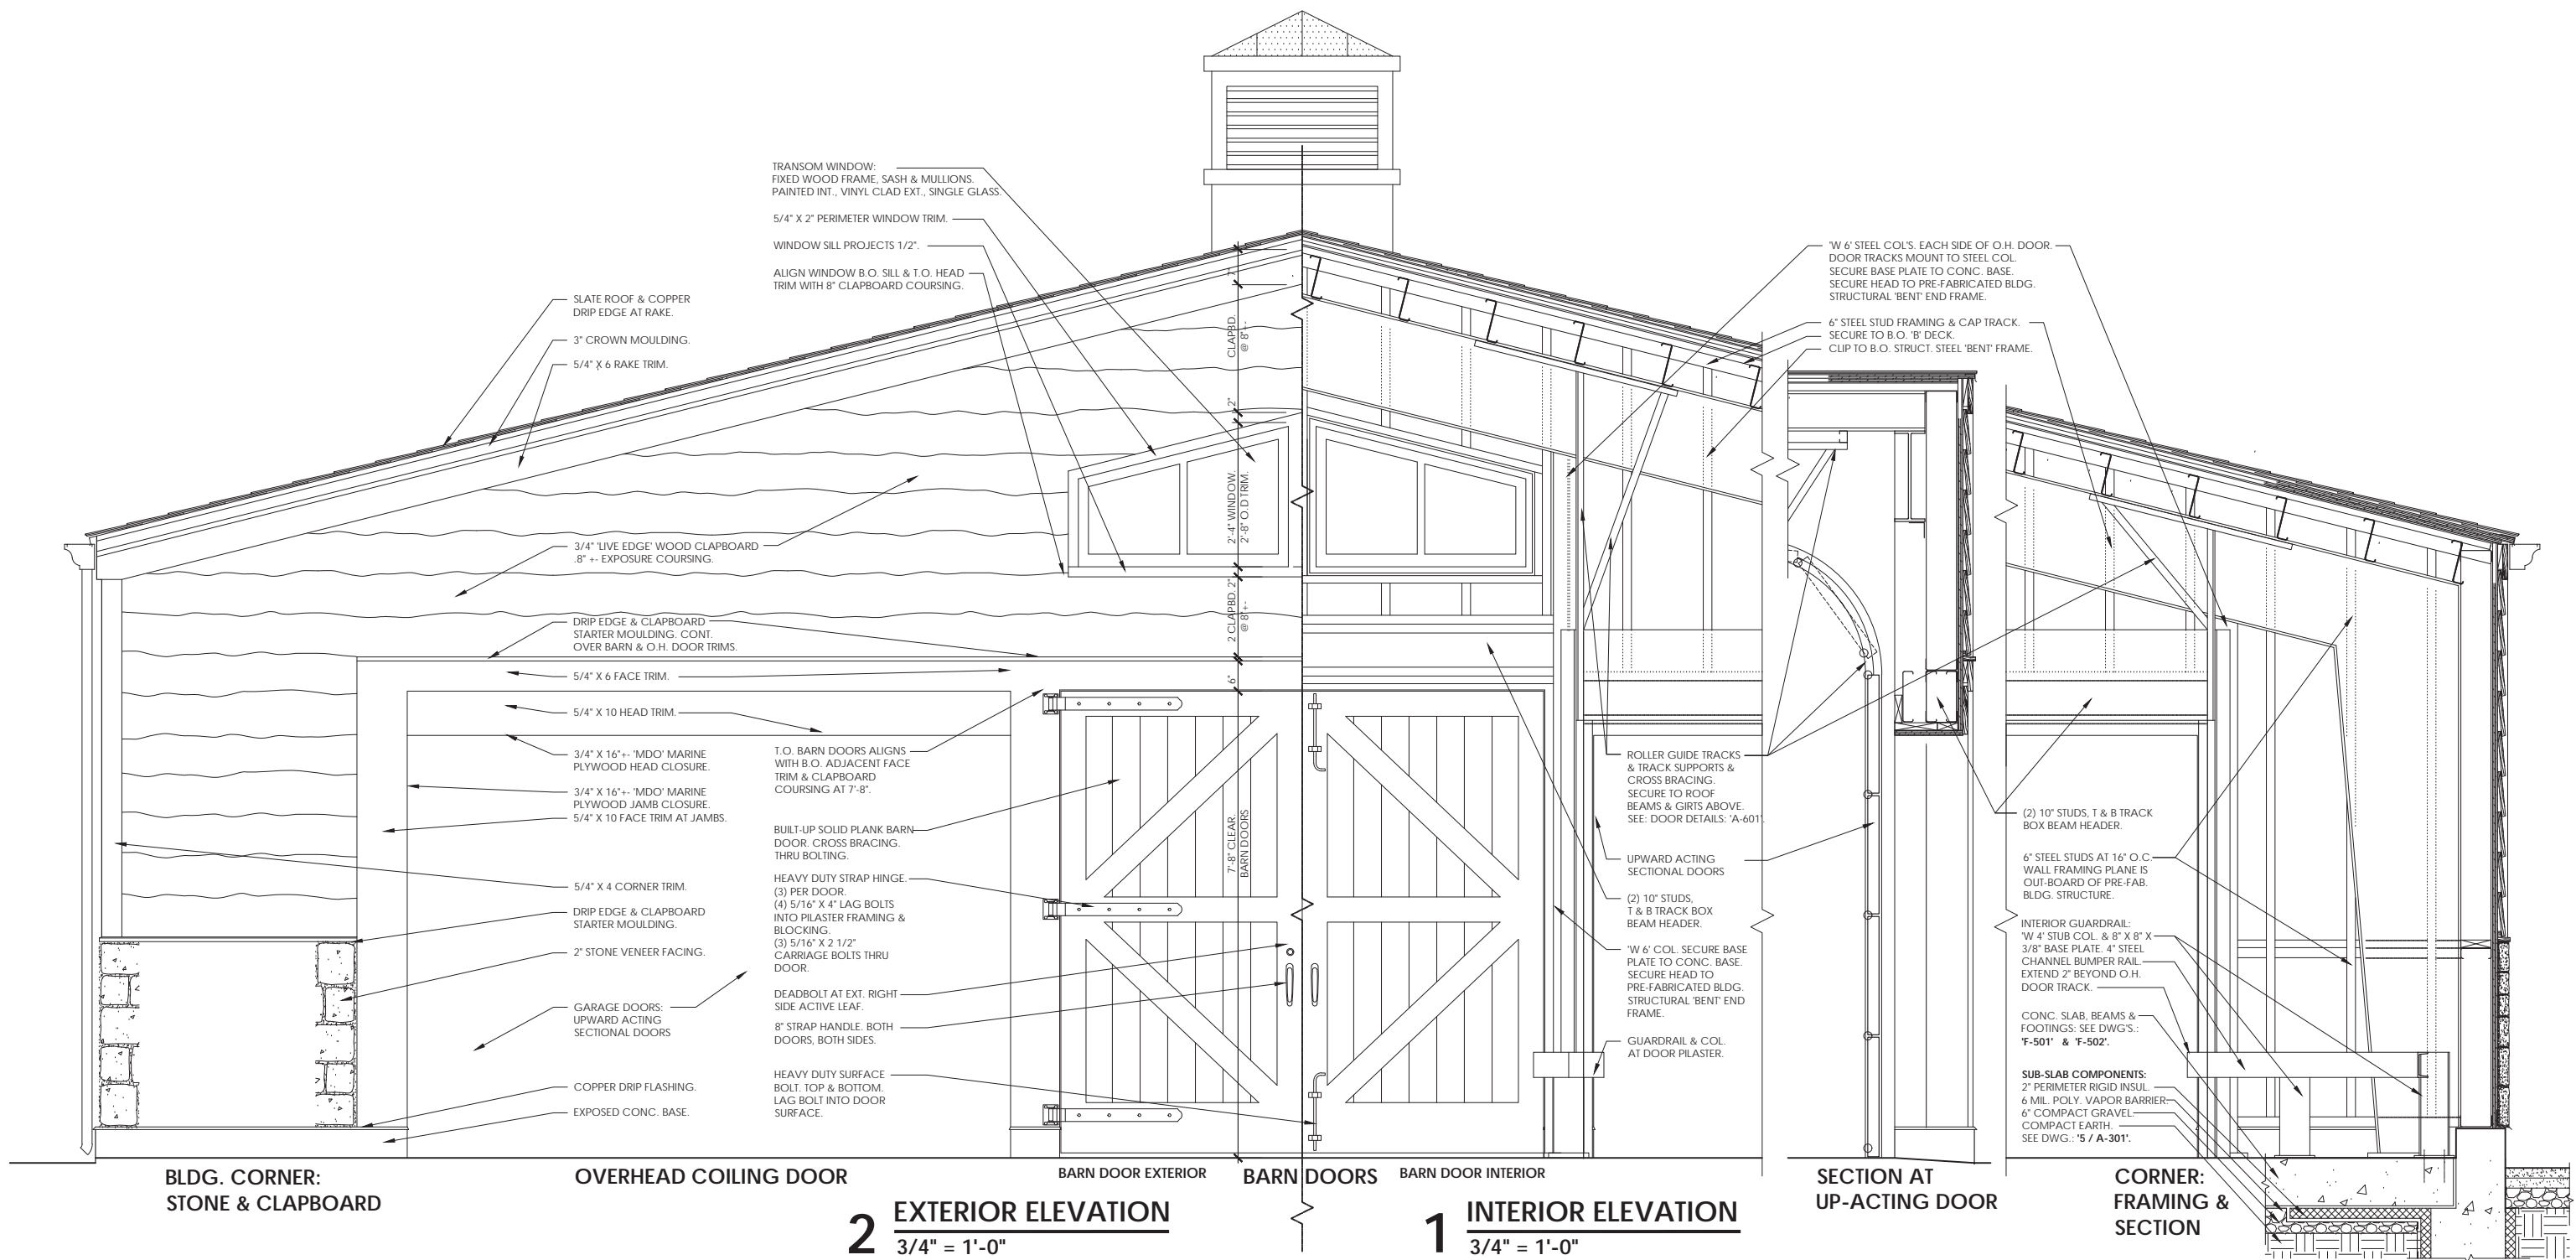3/4" FIRE RETARDANT PLYWOOD SHEATHING AT VALLEY PAN.

2 X 6 PPT JOISTS @ 16" O.C.

2 X 4 PPT BEARING SEAT.

2 X 6 PPT HEADER.

(2) STEEL CHANNEL LEDGERS. SPAN BET. STRUCT. 'BENT' FRAMES.

COPPER VALLEY PAN BETWEEN NEW CART SHED & EX'G. PRO SHED. FULL LENGTH OF PRO SHED BLDG. PAN SHALL BE FULLY SOLDERED PAN INTEGRATED WITH COPPER FLASHINGS UNDER SLATE SHINGLES.

2 X 10 PPT BEARING SEAT.

COPPER FLASHING UNDER SLATE SHINGLES. INTEGRATE WITH VALLEY PAN.

SLATE SHINGLE ROOF ON PRO SHED.

3/4" FIRE RETARDANT PLYWOOD SHEATHING ON EX'G. PRO SHED RAFTERS.

NEW CART SHED

EX'G. PRO SHED

3 1/2" BATT INSUL. IN RAFTER BAYS.

1/2" GYP. WALLBOARD CLG. SECURE TO EX'G. RAFTERS.

EX'G. 2 X 6 RAFTERS REMAIN. PERFORM REPAIRS & REPLACEMENTS AS NEEDED.

EX'G. TIMBER POSTS & HEADER TO REMAIN AS SUPPORT OF EX'G. ROOF RAFTERS.

WOOD CLOSURE TRIMS & RELATED BLOCKING AT TOP OF PARTN. & EX'G. RAFTERS. REVIEW ACTUAL INTERSECTION IN FIELD WITH ARCH. & ESTABLISH PROFILE AS NEEDED.

WINDOW: 2" X 4 1/2" ALUM. FRAME. 1" INSUL. GLASS.

PLYWOOD WORK COUNTER @ 3'-0".

GYP. WALLBOARD PARTN.: 2 1/2" METAL STUDS @ 16" O.C. 5/8" GYP. W.B. EACH SIDE. 2 1/2" BATT INSUL.

6" HIGH CONC. LEDGE.

PRE-FABRICATED METAL BLDG. COMPONENTS:

1 1/2" 'B' METAL DECK.

ROOF PURLINS. PROVIDE ADDITIONAL PURLINS TO ACCOMMODATE ADDITIONAL LOADS FOR SLATE ROOF & PLY. SHEATHING.

STRUCTURAL STEEL 'BENT' FRAMES AT 23'-0" O.C. BAY SPACING.

6" STEEL STUD FRAMING & CAP TRACK. 5/4" X 8 EAVE TRIM. PPT BLOCKING BEHIND.

3/4" 'LIVE EDGE' WOOD CLAPBOARD. 8" +- EXPOSURE COURSING.

3/4" F.R. PLYWOOD SHEATHING. VAPOR PERMEABLE BLDG. WRAP.

(2) 6" STUDS, T & B TRACK BOX BEAM HEADER. PPT. SHIM BLOCK. TAPER TO SUIT.

2 X 8 PPT HEAD BLOCK.

5/4" X 4 WINDOW JAMB TRIM BEYOND. FLUSH WITH EAVE TRIM.

WINDOW: FIXED WOOD FRAME, SASH & MULLIONS. PAINTED INT., VINYL CLAD EXT., SINGLE GLASS.

2 X 8 PPT JAMB BLOCK EACH SIDE. 2 X 8 PPT SILL. CUT TO SUIT WALL WIDTH.


6" STUD BRACE BETWEEN VERT. STUDS. 2" THICK REAL STONE VENEER. GRAY GRANITE.

WATER-PROOF MEMBRANE.


30 OZ. COPPER DRIP FLASHING. 8" LEG UP BEHIND W.P. MEMBRANE. 3/4" PROJ. OVER CONC. FOUND. WALL.

CONC. FOUND. WALL EXTENDED TO PROVIDE RETAINING WALL FOR ASCENDING GRADE AT SOUTH-WEST CORNER OF CART SHED BLDG.


CONC. FOUND. WALL & FLOOR SLAB.

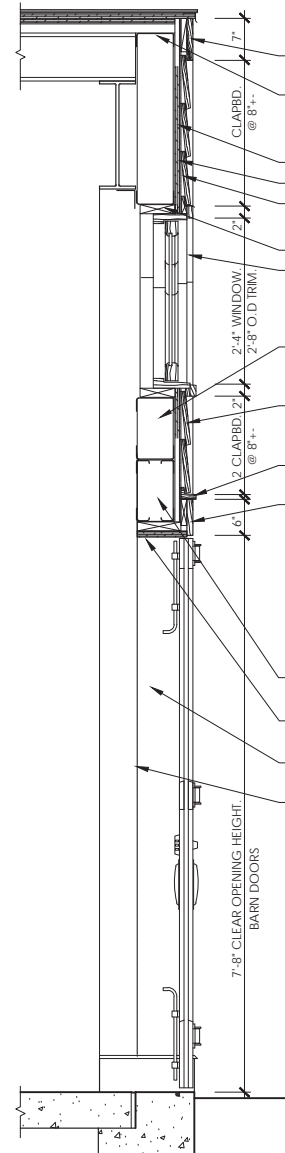


SEC. AT: TRANSOM  
& BARN DOOR  
3/4" = 1'-0"

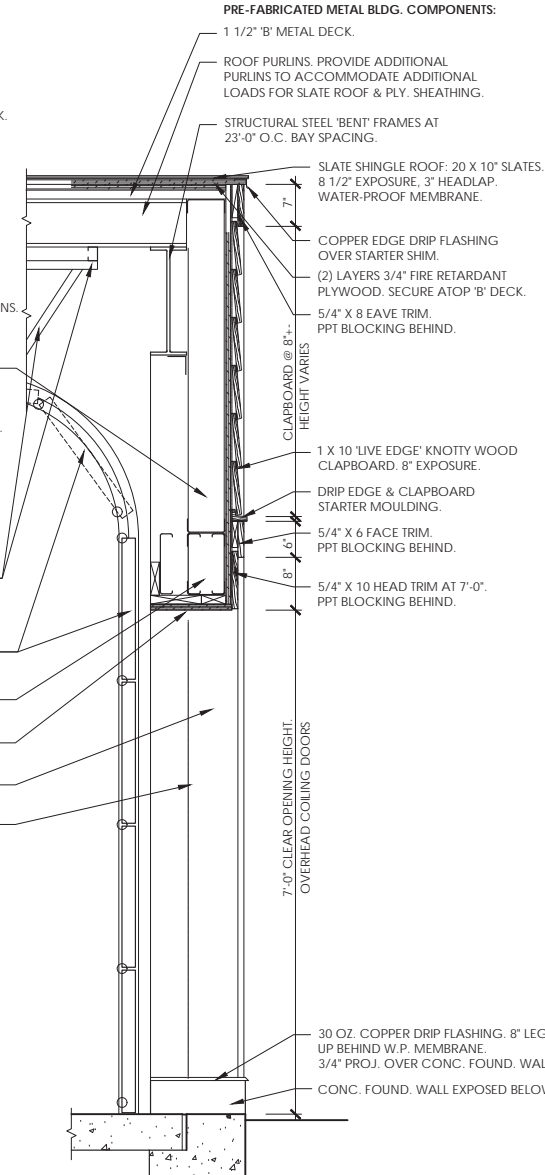

SEC. AT: UP-ACTING DOOR  
3/4" = 1'-0"

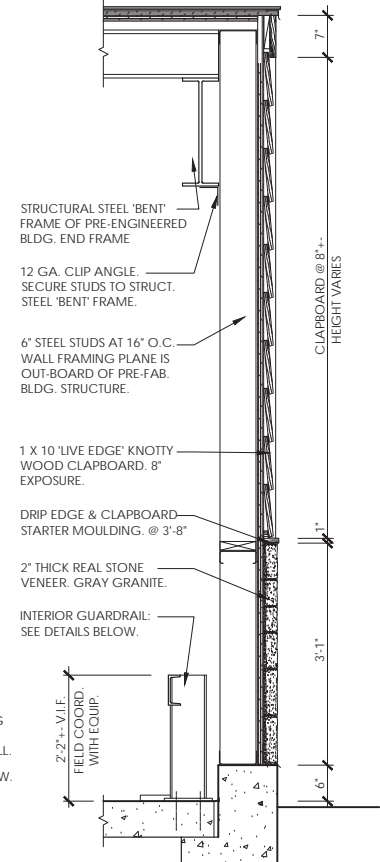


SEC. AT: STONE  
& CLAPBOARD  
3/4" = 1'-0"

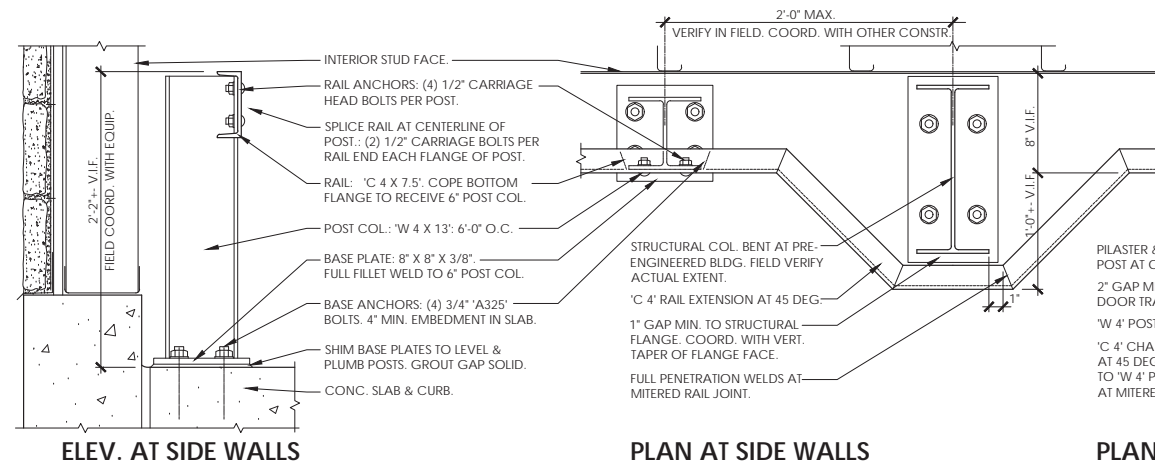

ELEV. AT SIDE WALLS

PLAN AT SIDE WALLS

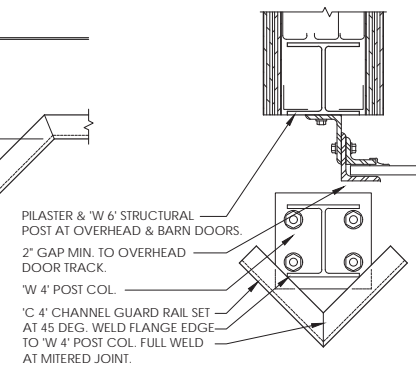


PLAN AT END WALL PILASTERS

6 CART SHED - INTERIOR GUARDRAIL  
1 1/2" = 1'-0"

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NAME	SIGNATURE	NAME	SIGNATURE	DATE
TITLE	DATE	TITLE	DATE	DATE
WESTCHESTER COUNTY, NEW YORK DEPARTMENT OF PUBLIC WORKS DIVISION OF ENGINEERING				
NEW GOLF CART STORAGE FACILITY AND CLUBHOUSE UPGRADES MOHANSIC GOLF COURSE, YORKTOWN, NEW YORK CART SHED -- WALL SECTIONS - DETAILS				
CONTRACT NUMBER 17-539	SHEET NUMBER A-302	SHEET NO. 14 OF 59		
SCALE: 3/4" = 1'-0"		DATE: 6/4/21		
DPW FILE NO.		REV. NO. 0		




**4** SEC. AT: STONE & CLAPBOARD  
3/4" = 1'-0"

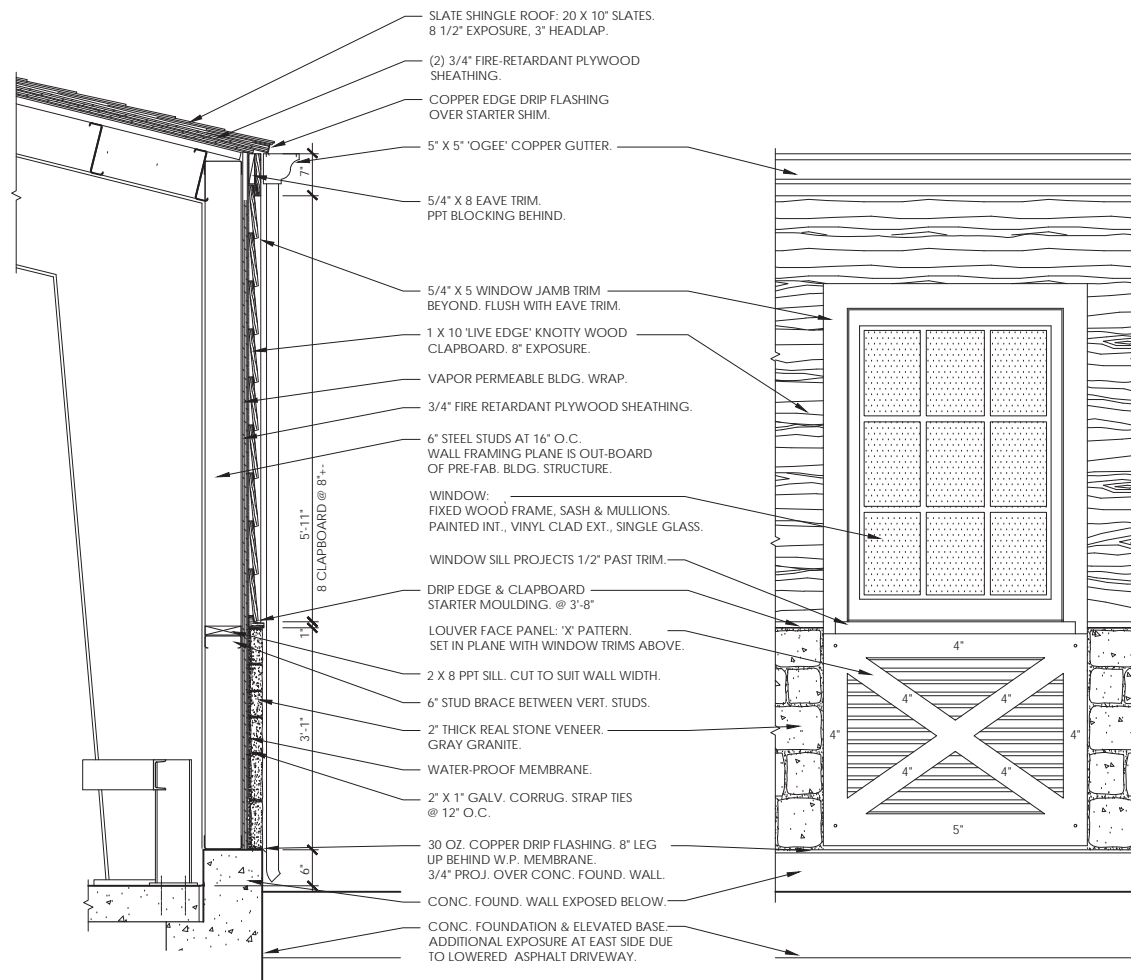
**3** EXT. ELEV. AT: WINDOW & LOUVER  
3/4" = 1'-0"

**2** INT. ELEV. AT: WINDOW & LOUVER  
3/4" = 1'-0"


**1** SEC. AT: WINDOW & LOUVER  
3/4" = 1'-0"

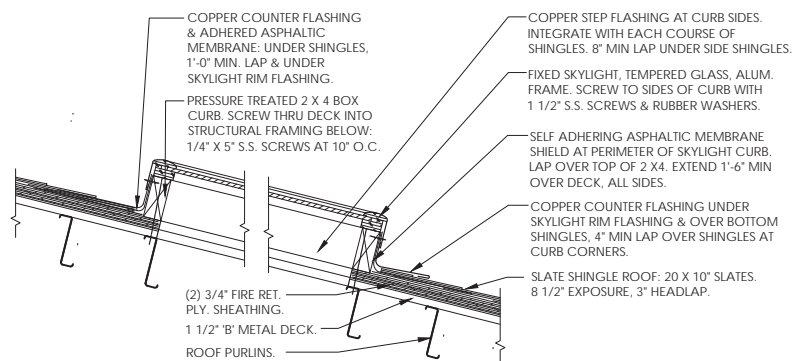

**6** SKYLIGHT & CURB  
1 1/2" = 1'-0"

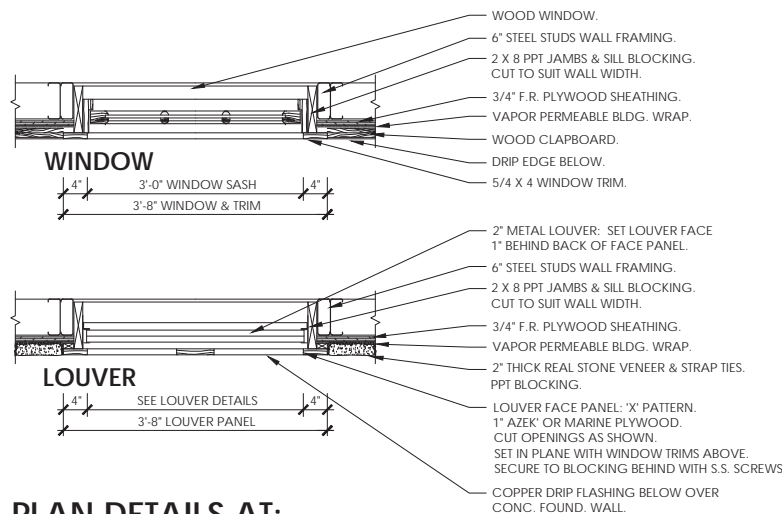


**5** PLAN DETAILS AT: WINDOW & LOUVER  
3/4" = 1'-0"

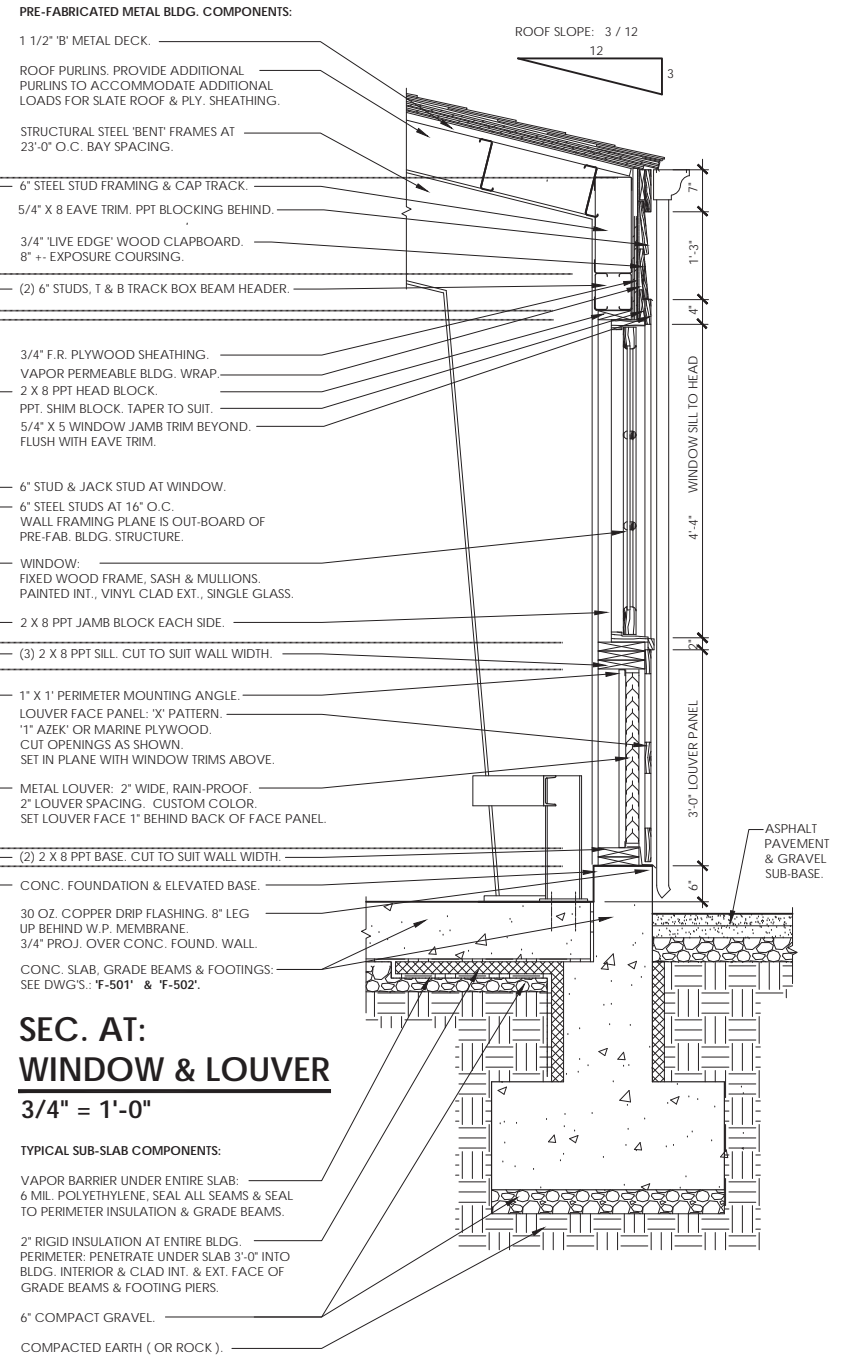

REVISION NUMBER	DATE	MADE BY	APP'D BY	REVISION
RECORD DRAWING CERTIFICATION				
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NAME	SIGNATURE	NAME	SIGNATURE	DATE
TITLE	DATE	TITLE	DATE	DATE
WESTCHESTER COUNTY, NEW YORK DEPARTMENT OF PUBLIC WORKS DIVISION OF ENGINEERING				CONTRACT NUMBER 17-539
NEW GOLF CART STORAGE FACILITY AND CLUBHOUSE UPGRADES MOHANSIC GOLF COURSE, YORKTOWN, NEW YORK CART SHED -- WALL SECTIONS - ELEVATIONS				SHEET NUMBER A-303
SCALE: 3/4" = 1'-0"				SHEET NO. 15 OF 59
DATE: 6/4/21				DPW FILE NO. 10-02-A-48
REV. NO. 0				


IN CHARGE OF ADAM KAPLINSKI RA  
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MADE BY JOHN W. LEVY RA

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## 2 CART SHED - DRIVEWAY GUARDRAIL

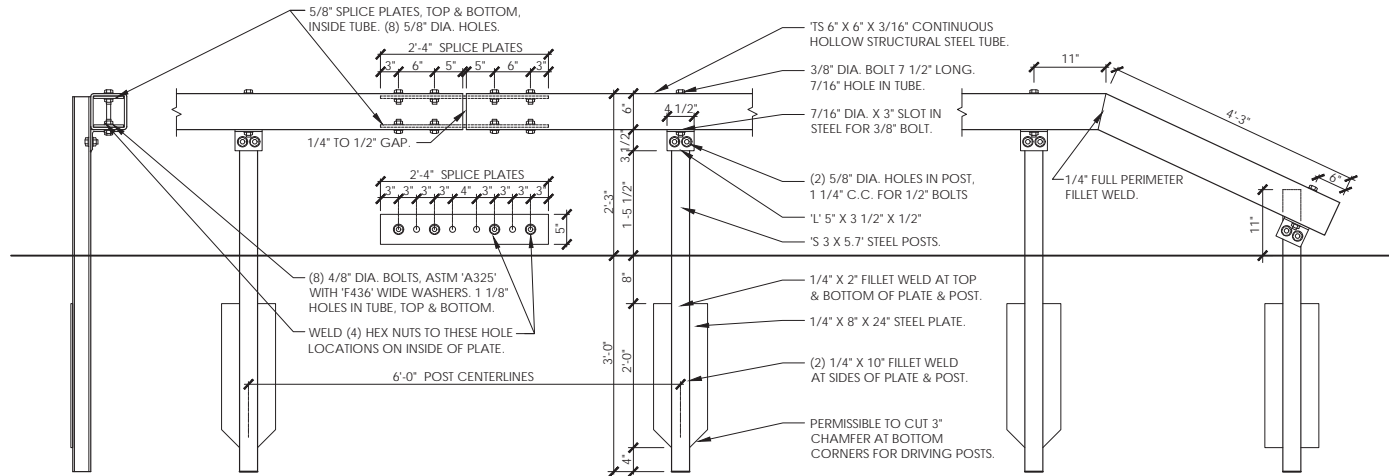3/4" = 1'-0"




SECTION AT BEAM & FLOOR DRAIN CHASE

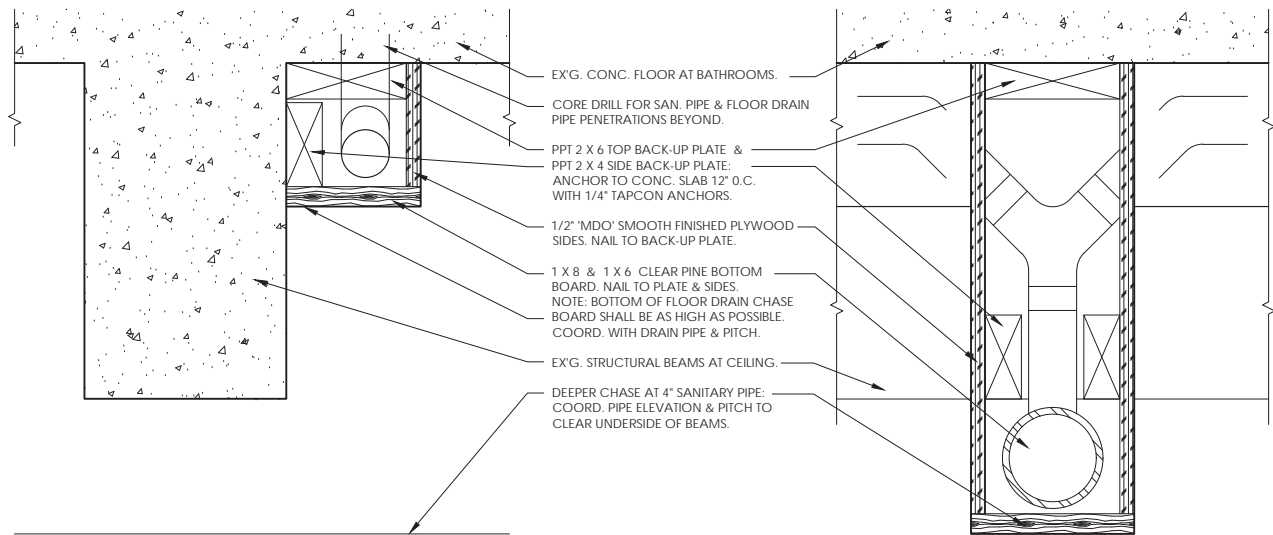SECTION AT MAIN SANITARY PIPE & CHASE


## 3 SANITARY & DRAIN PIPE CHASES

3" = 1'-0"

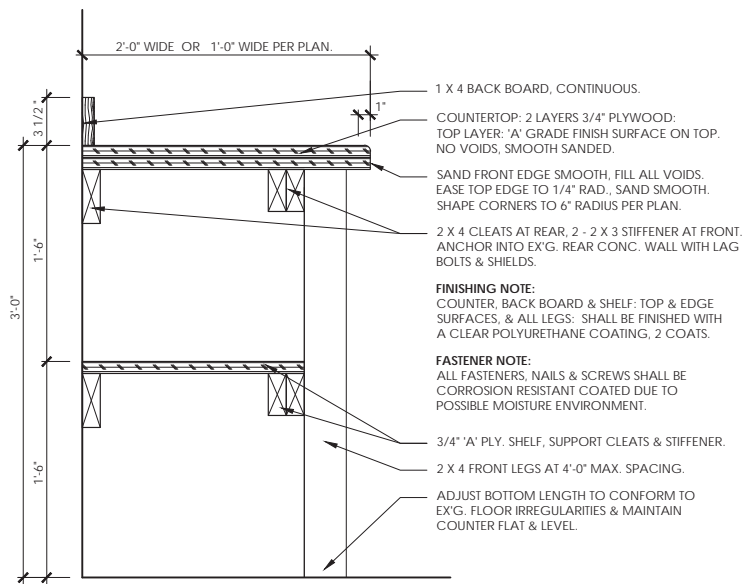


## 5 COUNTERS & SHELVES: PRO WORK SHED

1 1/2" = 1'-0"

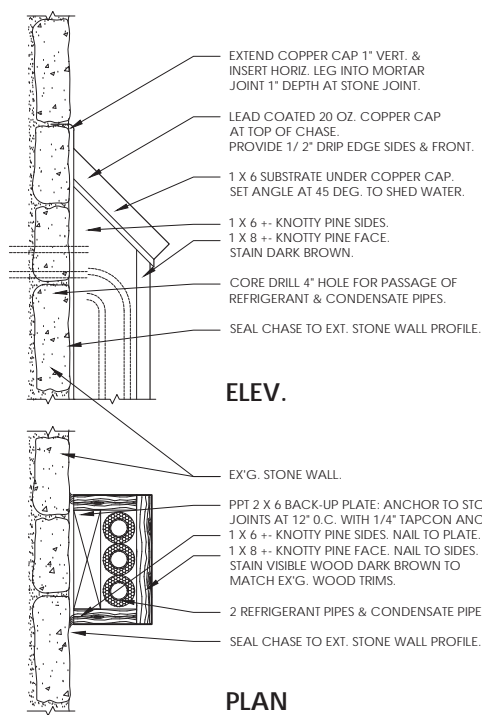

## 4 REFRIGERANT PIPE CHASE

3/4" = 1'-0"

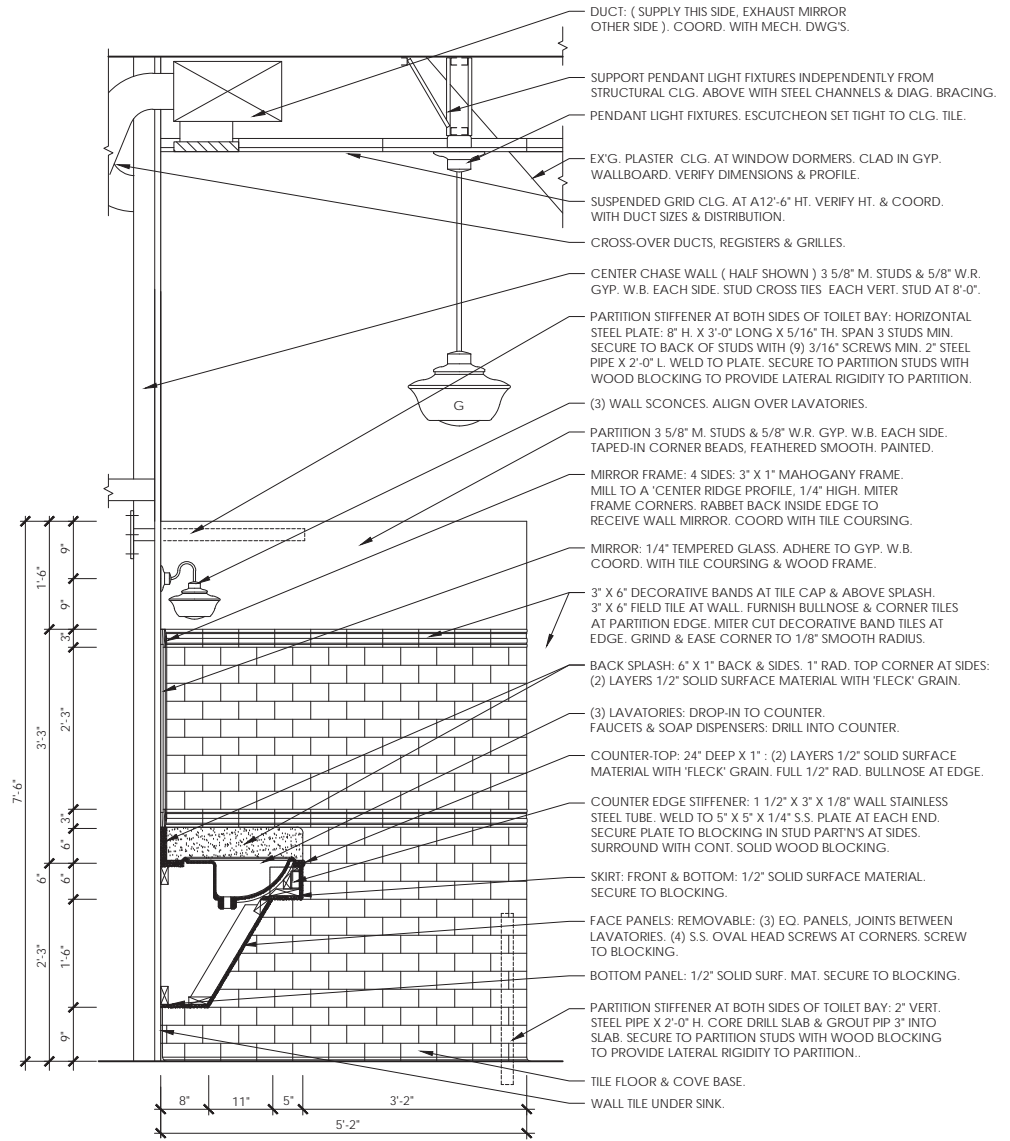

## 1 CLUBHOUSE -- BATHROOM COUNTER

3/4" = 1'-0"


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CONTRACTOR			PROJECT COORDINATOR	
NAME	SIGNATURE	DATE	NAME	SIGNATURE
TITLE	TITLE	DATE	TITLE	DATE
WESTCHESTER COUNTY, NEW YORK			CONTRACT NUMBER	SHEET NUMBER
DEPARTMENT OF PUBLIC WORKS			17-539	A-501
DIVISION OF ENGINEERING			SHEET NO. 16	OF 59
NEW GOLF CART STORAGE FACILITY AND CLUBHOUSE UPGRADES			SCALE: 3/4" = 1'-0"	DATE: 6/4/21
MOHANSIC GOLF COURSE, YORKTOWN, NEW YORK			DPW FILE NO.	REV. NO.
			10-02-A-49	0

IN CHARGE OF ADAM KAPLINSKI RA


CHECKED BY ADAM KAPLINSKI RA

MADE BY JOHN W. LEVY RA


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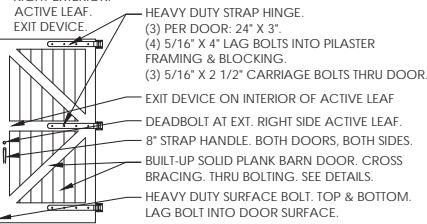
3'-0" X 7'-0" DOOR  
**TYPE 'A'**  
H.M. SINGLE DOOR

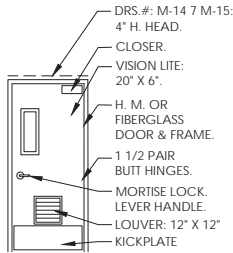

6'-0" X 7'-0" DOOR  
**TYPE 'B'**  
WOOD SINGLE DOOR

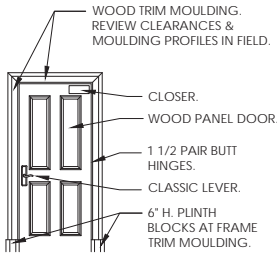


8'-0" X 7'-8" DOOR  
**TYPE 'BARN'**  
DOUBLE 'BARN STYLE' DOORS

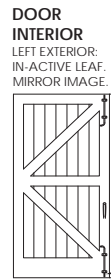


SEE SCHEDULE  
**TYPE 'O'**  
GARAGE DOORS:  
UPWARD ACTING SECTIONAL DOORS.

## 4 DOOR TYPES


1/4" = 1'-0"

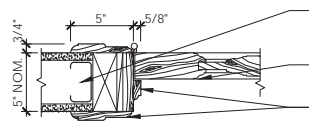


DRS. # CH-1 & CH-2  
DRS. # CH-3 & CH-4: SIMILAR  
**TYPE 'B': WOOD FRAME**

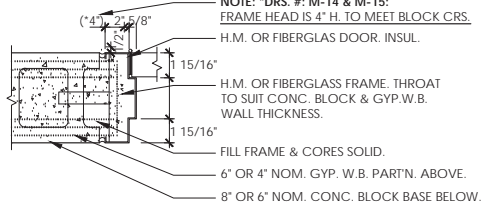

**TYPE 'A': H.M. FRAME**

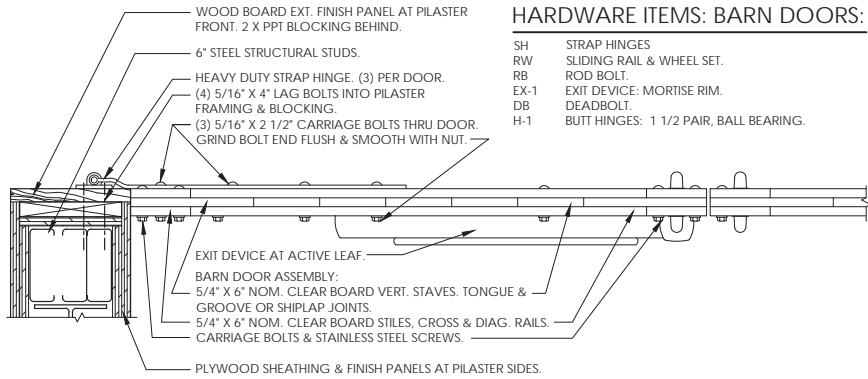

**BARN DOOR FRAME.**

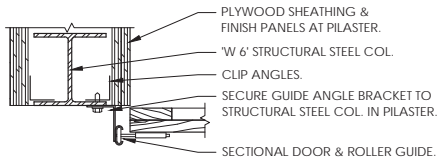

**SECTIONAL DOOR FRAME.**

## 5 FRAME DETAILS

3" = 1'-0"

DOOR #	DOOR SIZE	DOORS			FRAMES		HARDWARE	REMARKS
		MAT'L.	TYPE	LABEL	MAT'L.	TYPE		

### GOLF CART SHED.

G 1 PRO SHED	7'-0" x 3'-0" x 1 3/4"	H.M.	A		H. M.	A	H-1, L-E, T-1, WS	
G 2 PRO SHED	7'-0" x 3'-0" x 1 3/4"	H.M.	A		H. M.	A	H-1, L-E, T-1, WS	

### CLUBHOUSE

CH 1 MENS RM.	7'-0" x 3'-0" x 1 3/4"	WOOD	B		WOOD	B	H-1, L-E, T-1	
CH 2 WOMENS RM.	7'-0" x 3'-0" x 1 3/4"	WOOD	B		WOOD	B	H-1, L-E, T-1	KEYED FOR DAYTIME PASSAGE FUNCTION
CH 3 STORAGE 1	7'-0" x 3'-0" x 1 3/4"	WOOD	B		WOOD	B	H-1, L-E, T-1	
CH 4 STORAGE 2	7'-0" x 3'-0" x 1 3/4"	WOOD	B		WOOD	B	H-1, L-E, T-1	

## 1 METAL & WOOD DOORS -- SCHEDULE & HARDWARE

DOOR #	DOOR SIZE	DOORS			FRAMES		HARDWARE	REMARKS
		MAT'L.	TYPE	LABEL	MAT'L.	TYPE		

### GOLF CART SHED.

GO 1 GOLF CART STOR.	10'-0" x 7'-8" 'C' SLAT	WOOD	O		STEEL	ANGLE GUIDES	CH, DB	NON- INSUL.
GO 2 GOLF CART STOR.	10'-0" x 7'-8" 'C' SLAT	WOOD	O		STEEL	ANGLE GUIDES	CH, DB	NON- INSUL.
GO 3 GOLF CART STOR.	10'-0" x 7'-8" 'C' SLAT	WOOD	O		STEEL	ANGLE GUIDES	CH, DB	NON- INSUL.
GO 4 GOLF CART STOR.	10'-0" x 7'-8" 'C' SLAT	WOOD	O		STEEL	ANGLE GUIDES	CH, DB	NON- INSUL.

## 2 UP-ACTING SECTIONAL DOORS -- SCHEDULE & HARDWARE

DOOR #	DOOR SIZE	DOORS			FRAMES		HARDWARE	REMARKS
		MAT'L.	TYPE	LABEL	MAT'L.	TYPE		

### GOLF CART SHED.

GB 1 GOLF CART STOR.	(2) 4'-0" x 7'-8" x 2 1/4"	WOOD	BARN		WOOD	SEE DETAILS	SH, RB, EX-1 ( ACTIVE LEAF )	SWING DOORS
GB 2 GOLF CART STOR.	(2) 4'-0" x 7'-8" x 2 1/4"	WOOD	BARN		WOOD	SEE DETAILS	SH, RB, EX-1 ( ACTIVE LEAF )	SWING DOORS

## 3 WOOD BARN DOORS -- SCHEDULE & HARDWARE

### HARDWARE ITEMS: SECTIONAL DOORS:

MD	MOTOR DRIVE HOIST
CH	CHAIN HOIST
DB	DEADBOLT & LOCK

### HARDWARE ITEMS: H.M. & WOOD DOORS:

H-1	BUTT HINGES: 1 1/2 PAIR, BALL BEARING.	HARDWARE-TYPICAL SPEC: HEAVY DUTY SERIES, RE-CORE CYLINDERS, COORD. WITH OWNER MASTER KEY SYSTEM.
EX-1	EXIT DEVICE: MORTISE RIM.	
EX-2	EXIT DEVICE: CONCEALED ROD DOUBLE DOORS.	
L-E	BORED LOCK: KEYED ENTRY.	
L-B	BORED LOCK: BATHROOM LOCK.	
L-P	BORED LOCK: PASSAGE LATCH.	
S-1	FLOOR STOP.	
C-1	CLOSER.	
K-1	KICKPLATE.	
T-1	THRESHOLD / SADDLE.	
VL	VISION LITE	EGRESS NOTE: ALL DOOR HARDWARE SHALL PROVIDE FREE ACCESS IN DIRECTION OF EGRESS ALWAYS.
LV	LOUVER	
WS	WEATHERSTRIPPING.	
AS	ASTRAGAL.	
DC	DOOR COORDINATOR.	

IN CHARGE OF ADAM KAPLINSKI RA  
CHECKED BY ADAM KAPLINSKI RA  
MADE BY JOHN W. LEVY RA

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REVISION NUMBER	DATE	MADE BY	APP'D BY	REVISION
RECORD DRAWING CERTIFICATION				
<input type="checkbox"/> AS BUILT -- CHANGES AS NOTED <input type="checkbox"/> AS BUILT -- NO CHANGES				
CONTRACTOR		PROJECT COORDINATOR		
NAME	SIGNATURE	NAME	SIGNATURE	DATE
TITLE	DATE	TITLE	DATE	
WESTCHESTER COUNTY, NEW YORK DEPARTMENT OF PUBLIC WORKS DIVISION OF ENGINEERING				CONTRACT NUMBER 17-539 SHEET NUMBER A-601
NEW GOLF CART STORAGE FACILITY AND CLUBHOUSE UPGRADES MOHANSIC GOLF COURSE, YORKTOWN, NEW YORK DOOR SCHEDULE & DETAILS				SHEET NO. 17 OF 59 SCALE: 3/4" = 1'-0" DATE: 6 / 4 / 21 DPW FILE NO. 10-02-A-50 REV. NO. 0

ABBREVIATIONS			
ADD	ADDENDUM		
ADJ	ADJACENT	HVAC	HEATING VENTILATION & AIR CONDITIONING
AFF	ABOVE FINISH FLOOR	IN	INCH
ALT	ALTERNATE	INSUL	INSULATION
ALUM	ALUMINUM	LAM	LAMINATE (D)
ARCH	ARCHITECT (URAL)	LL	LIVELOAD
ARF	ABOVE RAISED FLOOR	LP	LOW POINT
BD	BOARD	MAINT	MAINTENANCE
BLDG	BUILDING	MAX	MAXIMUM
BLK	BLOCK	MECH	MECHANICAL
BOF	BOTTOM OF FOOTING	MEP	MECH ELECTRICAL PLUMBING
BRG	BEARING	MFR (D)	MANUFACTURE ® (D)
BRK	BRICK	MIN	MINIMUM
BSMT	BASEMENT	MISC	MISCELLANEOUS
BUR	BUILT UP ROOFING	MO	MASONRY OPENING
CB	CATCH BASIN	MTL	METAL
CEM	CEMENT	N	NORTH
CI	CAST IRON	(N)	NEW
CLG	CEILING	NIC	NOT IN CONTRACT
CLR	CLEAR (ANCE)	NO	NUMBER
CMU	CONCRETE MASONRY UNIT	NOM	NOMINAL NUMBER
COL	COLUMN	NTS	NOT TO SCALE
CONC	CONCRETE	OA	OVERALL
CONST	CONSTRUCTION	OC	ON CENTER
CJ	CONSTRUCTION JOINT	OH	OVERHEAD
CONT	CONTINUOUS	OPNG	OPENING
COORD.	COORDINATE	OPP	OPPOSITE
CTR	CENTER	P	PIER
DEMO	DEMOLITION	PC	POURED CONCRETE
DEPT	DEPARTMENT	R	RISER
DIA	DIAMETER	PNL	PANEL
DIAG	DIAGONAL	PSF	POUNDS PER SQUARE FOOT
DIM	DIMENSION	PTN	PARTITION
DIV	DIVISION	PVC	POLYVINYL CHLORIDE
DL	DEAD LOAD	R	RISER
DN	DOWN	RA	RAISED ACCESS
DP	DAMP PROOFING	RAD	RADIUS
DR	DOOR	RD	ROOF DRAIN
DTL	DETAIL	REF	REFERENCE
DWG	DRAWING	REINF	REINFORCED
E	EAST	RFG	ROOFING
EA	EACH	ROOM	ROOM
ELEC	ELECTRIC (AL)	RO	ROUGH OPENING
EL	ELEVATION (TOPO)	S	SOUTH
EMERGE	EMERGENCY	SD	STORM DRAIN
ENCL	ENCLOSE (ENCLOSURE)	SECT	SECTION
EQ	EQUAL	SF	SQUARE FOOT
EW	EACH WAY	SIM	SIMILAR
EXC	EXCAVATE	SPEC	SPECIFICATION
EXIST (E)	EXISTING	SQ	SQUARE
EJ	EXPANSION JOINT	STD	STANDARD
EXT	EXTERIOR	STL	STEEL
FD	FLOOR DRAIN	STOR	STORAGE
F	FOOTING	SUSP	SUSPENDED
FDN	FOUNDATION	TGB	TOP GRADE BEAM
FIN	FINISH	THK	THICK (NESS)
FLR	FLOOR	TO	TOP OF
FP	FIREPROOF (ING)	TOS	TOP OF STEEL
FT	FEET	TOW	TOP OF WALL
FTG	FOOTING	TYP	TYPICAL
GA	GAGE, GAUGE	UN	UNLESS OTHERWISE NOTED
GALV	GALVANIZED	VIF	VERIFY IN FIELD
GC	GENERAL CONTRACT (OR)	W	WEST
GB	GRADE BEAM	W/	WITH
HC	HOLLOW CORE	WD	WOOD
HDR	HEADER	WM	WIRE MESH
HDW	HARDWARE	W/O	WITHOUT
HGT	HEIGHT	WP	WATERPROOFING
HM	HOLLOW METAL	WWM	WELDED WIRE MESH
HP	HIGH POINT	WWF	WELDED WIRE FABRIC
HSS	HOLLOW STRUCTURAL SECT		
HTG	HEATING		

IN CHARGE OF KJM  
CHECKED BY KJM  
MADE BY TJR/AGS

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### GENERAL NOTES:

- ALL WORK SHALL CONFORM TO THE REQUIREMENTS OF THE 2020 NEW STATE BUILDING CODE.
- CONTRACTOR SHALL FIELD MEASURE AND VERIFY ALL EXISTING CONDITIONS. DISCREPANCIES SHALL BE REPORTED TO THE ARCHITECT OR ENGINEER AND RESOLVED PRIOR TO PROCEEDING WITH THE WORK.
- ALL WORK SHALL COMPLY WITH THE RULES AND REGULATIONS OF ALL GOVERNMENTAL AGENCIES HAVING JURISDICTION.
- THE CONTRACTOR SHALL BE RESPONSIBLE FOR VISITING THE SITE AND FAMILIARIZING HIMSELF WITH EXISTING CONDITIONS.
- THE CONTRACTOR SHALL BE SOLELY RESPONSIBLE FOR ALL SAFE WORKING CONDITIONS AND SHALL OBSERVE ALL SAFETY REQUIREMENTS ESTABLISHED BY JURISDICTIONAL AGENCIES AND THE OWNER. WHERE CONFLICTS EXIST, THE MORE STRINGENT REQUIREMENTS SHALL APPLY. CARE SHALL BE EXERCISED TO AVOID ENDANGERING PERSONAL OR THE STRUCTURE.
- FURNISH ALL SCAFFOLDING, HOISTING EQUIPMENT AND ANY OTHER EQUIPMENT THAT MAY BE REQUIRED TO PERFORM THE WORK INDICATED IN A SAFE AND ORDERLY MANNER.
- THE CONTRACTOR SHALL REPAIR, AT NO COST TO THE OWNER, ANY DAMAGE CAUSED BY HIM DURING OR RESULTING FROM HIS OPERATIONS.
- CONTRACTOR SHALL REPLACE ALL EXISTING CONSTRUCTION BEING REMOVED FOR CONSTRUCTION PURPOSES. MATCH EXISTING CONSTRUCTION IN KIND.
- AFTER CHECKING AND VERIFYING ALL FIELD MEASUREMENTS, CONTRACTOR SHALL SUBMIT SHOP DRAWINGS, FULL, COMPLETE, AND DETAILED AS PER INDUSTRY STANDARDS, AND BEARING A STAMP OR WRITTEN INDICATION THAT CONTRACTOR HAS SATISFIED HIS RESPONSIBILITY WITH RESPECT TO THE REVIEW OF THE SUBMISSION.
- CONTRACTOR SHALL HAVE DETERMINED AND VERIFIED ALL QUANTITIES, DIMENSIONS, SPECIFIED PERFORMANCE CRITERIA, INSTALLATION REQUIREMENTS, MATERIALS AND SIMILAR DATA, AND REVIEWED OR COORDINATED EACH SHOP DRAWING WITH OTHER SHOP DRAWINGS AND WITH THE REQUIREMENTS OF THE WORK AND THE CONTRACT DOCUMENTS.
- ENGINEER WILL REVIEW AND APPROVE SHOP DRAWINGS WITH REASONABLE PROMPTNESS, BUT ENGINEER'S REVIEW AND APPROVAL WILL BE ONLY FOR CONFORMANCE WITH THE DESIGN CONCEPT AND FOR COMPLIANCE WITH THE INFORMATION GIVEN IN THE CONTRACT DOCUMENTS AND SHALL NOT EXTEND TO MEANS, METHODS, TECHNIQUES, SEQUENCES OR PROCEDURES OF CONSTRUCTION, OR TO SAFETY PRECAUTIONS OR PROGRAMS INCIDENT THERETO.
- ENGINEER'S REVIEW AND APPROVAL OF SHOP DRAWINGS OR SAMPLES SHALL NOT RELIEVE CONTRACTOR FROM RESPONSIBILITY FOR ANY VARIATION FROM THE REQUIREMENTS OF THE CONTRACT DOCUMENTS UNLESS CONTRACTOR HAS IN WRITING CALLED ENGINEER'S ATTENTION TO EACH SUCH VARIATION AT THE TIME OF SUBMISSION AND ENGINEER HAS GIVEN WRITTEN APPROVAL OF EACH SUCH VARIATION BY A SPECIFIC WRITTEN NOTATION ON SHOP DRAWING; NOR WILL ANY APPROVAL BY ENGINEER RELIEVE CONTRACTOR FROM RESPONSIBILITY FOR ERRORS OR OMISSIONS IN THE SHOP DRAWINGS OR FROM RESPONSIBILITY FOR HAVING COMPLIED WITH THE PROVISIONS OF NOTE 10.
- MATERIALS SHALL NOT BE FABRICATED OR DELIVERED TO THE SITE BEFORE THE SHOP DRAWINGS HAVE BEEN APPROVED.
- UPON COMPLETION OF WORK, ALL EXCESS MATERIAL, DEBRIS, ETC., SHALL BE REMOVED AND WORK AREA LEFT CLEAN TO THE OWNER'S SATISFACTION.
- STRUCTURAL DESIGN COMPLIES WITH THE 2016 EDITION OF THE NEW YORK STATE BUILDING CODE.
- CONTRACTOR MUST NOTIFY THE COUNTY REPRESENTATIVE OF WORK PROGRESS SO THAT REGULAR PERIODIC INSPECTION OF ALL ASPECTS OF THE CONSTRUCTION WORK INCLUDING EXCAVATION, SUBGRADES, PILE DRIVING/INSTALLATION, REINFORCEMENT PLACEMENT, CONCRETE PLACEMENT, MASONRY CONSTRUCTION, FRAMING, ETC., WORK CANNOT PROCEED WITHOUT APPROVAL OF AT EACH PHASE OF THE WORK.

### CONTROLLED FILL:

- ALL FILL BELOW THE BUILDING WALLS AND ALL BACKFILL AGAINST BUILDING WALLS SHALL BE CONTROLLED FILL. COMPACTED TO 95% OF THE MAXIMUM MODIFIED PROCTOR DENSITY WHEN TESTED IN ACCORDANCE WITH ASTM D 1557.
- ALL BORROW MATERIAL SHALL BE APPROVED PRIOR TO BEING PLACED.
- FILL SHALL BE PLACED IN LIFTS NOT EXCEEDING 12 INCHES AND SHALL BE COMPACTED PRIOR TO PLACEMENT OF NEXT LIFT.
- CONTRACTOR SHALL PROVIDE FOR IN-PLACE DENSITY TESTING AS THE WORK PROGRESSES. ALL LIFTS MUST BE APPROVED BY THE SPECIAL INSPECTOR PRIOR TO PROCEEDING WITH THE NEXT LIFT.
- ALL SOIL COMPACTION SUBJECT TO SPECIAL INSPECTION.

### GEOTECHNICAL REPORT:

- THE RESULTS OF THE GEOTECHNICAL INVESTIGATION FOR THIS SITE ARE PRESENTED IN A REPORT PREPARED BY "THE GEOTECHNICAL DEPARTMENT LLC" DATED SEPTEMBER 20, 2016.
- RESULTS OF TEST BORINGS INDICATED ON DRAWING B-100.
- ALL SITE AND FOUNDATION WORK SHALL BE COORDINATED WITH RECOMMENDATIONS IN THE GEOTECHNICAL REPORT.

### MASONRY

- ALL MASONRY MATERIALS AND CONSTRUCTION SHALL BE IN ACCORDANCE WITH THE REQUIREMENTS OF THE SPECIFICATION FOR THE DESIGN AND CONSTRUCTION OF LOAD-BEARING CONCRETE MASONRY BY THE NATIONAL CONCRETE MASONRY ASSOCIATION.
- LOAD BEARING BLOCK SHALL MEET THE FOLLOWING MINIMUM REQUIREMENTS: HOLLOW BLOCK: ASTM C90 UNIT COMPRESSIVE STRENGTH 2000 PSI (MIN) BASED ON NET AREA. SOLID BLOCK: ASTM C145 UNIT COMPRESSIVE STRENGTH 2000 PSI (MIN) BASED ON GROSS AREA.
- MORTAR FOR BLOCK CONSTRUCTION SHALL BE TYPE M OR S IN ACCORDANCE WITH ASTM C270.
- GROUT FOR SOLID FILLED BLOCK, WITH OR WITHOUT REINFORCING, SHALL BE 4,000PSI IN ACCORDANCE WITH ASTM C476. GROUT FILLED HOLLOW BLOCK MAY BE USED IN LIEU OF SOLID BLOCK WHERE PLANS INDICATE SOLID BLOCK.
- UTILIZE HIGH-LIFT OR LOW-LIFT GROUTING TECHNIQUE IN ACCORDANCE WITH ABOVE CODES WHERE GROUTING IS NECESSARY.
- HORIZONTAL JOINT REINFORCING SHALL BE PROVIDED AT EVERY SECOND COURSE, AND SHALL BE 3/16" X 9 GAUGE ELECTROLYTICALLY WELDED TRUSS TYPE, GALVANIZED, WIRE REINFORCING WIDTH SIZED TO WALL CONDITION. USE DUR-O-WAL OR EQUAL.
- ALL MASONRY ANCHORS SHALL BE GALVANIZED.
- ALL VERTICAL BAR REINFORCEMENT SHALL BE EPOXY COATED.

### FOUNDATION:

- ALL FOOTINGS SHALL BEAR SOUND ROCK, HAVING A MINIMUM SAFE BEARING CAPACITY OF 3.0 TONS PER SQUARE FOOT.
- ROCK SHALL BE BENCHED AND LEVELED TO RECEIVE FOOTINGS.
- NO FOOTING CONCRETE SHALL BE PLACED PRIOR TO INSPECTION AND CERTIFICATION OF BY THE SPECIAL INSPECTOR.
- ELEVATIONS OF FOOTINGS ARE SUBJECT TO CHANGE IN THE FIELD IN ORDER TO SATISFY BEARING REQUIREMENTS.
- FOOTING - BOTTOM ELEVATION ARE SHOWN ON PLAN.
- COORDINATE ALL GROUND ELEVATIONS, INTERIOR AND EXTERIOR, WITH APPROVED SITE PLANS AND ARCHITECTURAL PLANS.
- BACKFILL AGAINST BOTH SIDES OF FOUNDATION WALLS, GRADE BEAMS, OR PIERS MUST BE PLACED IN A BALANCED MANNER.
- ALL BACKFILL AT WALLS AND GRADE BEAMS SHALL BE CONTROLLED COMPACTED FILL, SUBJECT TO TESTING AND SPECIAL INSPECTIONS.
- ALL BACKFILL SHALL BE COMPACTED UNDER SOIL ENGINEER'S SUPERVISION TO 95% OF MAXIMUM DENSITY IN ACCORDANCE WITH REQUIREMENTS OF ASTM D1556 AT OPTIMUM MOISTURE CONTENT SPECIFIED IN ASTM D1557.

### STRUCTURAL STEEL:

THE STRUCTURAL STEEL CONTRACTOR SHALL VERIFY THE FOUNDATION CONSTRUCTION FOR ANCHOR BOLT LOCATION, ELEVATION OF TOP OF CONCRETE OR BEARING PLATES, ALIGNMENT, ETC. PRIOR TO START OF ERECTION.

- FABRICATION AND ERECTION OF ALL STRUCTURAL STEEL SHALL CONFORM TO THE LATEST AISC SPECIFICATIONS FOR THE DESIGN, FABRICATION, AND ERECTION OF STRUCTURAL STEEL FOR BUILDINGS.
- ALL STEEL SHALL BE NEW, CLEAN AND STRAIGHT MEMBERS CONFORMING TO THE FOLLOWING ASTM MATERIAL STANDARD.

SHAPE/SECTION	ASTM MATERIAL STANDARD
W	A992
C/MC	A36
L	A36
HSS	A500 GRADE B
PIPE	A53 GRADE B
PLATES	A36
- ALL SHOP WORK TO BE WELDED OR HIGH STRENGTH BOTLS (3/4" DIAMETER ASTM A325 MINIMUM).
- STRUCTURAL FASTENERS SHALL CONFORM TO THE FOLLOWING ASTM MATERIAL STANDARD.

FASTENER TYPE	ASTM MATERIAL STANDARD
HIGH-STRENGTH, CONVENTIONAL BOLTS	A325, A490
HIGH-STRENGTH, TWIST-OFF, TYPE TENSION CONTROL BOLTS, COMMON BOLTS	F1852, FF2280
THREADED RODS	A307 GRADE B
ANCHOR RODS	A36
	F1554 GRADE 36

- ALL WELDING SHALL BE DONE BY CERTIFIED WELDERS, IN ACCORDANCE WITH AWS CODE.
- ALL COLUMNS SHALL BE FURNISHED WITH CAP PLATES AND BASE PLATES OF THE SIZE INDICATED AND SHALL BE SHOP WELDED.
- LEVELING PLATES UNDER COLUMN BASE PLATES SHALL BE SET TO EXACT GRADE AND LEVEL IN A BED OF NON-SHRINKING GROUT AT LEAST 5 DAYS PRIOR TO ERECTION OF THE MAIN FRAMING.
- PROVIDE HOLES, COPINGS, NAIL HOLES, ETC., AS REQUIRED IN STRUCTURAL STEEL MEMBERS FOR THE WORK OF OTHER TRADES. THEY SHALL BE SHOWN ON STRUCTURAL STEEL SHOP DRAWINGS AND SHALL BE SHOP MADE. FIELD BURNING OF HOLES OR CUTS IN STRUCTURAL STEEL MEMBERS WILL NOT BE PERMITTED, EXCEPT WITH THE SPECIFIC APPROVAL OF THE STRUCTURAL ENGINEER.
- SUBMIT SHOP DRAWINGS FOR APPROVAL BEFORE FABRICATION.
- CONTRACTOR TO COORDINATE OPENINGS ON ARCHITECTURAL AND MECHANICAL DRAWINGS WITH STRUCTURAL FRAMING PLAN.
- REPRODUCTION OF STRUCTURAL DESIGN DRAWINGS ARE NOT TO BE SUBMITTED AS SHOP DRAWINGS.
- PROVIDE TEMPORARY BRACING AS REQUIRED TO RESIST WIND, CONSTRUCTION LOADS, ETC. DURING ERECTION. BRACING TO REMAIN IN PLACE UNTIL ROOF DECK AND MASONRY WALLS ARE COMPLETELY INSTALLED.

### CONCRETE

- ALL CONCRETE CONSTRUCTION SHALL CONFORM TO ACI 318 BUILDING CODE REQUIREMENTS FOR REINFORCED CONCRETE AND PRACTICE FOR DETAILING OF REINFORCED CONCRETE, ALL AS AMENDED BY THE NEW YORK STATE BUILDING CODE.
- ALL CAST-IN-PLACE CONCRETE SHALL BE CONTROLLED STONE CONCRETE HAVING A MINIMUM 28-DAY COMPRESSIVE STRENGTH OF:
  - 4,000 PSI STRUCTURAL SLABS & SLAB-ON-GRADE.
  - 3,500 PSI FOOTINGS, PILE CAPS, WALLS AND GRADE BEAMS.
- MINIMUM CEMENT FACTOR 5.75 BAGS PER CUBIC YARD OF CONCRETE. CONTRACTOR SHALL SUPPLY CONCRETE HAVING A 28 DAY STRENGTH 25 PERCENT GREATER THAN THE DESIGN STRENGTH SPECIFIED.
- CONCRETE FOR FLOOR SLABS SHALL HAVE A MAXIMUM WATER CEMENT RATIO OF 0.40. ALL OTHER CONCRETE SHALL HAVE A MAXIMUM WATER CEMENT RATIO OF 0.45.
- CONCRETE MAY CONTAIN A WATER REDUCING ADMIXTURE, AND/OR HIGH RANGE WATER REDUCING ADMIXTURE (SUPERPLASTICIZER).
- ADMIXTURES SHALL CONFORM WITH ASTM C-494 REQUIREMENTS AND CONTAIN NO MORE CHLORIDE IONS THAN ARE PRESENT IN MUNICIPAL DRINKING WATER.
- ALL PUMPED CONCRETE, ARCHITECTURAL CONCRETE, CONCRETE FOR SLABS, AND OTHER CONCRETE WITH A WATER-CEMENT RATIO OF 0.45 OR LESS SHALL CONTAIN THE HIGH RANGE WATER REDUCING ADMIXTURE (SUPERPLASTICIZER).
- NON-CHLORINE ACCELERATING ADMIXTURES SHALL BE USED IN ALL CONCRETE SLABS PLACED AT TEMPERATURES BELOW 50 DEGREES F. ADMIXTURE SHALL CONFORM WITH ASTM C-494 REQUIREMENTS, AND CONTAIN NO MORE CHLORINE IONS THAN ARE PRESENT IN MUNICIPAL DRINKING WATER.
- AIR ENTRAINING ADMIXTURE CONFORMING TO ASTM C260, SHALL BE USED IN ALL CONCRETE EXPOSED TO THE WEATHER.
- WHEN CONSTRUCTION JOINTS ARE USED IN SLABS OR BEAMS, THEY SHALL BE LOCATED AT POINTS OF MINIMUM SHEAR, SHALL BE KEVED, AND HAVE REINFORCING RUN THROUGH JOINT OR BE DOWELED WITH SUFFICIENT DOWEL EMBEDMENT AND/OR LAP TO DEVELOP FULL STRENGTH OF REINFORCING.
- HORIZONTAL PLACEMENT STOPS INTERRUPTING THE VERTICAL THICKNESS OF CONCRETE BEING PLACED ARE NOT PERMITTED.
- PROVIDE PLACEMENT STOPS AND/OR CONTRACTION (CONTROL) JOINTS IN SLABS ON EARTH ALONG ALL COLUMN CENTERLINES, AND BETWEEN (1/2 BAY, 1/3 BAY, ETC.) SO THAT MAXIMUM JOINT SPACING IS LIMITED TO 25 FT +/-IN ANY DIRECTION.

- ALL SLABS ON EARTH SHALL BE REINFORCED AS INDICATED ON DRAWINGS.
- CONCRETE PADS, ETC. NOT CAST INTEGRALLY, WITH SLAB ON EARTH SHALL BE REINFORCED WITH 6 X 6-6/16 WELDED WIRE MESH (6 X 6-W2-9) AT MID-DEPTH OF SLAB, UNLESS SHOWN OTHERWISE.
- ALL REINFORCING BARS SHALL BE NEW BILLET STEEL, DEFORMED TYPE, (ASTM A-615 GRADE 60) AND SHALL COMPLY WITH ACI CODE REQUIREMENTS.
- ALL REINFORCING BARS IN SLABS AND GRADE BEAMS SHALL BE EPOXY COATED.
- ALL WELDED WIRE MESH 9/16W/MO SHALL CONFORM TO THE REQUIREMENTS OF ASTM A-185.
- MINIMUM LENGTH OF SLAB REINFORCEMENT SHALL BE AS PER ACI BUILDING CODE.
- LENGTH OF REINFORCING SPLICES SHALL CONFORM TO ACI BUILDING CODE REQUIREMENTS.
- TOP STEEL IN BEAMS AT DISCONTINUOUS ENDS SHALL EXTEND INTO ADJACENT SLAB 40 BAR DIAMETERS OR A MINIMUM OF 2'-0" UNLESS GREATER EXTENSION IS CALLED FOR ON DRAWINGS.
- CONCRETE SHALL BE CURED WITH APPROVED METHODS FOR A MINIMUM OF SEVEN DAYS AFTER PLACEMENT.
- CONCRETE PROTECTION FOR REINFORCING STEEL SHALL BE AS FOLLOWS UNLESS INDICATED OTHERWISE ON DRAWINGS.

SLABS.....	3/4"
BEAMS.....	1-1/2"
COLUMNS/PIERS.....	2"
CONCRETE PLACED ON GROUND.....	3"
- USE CHAIRS TO LOCATE & HOLD ALL REINFORCEMENT IN PLACE.
- PROVIDE 3/4" CHAMFER AT CORNERS OF ALL CONCRETE BEAMS AND COLUMNS EXCEPT AS DIRECTED BY ARCHITECT.
- GROUT FOR STEEL COLUMN BASES TO BE NON-SHRINKING MORTAR, OR APPROVED MANUFACTURED NON-SHRINK GROUT.
- SUBMIT SHOP DRAWINGS OF REINFORCING STEEL FOR REVIEW BEFORE FABRICATION.
- ALL CONCRETE WORK, INCLUDING CONCRETE, FORMS AND REINFORCEMENT SHALL BE INSPECTED AT THE WORK SITE BY QUALIFIED INSPECTORS. A RECORD SHALL BE KEPT OF SUCH INSPECTION WHICH SHALL COVER THE CERTIFICATION OF THE CONCRETE AS REQUIRED BY THE BUILDING CODE FOR THE PLACING OF THE CONCRETE, THE SLUMP, UNIT WEIGHT, AIR CONTENT OF THE CONCRETE, PLACING OF THE REINFORCING STEEL, THE SIZE AND DIMENSION OF THE CONCRETE MEMBERS AND REINFORCING, AND A COMPLETE RECORD OF ALL TEST SAMPLES AND RESULTS.
- THE PRODUCER OF CONCRETE SHALL USE MIX PROPORTIONS AND WATER CEMENT RATIOS WHICH HAVE BEEN SHOWN BY PREVIOUS TESTS TO PRODUCE SATISFACTORY CONCRETE OF THE REQUIRED STRENGTH AT A SLUMP OF 5 INCHES WITH A TOLERANCE OF PLUS OR MINUS 1 INCH. EACH LOAD OF CONCRETE SHALL BE CERTIFIED BY THE PRODUCER TO THE OWNER AS TO THE CONCRETE STRENGTH AND QUANTITIES PER CUBIC YARD OF EACH MATERIAL. A COPY OF SUCH CERTIFICATION SHALL BE READILY AVAILABLE TO THE BUILDING DEPARTMENT DURING THE PROGRESS OF THE WORK AND FOR TWO YEARS THEREAFTER.
- SAMPLES MUST BE TAKEN FROM MIXER AND TESTED FOR SLUMP, AIR CONTENT, TEMPERATURE, AND WEIGHT PER CUBIC FOOT AS PER 27-607. FOR EACH CLASS OF CONCRETE POURED EACH DAY FOUR (4) TEST CYLINDERS SHALL BE MADE FROM SAMPLING FOR EACH 50 CUBIC YARDS OR FRACTION THEREOF. CYLINDERS SHALL BE CURED AND STORED AND TESTED AS REQUIRED BY THE NEW YORK STATE CODE.

### STRUCTURAL DESIGN CRITERIA

APPLICABLE CODE: NEW YORK STATE BUILDING CODE 2020

#### DEAD LOADS:

APPLICABLE DEAD LOADS ARE SHOWN FOR EACH STRUCTURE. SEE INDIVIDUAL FRAMING PLANS.

FOR THE DELEGATED DESIGN OF THE ENGINEERED BUILDINGS IN THE PROJECT, THE CONTRACTOR SHALL INCLUDE ANY MANUFACTURER SPECIFIC DEAD LOADS AS WELL AS DEAD LOADS FOR ALL COMPONENTS SHOWN IN THE ARCHITECTURAL, MECHANICAL, ELECTRICAL, PLUMBING AND SPRINKLER DRAWINGS.

#### LIVE LOAD:

MINIMUM ROOF LIVE LOAD: 20 PSF

#### SNOW LOAD:

GROUND SNOW LOAD:	30 PSF
SNOW LOAD:	25.2 PSF
SNOW EXPOSURE FACTOR (Ce):	1.0
SNOW IMPORTANCE FACTOR (Is):	1.0
THERMAL FACTOR (Ci):	1.2

#### WIND LOAD:

BASIC WIND SPEED:	114 MPH
OCCUPANCY CATEGORY:	II
WIND IMPORTANCE FACTOR (Iw):	1.0
WIND EXPOSURE:	C

#### EARTHQUAKE:

IMPORTANCE FACTOR (Ia):	1.0
SEISMIC OCCUPANCY CATEGORY:	II
SOIL SITE CLASS:	D
MAPPED SPECTRAL RESPONSE (Ss):	0.281
MAPPED SPECTRAL RESPONSE (S1):	0.061
ADJUSTED SPECTRAL RESPONSE (Sms):	0.442
ADJUSTED SPECTRAL RESPONSE (Sm1):	0.145
DESIGN SPECTRAL RESPONSE (Sds):	0.295
DESIGN SPECTRAL RESPONSE (Sd1):	0.097
SEISMIC DESIGN CATEGORY:	B

### SPECIAL INSPECTION ITEMS:

THE FOLLOWING ITEMS OF WORK ARE SUBJECT TO SPECIAL INSPECTION BY A QUALIFIED SPECIAL INSPECTION AGENCY, PER THE REQUIREMENT OF THE NEW YORK STATE BUILDING CODE.

THE CONTRACTOR SHALL ENGAGE, HIRE AND PAY ALL COSTS ASSOCIATED WITH PROVIDING SPECIAL INSPECTION SERVICES. COORDINATE WITH INDIVIDUAL SPECIFICATIONS SECTIONS.

CODE REFERENCE	INSPECTION REQUIREMENT
BC 1705.3 & TABLE 1705.3	CONCRETE CONSTRUCTION

#### REINFORCEMENT & PLACEMENT

ANCHOR PLACEMENT CONTINUOUS

CONCRETE SAMPLING & TESTING CONTINUOUS

DESIGN MIX PERIODIC

FORMWORK PERIODIC

BC 1704.7 & TABLE 1704.7

FOOTING SUBGRADE BEARING

CAPACITY PERIODIC

ELEVATION BOTTOM OF FOOTING PERIODIC

TESTING OF CONTROLLED FILL PERIODIC

PLACEMENT & COMPACTION OF

CONTROLLED FILL CONTINUOUS

SUBGRADE PRIOR TO

CONTROLLED FILL PERIODIC

#### BC 1705.2.2 & 1705.2.2 STRUCTURAL STEEL

PERFORM PERIODIC SPECIAL INSPECTION OBSERVATIONS PER THE REQUIREMENTS OF AISC 360-11 FOR:  
WELDING BEFORE, DURING AND AFTER WELDING COMPLETED.  
HIGH STRENGTH BOLTING BEFORE, DURING AND AFTER BOLTED CONNECTIONS COMPLETED.

#### BC 1705.12.3 COLD-FORMED STEEL LIGHT GAUGE FRAMING

PERIODIC SPECIAL INSPECTION OBSERVATIONS OF SCREW ATTACHMENTS, BOLTING, ANCHORING FOR ALL EXTERIOR WALLS AND ROOF CONSTRUCTION.

#### BC 1705.6 & TABLE 1705.6 INSPECTIONS & TESTS OF SOILS

VERIFY BEARING CAPACITY PERIODIC

VERIFY FOOTING DEPTH & PROPER MATERIAL PERIODIC


COMPACTED FILL OPERATIONS & DENSITY TESTING CONTINUOUS

HILLMAN & MILEY  
CONSULTING ENGINEERS PLLC

235 MAMARONECK AVE 302  
WHITE PLAINS, NY 10605  
PHONE 914.428.0909  
INFO@HILLMANMILEY.COM




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SIGNATURE _____	SIGNATURE _____			
TITLE _____	DATE _____			
WESTCHESTER COUNTY, NEW YORK DEPARTMENT OF PUBLIC WORKS AND TRANSPORTATION DIVISION OF ENGINEERING		CONTRACT NUMBER 17-539	SHEET NUMBER S-001	
		SHEET NO. 18 OF 59		
NEW GOLF CART STORAGE FACILITY AND CLUB HOUSE UPGRADES MOHANSIC GOLF COURSE, YORKTOWN, NEW YORK STRUCTURAL NOTES		SCALE: NTS DATE: 6/4/21 DPW FILE NO. 10-02-S-51		
		REV. NO. 0		

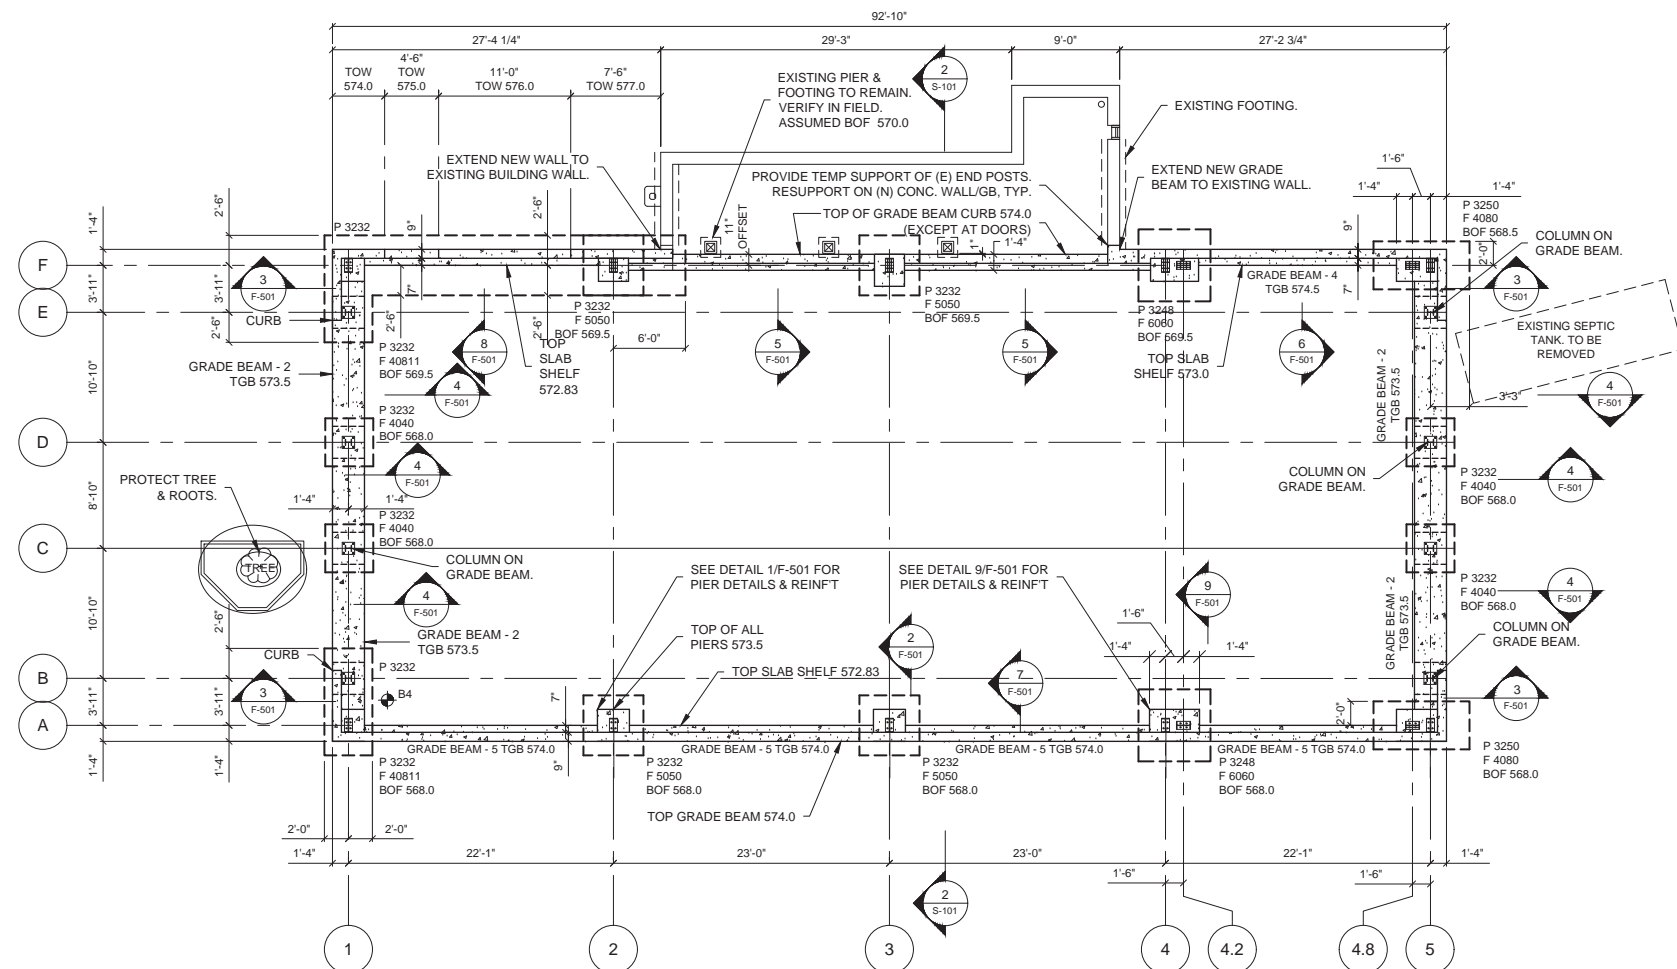

- NOTES:
1. HIGH POINT FINISHED FLOOR ELEVATION 573.50.
  2. SEE PLAN FOR TOP OF GRADE BEAM ELEVATION.
  3. TYPICAL TOP OF PIER ELEVATION 573.50 UNLESS NOTED.
  4. SEE PLAN FOR BOTTOM OF FOOTING ELEVATION.
  5. ALL FOOTING SHALL BEAR ON ROCK, EXCAVATED, BENCHED AND LEVELED.
  6. TRENCH EXCAVATE ROCK FOR GRADE BEAMS MINIMUM 2' BELOW BOTTOM OF GRADE BEAM.
  7. SEE SHEET F501 FOR PIER DETAILS.

1 FOUNDATION PLAN GOLF CART STORAGE SHED


1/8" = 1'-0"

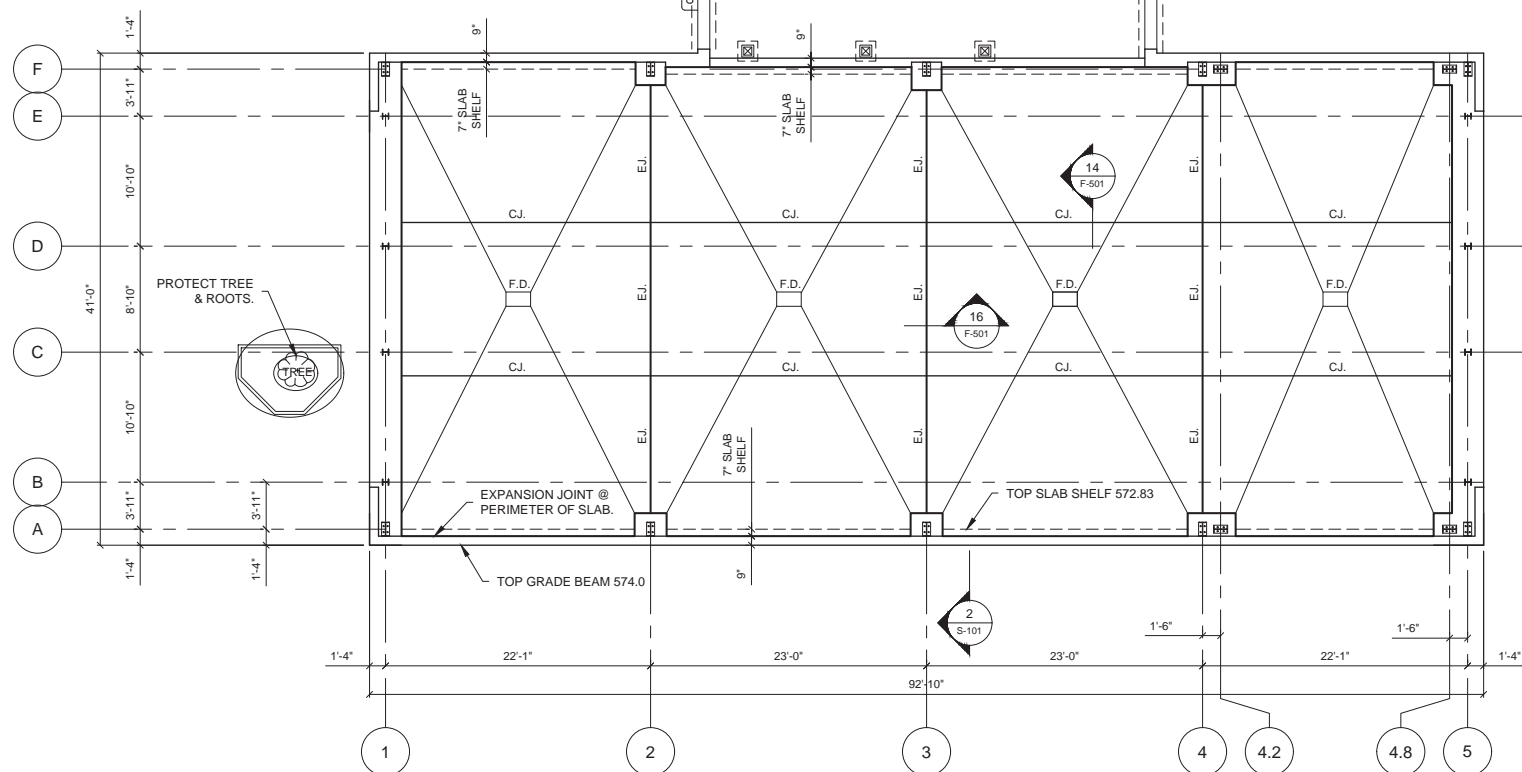

- NOTES:
1. HIGH POINT FINISHED FLOOR 573.50.
  2. 8" CONCRETE SLAB WITH #4 @ 12" EACH WAY.
  3. 6 MIL VAPOR BARRIER & 6" COMPACTED STONE.
  4. SEE SLAB DETAILS 14 THRU 17 / F-501.

2 SLAB PLAN GOLF CART STORAGE SHED


1/8" = 1'-0"

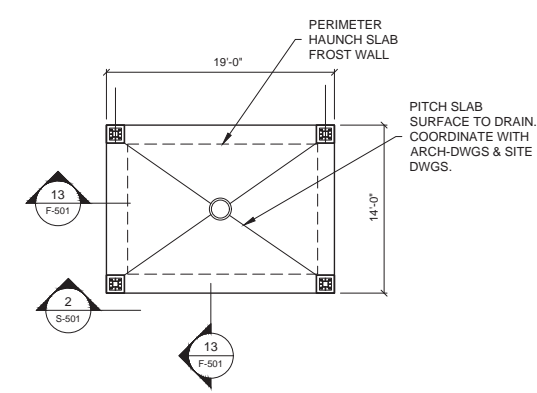

- NOTES:
1. FINISHED FLOOR 572.0
  2. 12" CONCRETE SLAB, WITH #4 @ 12" TOP & BOTTOM EACH WAY, (2) LAYERS.
  3. INSTALL 6" COMPACTED STONE BASE.

SLAB PLAN CART WASH & FUELING STATION

1/8" = 1'-0"

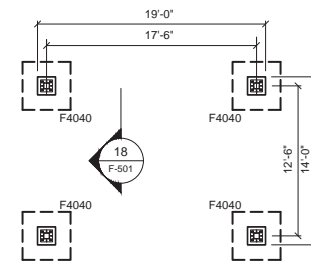

- NOTES:
1. FINISHED FLOOR ELEVATION 572.00.
  2. SEE SLAB PLAN BELOW FOR PERIMETER HAUNCH SLAB.
  3. TYPICAL PIER THIS PLAN 18" X 18" REINFORCE WITH (12) #5 L-BARS INTO FOOTING & #3 TIES AT 6" SPACING.
  4. TOP OF PIER ELEVATION 572.50 UNLESS NOTED.
  5. BOTTOM OF FOOTING ELEVATION 568.00.
  6. ALL FOOTING SHALL BEAR ON ROCK, EXCAVATED, BENCHED AND LEVELED.
  7. SEE DRAWING F-102 FOR FOOTING SCHEDULE & FOUNDATION NOTES.

FOUNDATION PLAN CART WASH & FUELING STATION

1/8" = 1'-0"

PROJECT SPREAD FOOTING SCHEDULE				
MARK	SIZE	DEPTH	BOTTOM REINFORCING EACH WAY	TOP REINFORCING EACH WAY
F5050	5'-0" X 5'-0"	1'-4"	(6) - #5	(6) - #5
F4040	4'-0" X 4'-0"	1'-0"	(7) - #4	(7) - #4
F6060	6'-0" X 6'-0"	1'-4"	(10) - #5	(10) - #5
F4080	4'-0" X 8'-0"	1'-4"	(6) - #5 LW	(6) - #5 LW
F40811	4'-0" X 8'-11"	1'-4"	(12) - #5 SW	(12) - #5 SW
F40811			(6) - #5 LW	(6) - #5 LW
F40811			(14) - #5 SW	(14) - #5 SW

NOTES:  
ALL BARS 90° HOOK EACH END.

PROJECT LEGEND:

- TEST BORING
- EXPANSION JOINT SEE 12/501 (EJ)
- CONTROL JOINT SEE 11/F501 (CJ)
- GB # GRADE BEAM NUMBER
- FLOOR DRAIN (F.D.)
- PIER
- FOOTING
- TGB TOP OF GRADE BEAM
- BOF BOTTOM OF FOOTING
- TOW TOP OF WALL
- EXISTING SOIL
- EXISTING ROCK

IN CHARGE OF KJM  
CHECKED BY KJM  
MADE BY TJR/AGS


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STATE OF NEW YORK  
SEAL OF KEVIN J. MILEY  
LICENSED PROFESSIONAL ENGINEER  
NO. 060391-X

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NAME	SIGNATURE	NAME	SIGNATURE	DATE
TITLE		TITLE		
WESTCHESTER COUNTY, NEW YORK DEPARTMENT OF PUBLIC WORKS AND TRANSPORTATION DIVISION OF ENGINEERING				CONTRACT NUMBER 17-539 SHEET NUMBER F-101 SHEET NO. 19 OF 59
NEW GOLF CART STORAGE FACILITY AND CLUB HOUSE UPGRADES MOHANSIC GOLF COURSE, YORKTOWN, NEW YORK FOUNDATION PLANS				SCALE: 1/8"=1'-0" DATE: 6/4/21 DPW FILE NO. 10-02-F-52 REV. NO. 0




9 PLAN DETAIL - PIER P3248  
1/2" = 1'-0"

**NOTE:**  
COLUMN & BASE  
PLATE NOT SHOWN,  
COORD. WITH METAL  
BLDG. SHOP DWGS..

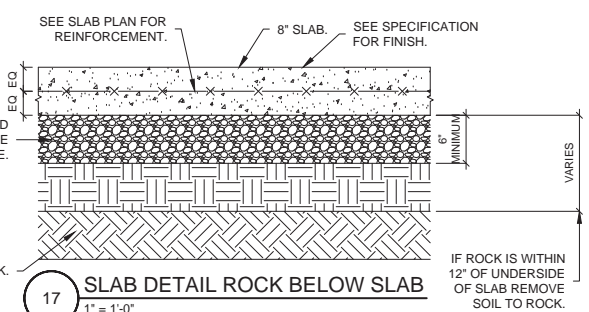
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SIGNATURE _____				SIGNATURE _____			
TITLE _____ DATE _____				TITLE _____ DATE _____			
<b>WESTCHESTER COUNTY, NEW YORK</b> <b>DEPARTMENT OF PUBLIC WORKS</b> <b>AND TRANSPORTATION</b> DIVISION OF ENGINEERING						CONTRACT NUMBER 17-539	SHEET NUMBER F-501
<b>NEW GOLF CART STORAGE FACILITY AND CLUB HOUSE UPGRADES</b> <b>MOHANS GOLF COURSE, YORKTOWN, NEW YORK</b> <b>FOUNDATION SECTIONS &amp; DETAILS</b>						SHEET NO. 20 OF 59	
						SCALE: AS-NOTED DATE: 6/4/21	
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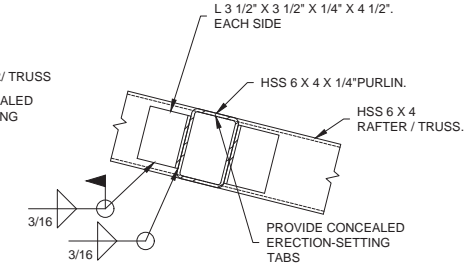





3 COLUMN TOP DETAIL  
1 1/2" = 1'-0"

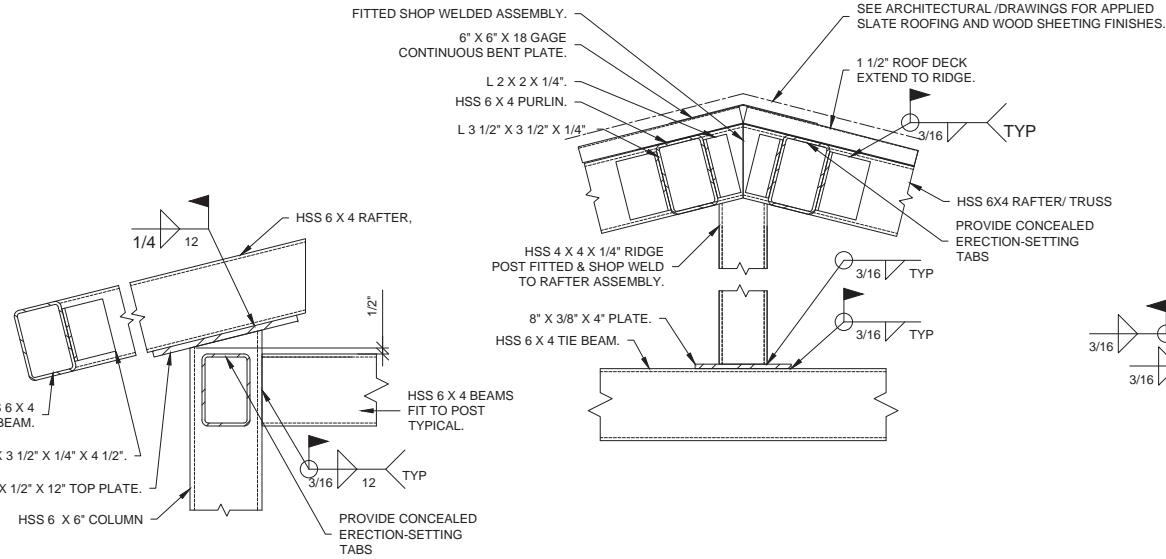


4 SECTION RIDGE POST  
1 1/2" = 1'-0"

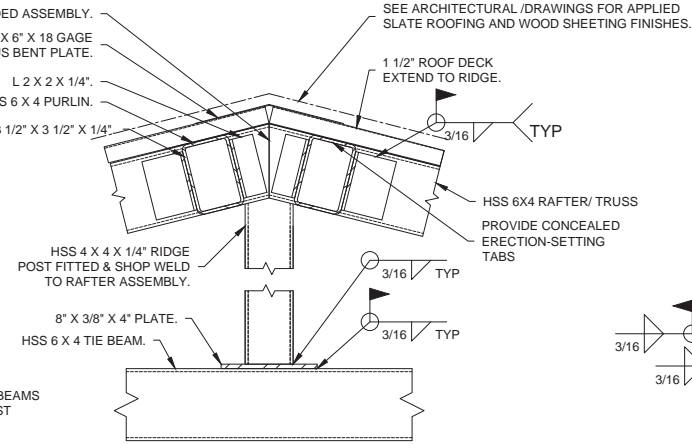


5 PURLIN TO RAFTER DETAIL  
1 1/2" = 1'-0"

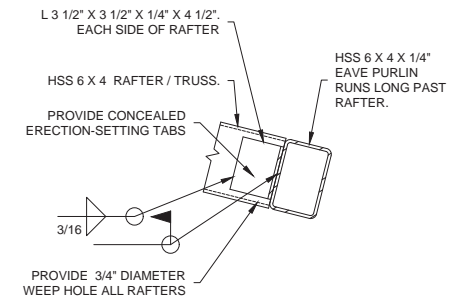


6 EAVE PURLIN TO RAFTER DETAIL  
1 1/2" = 1'-0"

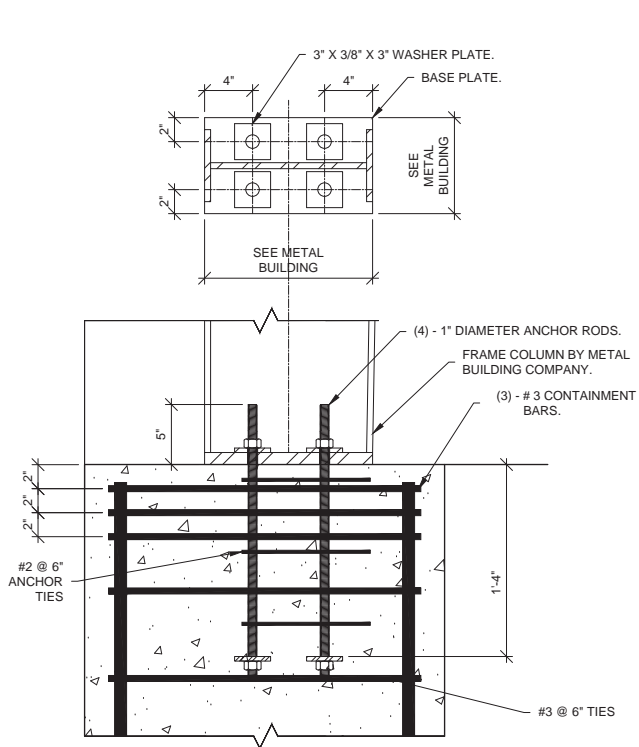

1 DETAIL FRAME COLUMN ANCHORS  
1 1/2" = 1'-0"

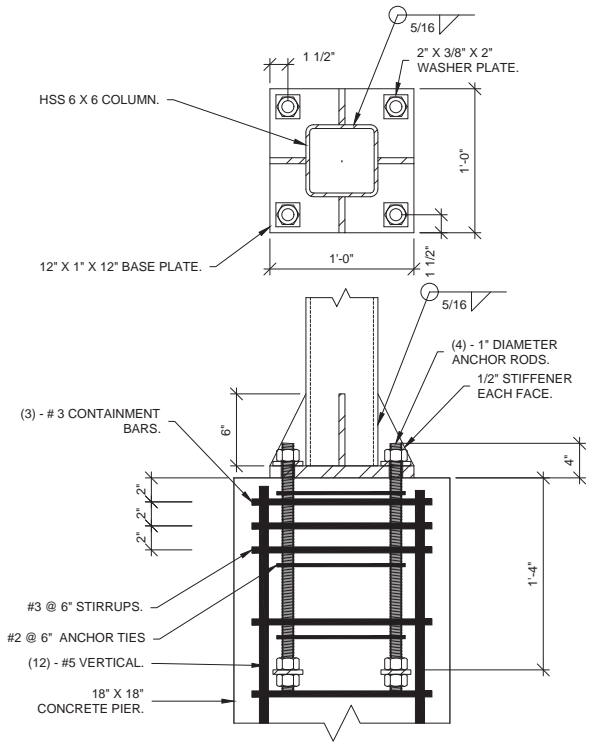

2 DETAIL COL. WASH STATION  
1 1/2" = 1'-0"

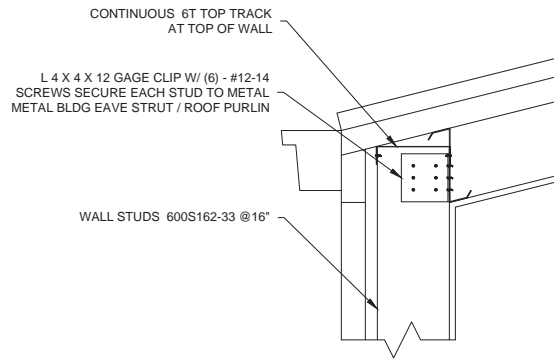

7 METAL BLDG. EAVE  
1 1/2" = 1'-0"

IN CHARGE OF KJM  
CHECKED BY KJM  
MADE BY TJR/AGS

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NAME	SIGNATURE	NAME	SIGNATURE	DATE
TITLE	DATE	TITLE	DATE	DATE
WESTCHESTER COUNTY, NEW YORK DEPARTMENT OF PUBLIC WORKS AND TRANSPORTATION DIVISION OF ENGINEERING				CONTRACT NUMBER 17-539 SHEET NUMBER S-501 SHEET NO. 22 OF 59
NEW GOLF CART STORAGE FACILITY AND CLUB HOUSE UPGRADES MOHANSIC GOLF COURSE, YORKTOWN, NEW YORK STRUCTURAL SECTIONS & DETAILS				SCALE: 1 1/2"=1'-0" DATE: 6/4/21 DPW FILE NO. 10-02-S-55 REV. NO. 0




1. SUMPS & RELATED EQUIPMENT ARE PROVIDED BY WASH / RECYCLE SYSTEM MANUFACTURER. SUMPS SHALL BE INSTALLED INTO CONC. SLABS & PADS BY GENERAL CONTRACTOR.
2. WATER SERVICE, UNDERGROUND PIPING AND SURFACE 'STUB-UPS' SHALL BE FURNISHED & INSTALLED BY PLUMBING CONTRACTOR.
3. WATER TREATMENT PLUMBING EQUIPMENT ( PROVIDED BY WASH / RECYCLE SYSTEM MANUFACTURER ) SHALL BE CONNECTED TO UNDERGROUND PIPING & STUB-UPS BY PLUMBING CONTRACTOR.
4. POWER SERVICE & UNDERGROUND ELECTRICAL CONDUIT & WIRING SHALL BE FURNISHED & INSTALLED BY ELECTRICAL CONTRACTOR.
5. WATER TREATMENT ELECTRICAL EQUIPMENT ( PROVIDED BY WASH / RECYCLE SYSTEM MANUFACTURER ) SHALL BE CONNECTED TO UNDERGROUND CONDUIT & WIRING BY ELECTRICAL CONTRACTOR.
6. ENTIRE WASH / RECYCLE / CHEMICAL MIX SYSTEM INCLUDING ALL EQUIPMENT PROVIDED BY WASH / RECYCLE SYSTEM MANUFACTURER, WATER SERVICE, PIPING, VALVES, CONNECTIONS, ELECTRICAL SERVICE, PANELS, DISCONNECTS, CONDUIT, WIRING & CONNECTIONS SHALL BE COORDINATED BY GENERAL CONTRACTOR IN THE FIELD.
7. REVIEW ALL EQUIPMENT, COMPONENTS, LOCATIONS & CONNECTION ROUTES WITH WASH / RECYCLE SYSTEM MANUFACTURER, ARCH. & OWNER IN FIELD PRIOR TO ANY WORK.

1. LAYOUT SHOWN IS A SCHEMATIC DIAGRAM OF SYSTEM COMPONENTS PERTAINING TO A SPECIFIC MANUFACTURER DESCRIBED IN THE SPECIFICATIONS.
2. ALTERNATE SYSTEM MANUFACTURERS MAY HAVE SLIGHTLY DIFFERENT EQUIPMENT, COMPONENTS & CONNECTION LAYOUTS.
3. SYSTEM COST PROPOSALS SHALL BE BASED UPON COMPARABLE APPROVED SYSTEMS OFFERING EQUAL PERFORMANCE & OPERATION TO THE LAYOUT SHOWN & SPECIFIED.

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<b>WESTCHESTER COUNTY, NEW YORK</b> <b>DEPARTMENT OF PUBLIC WORKS</b> DIVISION OF ENGINEERING			CONTRACT NUMBER 17-539	SHEET NUMBER EQ-101
NEW GOLF CART STORAGE FACILITY AND CLUBHOUSE UPGRADES MOHANSIC GOLF COURSE, YORKTOWN, NEW YORK WASHING, MIXING & RECYCLE EQUIPMENT			SHEET NO. 23 OF 59  SCALE: 1/4" = 1'-0" DATE: 6 / 4 / 21  DPW FILE NO. 10-02-EQ-56	
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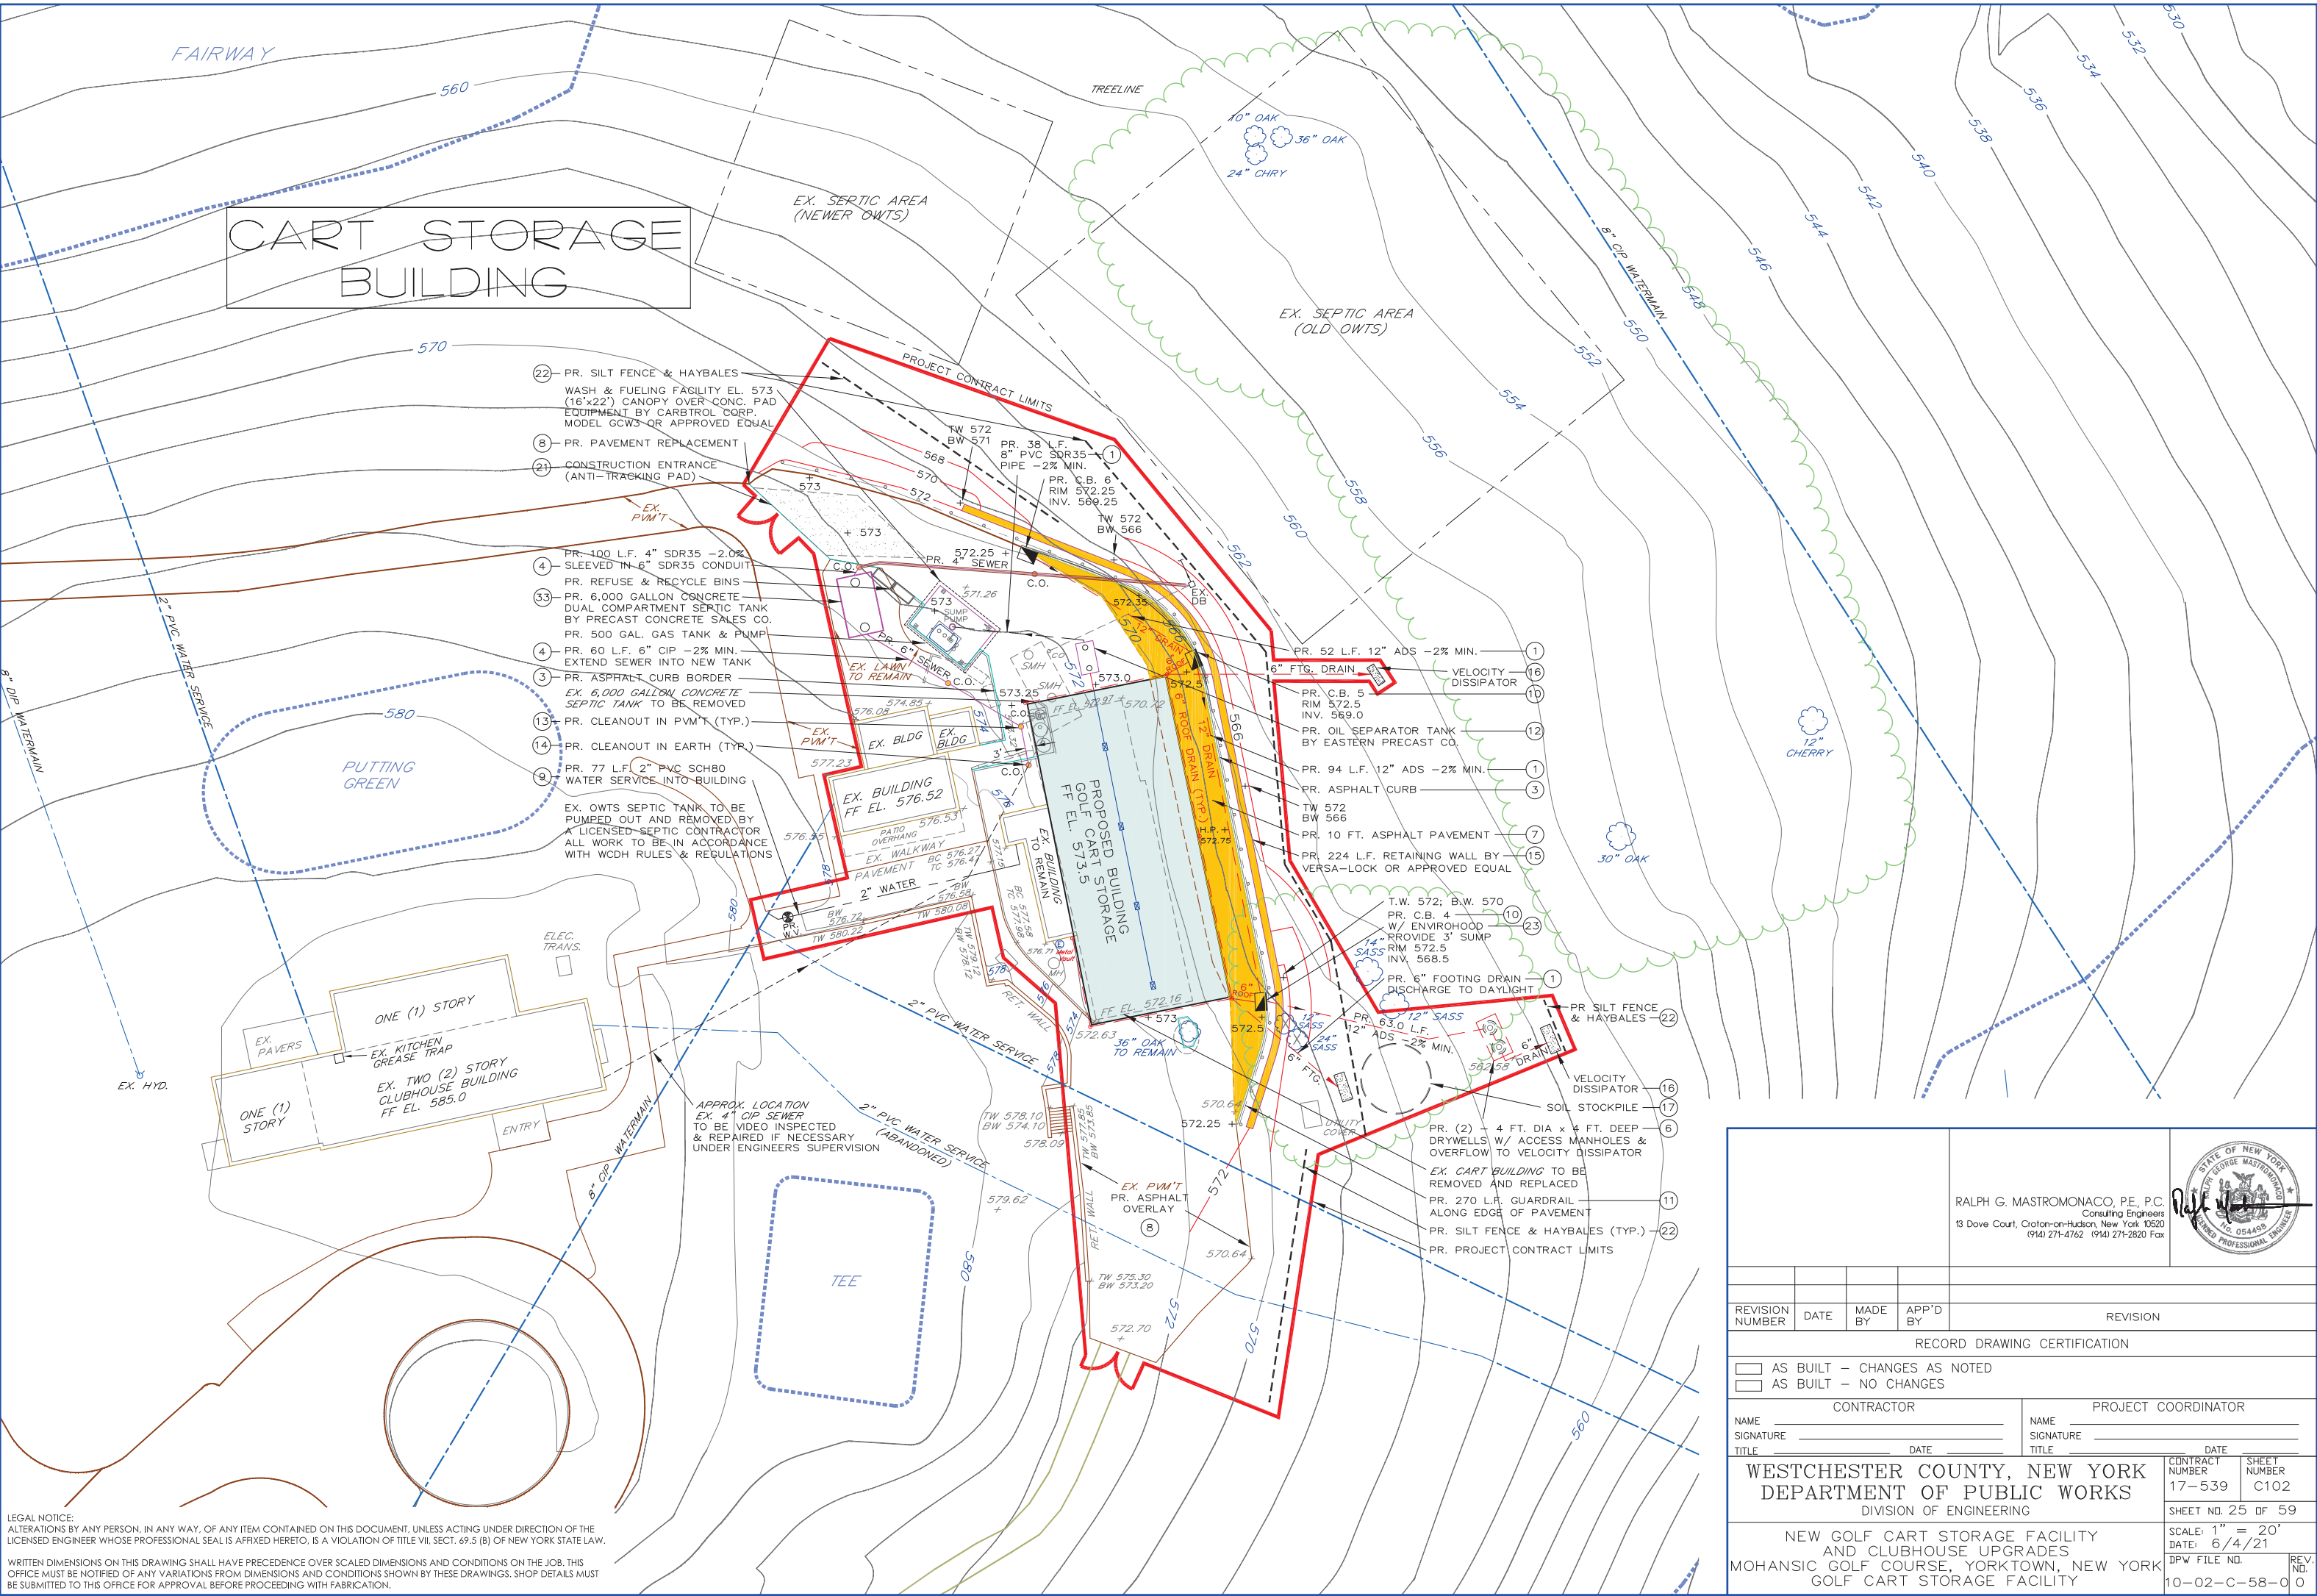
LOCATION MAP  
1" = 1000'

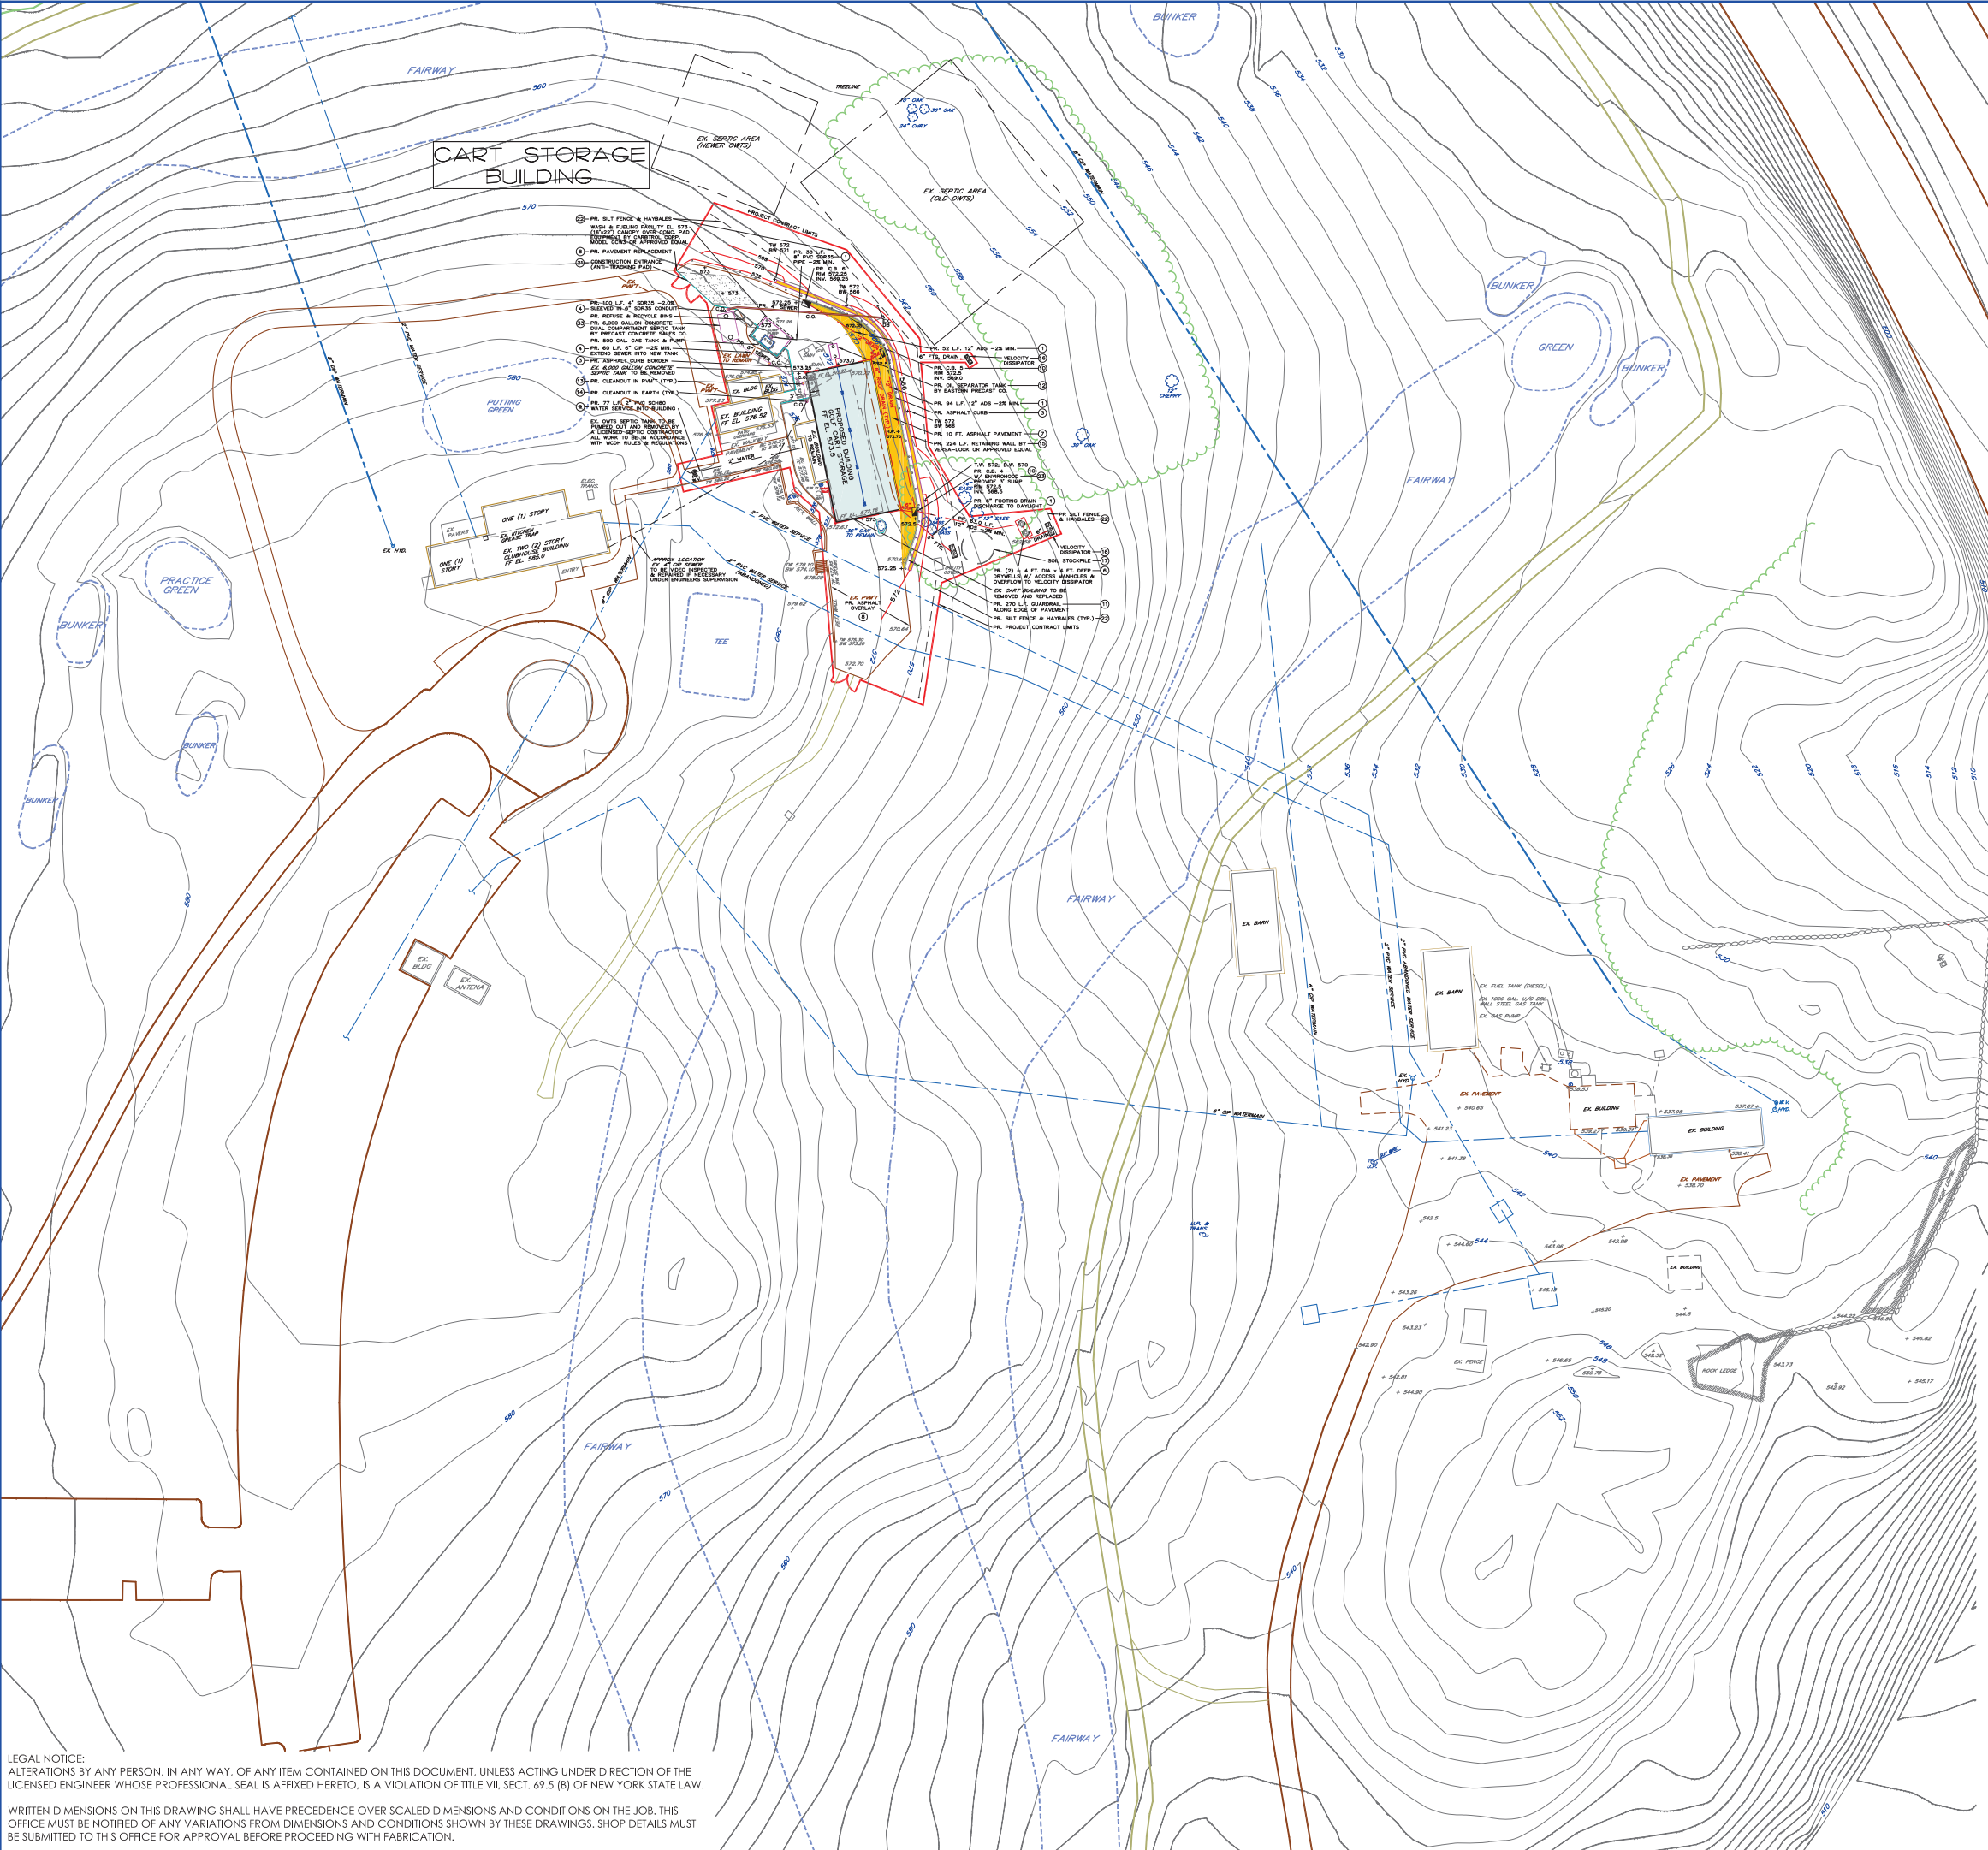

				RALPH G. MASTROMONACO, P.E., P.C. Consulting Engineers 13 Dove Court, Croton-on-Hudson, New York 10520 (914) 271-4762 (914) 271-2820 Fax			
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DATE _____				DATE _____			
WESTCHESTER COUNTY, NEW YORK DEPARTMENT OF PUBLIC WORKS DIVISION OF ENGINEERING				CONTRACT NUMBER 17-539 SHEET NO. 24 OF 59			
NEW GOLF CART STORAGE FACILITY AND CLUBHOUSE UPGRADES MOHANSIC GOLF COURSE, YORKTOWN, NEW YORK OVERALL SITE PLAN				SCALE: 1" = 50' DATE: 6/4/21 DPW FILE NO. 10-02-C-57-0			
				REV. NO. 0			

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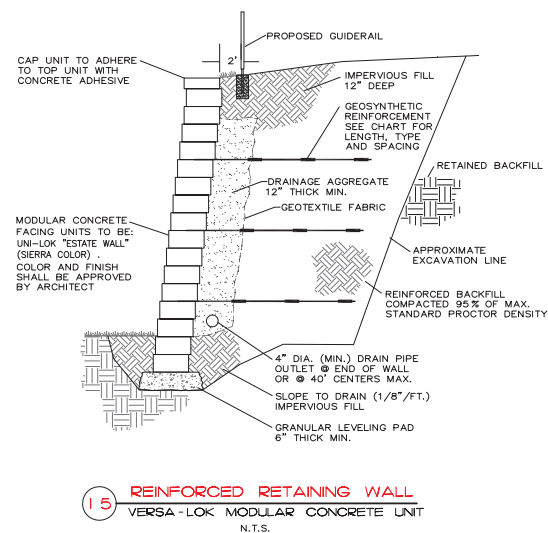
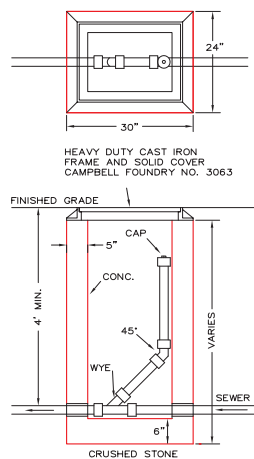
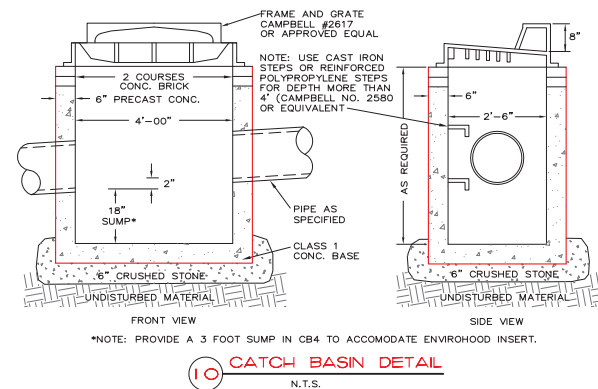
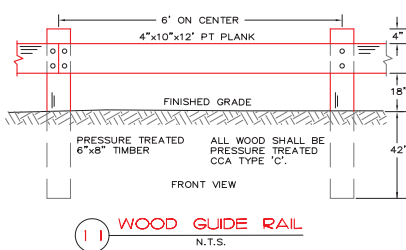
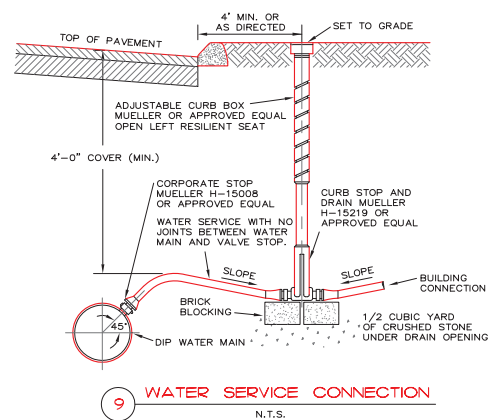
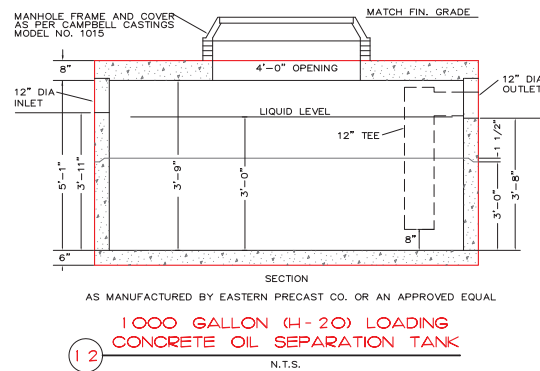
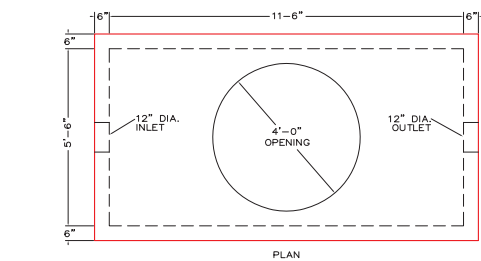
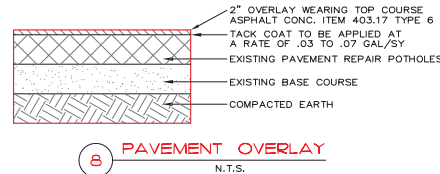
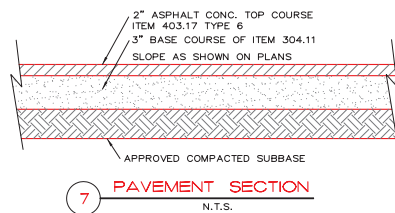
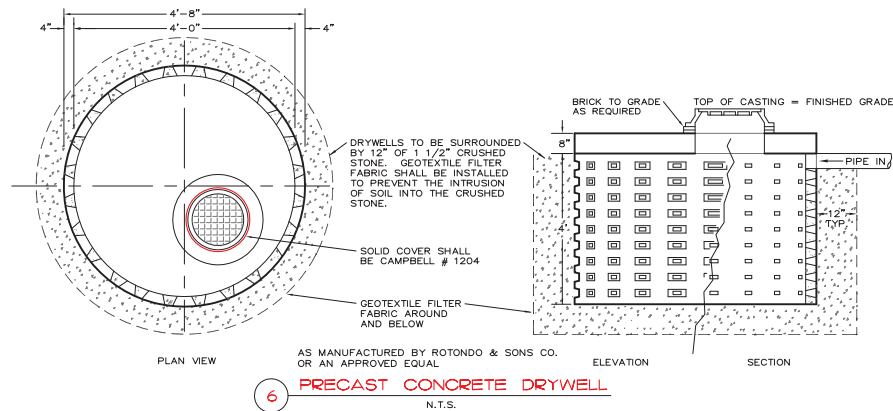
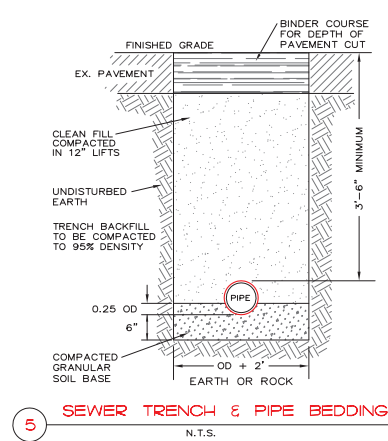
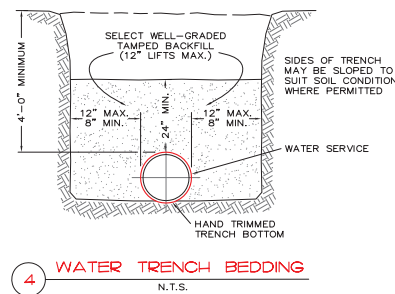
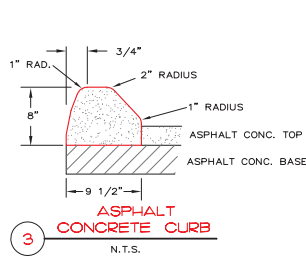
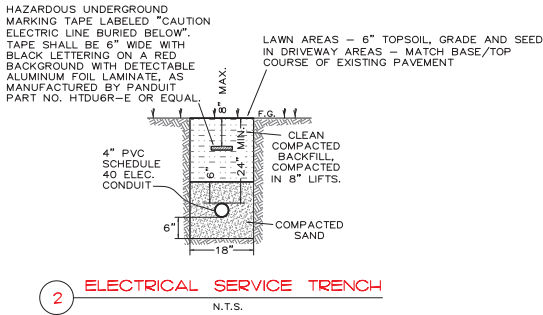
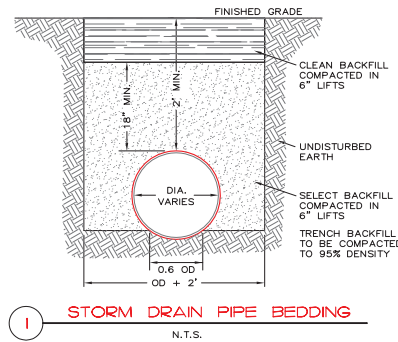
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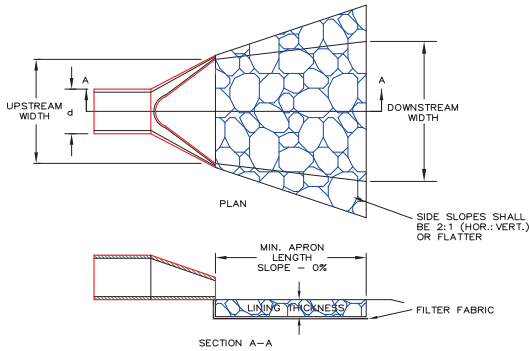
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CONTRACTOR			PROJECT COORDINATOR		
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SIGNATURE			SIGNATURE		
TITLE			TITLE		
WESTCHESTER COUNTY, NEW YORK DEPARTMENT OF PUBLIC WORKS DIVISION OF ENGINEERING			CONTRACT NUMBER 17-539 SHEET NO. 25 OF 59		
NEW GOLF CART STORAGE FACILITY AND CLUBHOUSE UPGRADES MOHANSIC GOLF COURSE, YORKTOWN, NEW YORK GOLF CART STORAGE FACILITY			SCALE: 1" = 20' DATE: 6/4/21 DPW FILE NO. 10-02-C-58-0		



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<input type="checkbox"/> AS BUILT - CHANGES AS NOTED <input type="checkbox"/> AS BUILT - NO CHANGES							
CONTRACTOR				PROJECT COORDINATOR			
NAME _____ SIGNATURE _____ TITLE _____				NAME _____ SIGNATURE _____ TITLE _____			
DATE _____				DATE _____			
WESTCHESTER COUNTY, NEW YORK DEPARTMENT OF PUBLIC WORKS DIVISION OF ENGINEERING				SHEET NUMBER 17-539 C103 SHEET NO. 26 OF 59			
NEW GOLF CART STORAGE FACILITY AND CLUBHOUSE UPGRADES MOHANSIC GOLF COURSE, YORKTOWN, NEW YORK CONSTRUCTION DETAILS				SCALE: AS SHOWN DATE: 6/4/21 DPW FILE NO. 10-02-C-59-0 REV. NO. 0			




- NOTES
1. APRON LINING MAY BE RIPRAP, GROUTED RIPRAP OR CONCRETE.
  2. LINING THICKNESS SHALL BE 4" FOR CONCRETE, 1.5 TIMES THE MAXIMUM STONE DIAMETER FOR  $d_{50} = 15"$  OR LESS, OR 1.2 TIMES THICKNESS - 20 - 60 mls. GRAB STRENGTH - 90 - 120 lbs., AND SHALL CONFORM TO ASTM D-1777 AND ASTM D-1682.

PIPE SIZE (INCH)	RIPRAP SIZE ( $d_{50}$ ) (FEET)	MIN. APRON LENGTH (FEET)	UPSTREAM WIDTH (FEET)	DOWNSTREAM WIDTH (FEET)	RIPRAP SIZE ( $d_{min}$ ) (FEET)	RIPRAP SIZE ( $d_{max}$ ) (FEET)	MINIMUM LINING THICKNESS (FEET)
6	0.25	3	1.5	1.5	0.125	0.375	0.562
8	0.25	4	2	2	0.125	0.375	0.562
12	0.75	6	3	3	0.375	1.125	1.68
15	1.0	7.5	3.75	3.75	0.5	1.5	2.25
18	1.25	9	4.5	4.5	0.625	1.875	2.81
24	1.6	12	6	6	0.8	2.4	2.88
36	2.4	18	9	9	1.2	3.6	4.32

TO BE USED BELOW ROAD CULVERTS, WHERE THE CHANNEL GRADE OF THE RECEIVING EARTHEN OR VEGETATED WATERCOURSES IS STEEP, AND/OR CHANNELS ARE EMBEDDED IN HIGHLY ERODIBLE SOILS; BELOW PIPES > 10 INCHES IN DIAMETER THAT DISCHARGE WATER FROM EARTHEN DAMS; BELOW CHANNELS THAT DISCHARGE WATER ONTO AN EARTHEN OR VEGETATED CHANNEL; BELOW VARIOUS GRADE STABILIZATION STRUCTURES, SUCH AS A CONCRETE TOEWALL THAT DISCHARGE INTO AN EARTHEN OR VEGETATED CHANNEL; IN EXIT CHANNELS IN STANDING OR FLOWING WATER WHERE CHANNEL SCOUR WILL CAUSE SIDE SLOPE EROSION.

## 16 VELOCITY DISSIPATOR

N.T.S.

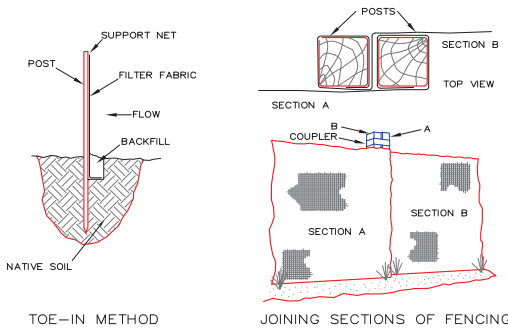

TO BE INSTALLED IMMEDIATELY BELOW DISTURBED AREAS THAT ARE SUSCEPTIBLE TO SHEET OR RILL EROSION, AND WHERE SEWAGE WATER BODIES, SUCH AS DRINKING WATER SUPPLIES OR WETLANDS, ARE LOCATED DOWNSLOPE OF AN AREA TO BE DISTURBED.


### INSTALLATION NOTES

1. EXCAVATE A 4 INCH X 4 INCH TRENCH ALONG THE LOWER PERIMETER OF THE SITE.
2. UNROLL A SECTION AT A TIME AND POSITION THE POSTS AGAINST THE BACK (DOWNSTREAM) WALL OF THE TRENCH (NET SIDE AWAY FROM DIRECTION OF FLOW).
3. DRIVE THE POST INTO THE GROUND UNTIL THE NETTING IS APPROXIMATELY 2 INCHES FROM THE TRENCH BOTTOM.
4. LAY THE TOE-IN FLAP OF FABRIC ONTO THE UNDISTURBED BOTTOM OF THE TRENCH, BACKFILL THE TRENCH AND TAMP THE SOIL. STEEPER SLOPES REQUIRE AN INTERCEPT TRENCH.
5. JOIN SECTIONS AS SHOWN ABOVE.

## 19 SILT FENCE

N.T.S.

MATERIAL LOCATION	DESCRIPTION	AASHTO MATERIAL CLASSIFICATIONS	COMPACTION / DENSITY REQUIREMENT
D FINAL FILL: FILL MATERIAL FOR LAYER 'D' STARTS FROM THE TOP OF THE 'C' LAYER TO THE BOTTOM OF FINISHED GRADE ABOVE	ANY SOIL/ROCK MATERIALS, NATIVE SOILS, OR PER ENGINEER'S PLANS	N/A	PREPARE PER SITE DESIGN ENGINEER'S PLANS.
C INITIAL FILL: FILL MATERIAL FOR LAYER 'C' STARTS FROM THE TOP OF THE EMBEDMENT STONE ('B' LAYER) TO 18" ABOVE THE TOP OF THE CHAMBER. NOTE THAT PAVEMENT SUBBASE MAY BE PART OF THE 'C' LAYER.	GRANULAR WELL-GRADED SOIL/ AGGREGATE MIXTURES, <35% FINES OR PROCESSED AGGREGATE. MOST PAVEMENT SUBBASE MATERIALS CAN BE USED IN LIEU OF THIS LAYER.	AASHTO M145 A-1, A-2-4, A-3 OR AASHTO M43 3, 357, 4, 467, 5, 56, 57, 6, 67, 68, 7, 78, 8, 89, 9, 10	BEGIN COMPACTIONS AFTER 12" (300 mm) OF MATERIAL OVER THE CHAMBERS IS REACHED. COMPACT ADDITIONAL LAYERS IN 6" MAX LIFTS TO A MIN. 95% PROCTOR DENSITY FOR WELL GRADED MATERIAL AND 95% RELATIVE DENSITY FOR PROCESSED AGGREGATE MATERIALS. ROLLER GROSS VEHICLE WEIGHT NOT TO EXCEED 12,000 lbs (53 kN). DYNAMIC FORCE NOT TO EXCEED 20,000 lbs (89 kN).
B EMBEDMENT STONE: FILL SURROUNDING THE CHAMBERS FROM THE FOUNDATION STONE ('A' LAYER) TO THE 'C' LAYER ABOVE	CLEAN, CRUSHED, ANGULAR STONE	AASHTO M43 3, 357, 4, 467, 5, 56, 57	NO COMPACTION REQUIRED.
A FOUNDATION STONE: FILL BELOW CHAMBERS FROM THE SUBGRADE UP TO THE FOOT (BOTTOM) OF THE CHAMBER	CLEAN, CRUSHED, ANGULAR STONE	AASHTO M43 3, 357, 4, 467, 5, 56, 57	PLATE COMPACT OR ROLL TO ACHIEVE A FLAT SURFACE

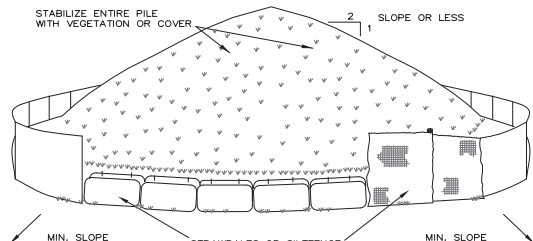

TO BE USED WHERE TOPSOIL PRESERVATION IS NECESSARY FOR REGRADING AND VEGETATING DISTURBED AREAS. TOPSOIL IS APPLIED TO SUBSOILS THAT ARE DROUGHTY (HAVING LOW AVAILABLE MOISTURE FOR PLANTS), STONY, SALTY, HAVE LOW PERMEABILITY, OR ARE EXTREMELY ACID. IT IS ALSO USED TO BACKFILL AROUND SHRUB AND TREE TRANSPLANTS. PRESERVATION OF EXISTING TOPSOIL IS BENEFICIAL FOR ALL TYPES OF LAWN OR ORNAMENTAL PLANTINGS.


TEMPORARY STOCKPILE STABILIZATION MEASURES INCLUDE VEGETATIVE COVER, MULCH, NON-VEGETATIVE COVER, AND PERIPHERAL SEDIMENT TRAPPING BARRIERS. THE STABILIZATION MEASURE(S) SELECTED SHOULD BE APPROPRIATE FOR THE TIME OF YEAR, SITE CONDITIONS, AND REQUIRED DURATION OF USE.

### INSTALLATION NOTES

1. AREA CHOSEN FOR STOCKPILING OPERATIONS SHALL BE DRY AND STABLE.
2. MAXIMUM SLOPE OF STOCKPILE SHALL BE 1:2.
3. UPON COMPLETION OF SOIL STOCKPILING, EACH PILE SHALL BE SURROUNDED WITH EITHER SILT FENCING OR STRAWBALES, THEN STABILIZED WITH VEGETATION OR COVERED.


## 17 TEMPORARY SOIL STOCKPILE

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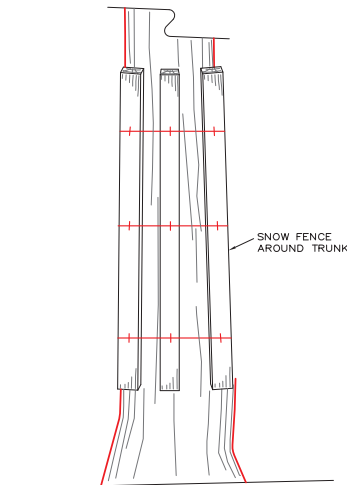
## 20 TREE PROTECTION

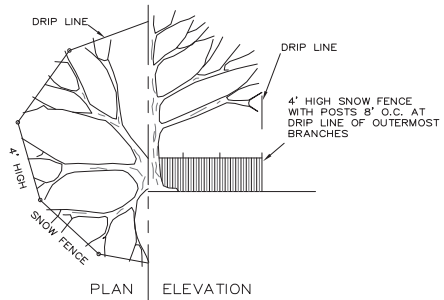N.T.S.



## 21 ANTI-TRACK PAD

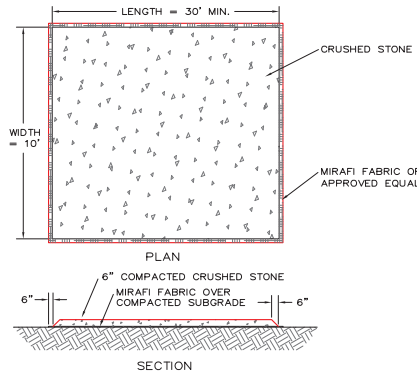
N.T.S.



TO BE USED NEAR CONSTRUCTION ACTIVITIES WHERE DRIPLINE PROTECTION WOULD IMPEDE ACTIVITIES.

## 18 TREE PROTECTION TRUNK ARMOR

N.T.S.

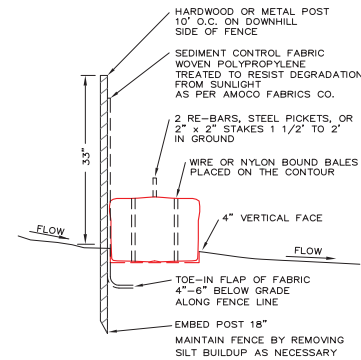

## 22 SILT FENCE & HAYBALE DETAIL

N.T.S.

### GENERAL EROSION CONTROL NOTES:

1. EROSION CONTROL MEASURES SHALL BE INSTALLED PRIOR TO THE START OF CONSTRUCTION AND MAINTAINED IN EFFECTIVE CONDITION THROUGHOUT THE CONSTRUCTION PERIOD.
2. ALL EROSION AND SEDIMENTATION CONTROL MEASURES AND PROCEDURES SHALL COMPLY WITH THE STANDARDS AND SPECIFICATIONS OF THE WESTCHESTER COUNTY BEST MANAGEMENT MANUAL FOR CONSTRUCTION RELATED ACTIVITIES.
3. PRIOR TO ANY EXCAVATION, SILT FENCE SHALL BE INSTALLED AT THE APPROPRIATE LOCATIONS NOTED ON EROSION CONTROL PLAN. SILT FENCING SHALL BE INSTALLED AS DIRECTED BY THE OWNER'S REPRESENTATIVE IN THE FIELD AND INSTALLED AS PER THE INSTRUCTIONS OF THE MANUFACTURER. ADDITIONAL SILT FENCE MAY BE PLACED BY THE OWNER'S REPRESENTATIVE IN THE FIELD. SILT FENCING SHALL BE MAINTAINED IN OPERABLE CONDITION AND SHALL NOT BE REMOVED UNTIL DISTURBED AREAS ARE THOROUGHLY STABILIZED.
4. IMMEDIATELY TOPSOIL & SEED WITH A MIXTURE OF PERENNIAL RYE GRASS, ANNUAL RYE GRASS AND WINTER RYE AND MULCH WITH 2" OF HAY ALL FINISHED SLOPES AND ALL ROUGH CUT SLOPES TO REMAIN OPEN FOR EXTENDED PERIODS.
5. ALL SLOPES CONSTRUCTED WITH FILL MATERIAL AND ALL SLOPES WITH GRADE 3:1 OR STEEPER SHALL BE TOPSOILED, SEED, MULCHED AND STABILIZED WITH STAKED TOBACCO NETTING, UNLESS OTHERWISE NOTED.
6. ALL AREAS OF DISTURBED SOIL SHALL BE STABILIZED. IN ADDITION TO ALL SPECIFIED AND LOCATED EROSION CONTROL DEVICES, THE CONTRACTOR SHALL TAKE ALL STEPS PRUDENT AND NECESSARY TO STABILIZE THE SITE AT ALL TIMES.
7. DO NOT STOCKPILE MATERIALS ON STEEP SLOPES, IN DRAINAGE SWALES OR IN WETLAND AREAS. SURROUND ALL STOCKPILE AREAS WITH STAKED HAYBALES OR SILT SCREEN MATERIALS.
8. ALL CATCHBASINS ARE TO BE PROTECTED WITH HAYBALE FILTERS THROUGHOUT THE CONSTRUCTION PERIOD AND UNTIL ALL DISTURBED AREAS ARE THOROUGHLY STABILIZED.
9. HAYBALES SHALL BE USED AT THE TOPS AND TOE OF SLOPES, AS NECESSARY, TO COLLECT SILT AND DIVERT FLOWS. SILT SCREENS WILL BE USED IN AREAS OF UNCONCENTRATED FLOWS TO COLLECT SILT. HAYBALES AND SILT SCREEN ON PLANS MAY BE AUGMENTED IN THE FIELD.
10. UTILITY LINE EXCAVATED MATERIAL SHALL BE TEMPORARILY STOCKPILED ON HIGH SIDE OF EXCAVATION SO RUNOFF IS DIRECTED AWAY FROM TRENCH. AFTER BACK-FILLING, AREA IS TO BE TOPSOILED, SEED, AND MULCHED.
11. ALL EROSION AND SEDIMENT CONTROL MEASURES SHALL BE INSPECTED IMMEDIATELY AFTER EACH RAINFALL AND AT LEAST DAILY DURING PROLONGED RAINFALL. ANY REQUIRED REPAIRS SHALL BE MADE IMMEDIATELY.
12. SEDIMENT DEPOSITS SHALL BE REMOVED WHEN THEY REACH APPROXIMATELY ONE-HALF THE HEIGHT OF THE BARRIER. SEDIMENT SHALL BE DISPOSED OF IN A MANNER THAT DOES NOT RESULT IN ADDITIONAL EROSION OR POLLUTION.
13. INSTALL GRAVEL BED AT CONSTRUCTION ENTRANCE TO SERVE AS ANTI-TRACKING PAD. GRAVEL BED TO BE 2" DIAMETER CRUSHED STONE 6" DEEP.
14. A WATERING TRUCK WILL BE USED IN DRY SEASON TO WET DOWN DUST AREAS.
15. BLASTING AREAS - ROCK RIPPING WILL BE USED WHEREVER POSSIBLE. BLASTING WILL OCCUR IN ACCORDANCE WITH ALL REGULATIONS.

### CONSTRUCTION NOTES:

1. THE CONTRACTOR SHALL LOCATE AND VERIFY IN THE FIELD ALL UTILITIES - GAS, WATER, ELECTRICAL BEFORE THE START OF CONSTRUCTION. CONTRACTOR SHALL CALL CODE 763 (FORMERLY CODE 53).
2. THE INSTALLATION OF WATER AND SEWER SHALL BE UNDER THE DIRECTION OF A N.Y. STATE LICENSED PROFESSIONAL ENGINEER.
3. EROSION CONTROL MEASURES, INCLUDING STAKED HAYBALES, SHALL BE REQUIRED AS DIRECTED BY THE COUNTY, ACCORDING TO STANDARDS DESCRIBED IN THE WESTCHESTER COUNTY BEST MANAGEMENT PRACTICES MANUAL FOR CONSTRUCTION ACTIVITIES.
4. AS BUILT PLANS SHALL BE REQUIRED AND CERTIFIED BY A N.Y. STATE LICENSED PROFESSIONAL ENGINEER.
5. ALL PROPERTY DISTURBED IN THE R.O.W. OR ON PRIVATE LANDS, SHALL BE RESTORED TO NEW CONDITIONS.
6. THE CONTRACTOR SHALL BE RESPONSIBLE FOR ALL APPLICATIONS AND PERMITS REQUIRED FOR CONSTRUCTION.
7. THE ROAD AND UTILITIES SHALL BE STAKED IN THE FIELD BY A N.Y. STATE LICENSED SURVEYOR OR ENGINEER.
8. UNDERGROUND GAS AND ELECTRIC SHALL BE AS REQUIRED BY THE COUNTY OF WESTCHESTER.
9. SITE TOPOGRAPHY IS BY OTHERS. NO CERTIFICATION IS GIVEN.


LEGAL NOTICE:  
ALTERATIONS BY ANY PERSON, IN ANY WAY, OF ANY ITEM CONTAINED ON THIS DOCUMENT, UNLESS ACTING UNDER DIRECTION OF THE LICENSED ENGINEER WHOSE PROFESSIONAL SEAL IS AFFIXED HERETO, IS A VIOLATION OF TITLE VII, SECT. 69.5 (B) OF NEW YORK STATE LAW.

WRITTEN DIMENSIONS ON THIS DRAWING SHALL HAVE PRECEDENCE OVER SCALED DIMENSIONS AND CONDITIONS ON THE JOB. THIS OFFICE MUST BE NOTIFIED OF ANY VARIATIONS FROM DIMENSIONS AND CONDITIONS SHOWN BY THESE DRAWINGS. SHOP DETAILS MUST BE SUBMITTED TO THIS OFFICE FOR APPROVAL BEFORE PROCEEDING WITH FABRICATION.

### STORMWATER DEVICE MAINTENANCE SCHEDULE

Temporary-During Construction	Weekly	Monthly	Bi-Annually	Annually	Prior To Significant Rainfall	After Significant Rainfall
Haybales		Inspect			Inspect	Inspect/Clean
Silt Fence		Inspect			Inspect	Inspect/Clean
Sediment Trap		Inspect	Clean			Inspect/Clean
Anti-Tracking Pad (Stabilized Construction Entrance)	Inspect				Inspect	Inspect
Inlet Protection	Inspect					Inspect
Catch Basins/Inlets	Inspect				Inspect	Inspect/Clean
Permanent - After Construction						
Catch Basins/Inlets			Clean			Inspect
Control Structures			Inspect/Clean			Inspect

Permanent Stormwater Features	Weekly	Monthly	Bi-Annually	Annually	Prior To Significant Rainfall	After Significant Rainfall
Haybales		Inspect			Inspect	Inspect/Clean
Silt Fence		Inspect			Inspect	Inspect/Clean
Chambers			Inspect			
Filters		Inspect				Inspect

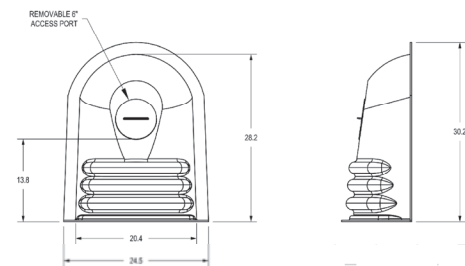

ENVIRONMENTAL PART NUMBER 7004-110-108 AS MANUFACTURED BY NYLOPLAST CO., OR AN APPROVED EQUAL. INSTALL IN CATCHBASIN CB4 AT 12 INCH OUTLET PIPE AND PROVIDE 3 FOOT SUMP.




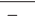
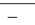
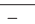
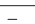
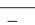
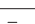














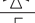




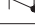




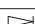
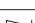

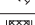






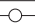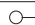


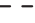

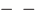
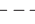
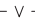
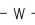


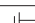ENVIRONMENTAL PART NUMBER 7004-110-108 AS MANUFACTURED BY NYLOPLAST CO., OR AN APPROVED EQUAL. INSTALL IN CATCHBASIN CB4 AT 12 INCH OUTLET PIPE AND PROVIDE 3 FOOT SUMP.

## 23 CATCH BASIN OIL & DEBRIS SEPARATOR INSERT

N.T.S.



				RALPH G. MASTROMONACO, P.E., P.C. Consulting Engineers 13 Dove Court, Gorton-on-Hudson, New York 10520 (914) 271-4762 (914) 271-2820 Fax					
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WESTCHESTER COUNTY, NEW YORK DEPARTMENT OF PUBLIC WORKS DIVISION OF ENGINEERING									
NEW GOLF CART STORAGE FACILITY AND CLUBHOUSE UPGRADES MOHANSIC GOLF COURSE, YORKTOWN, NEW YORK CONSTRUCTION DETAILS									
SCALE: AS SHOWN				DATE: 6/4/21		SHEET NUMBER		SHEET NUMBER	
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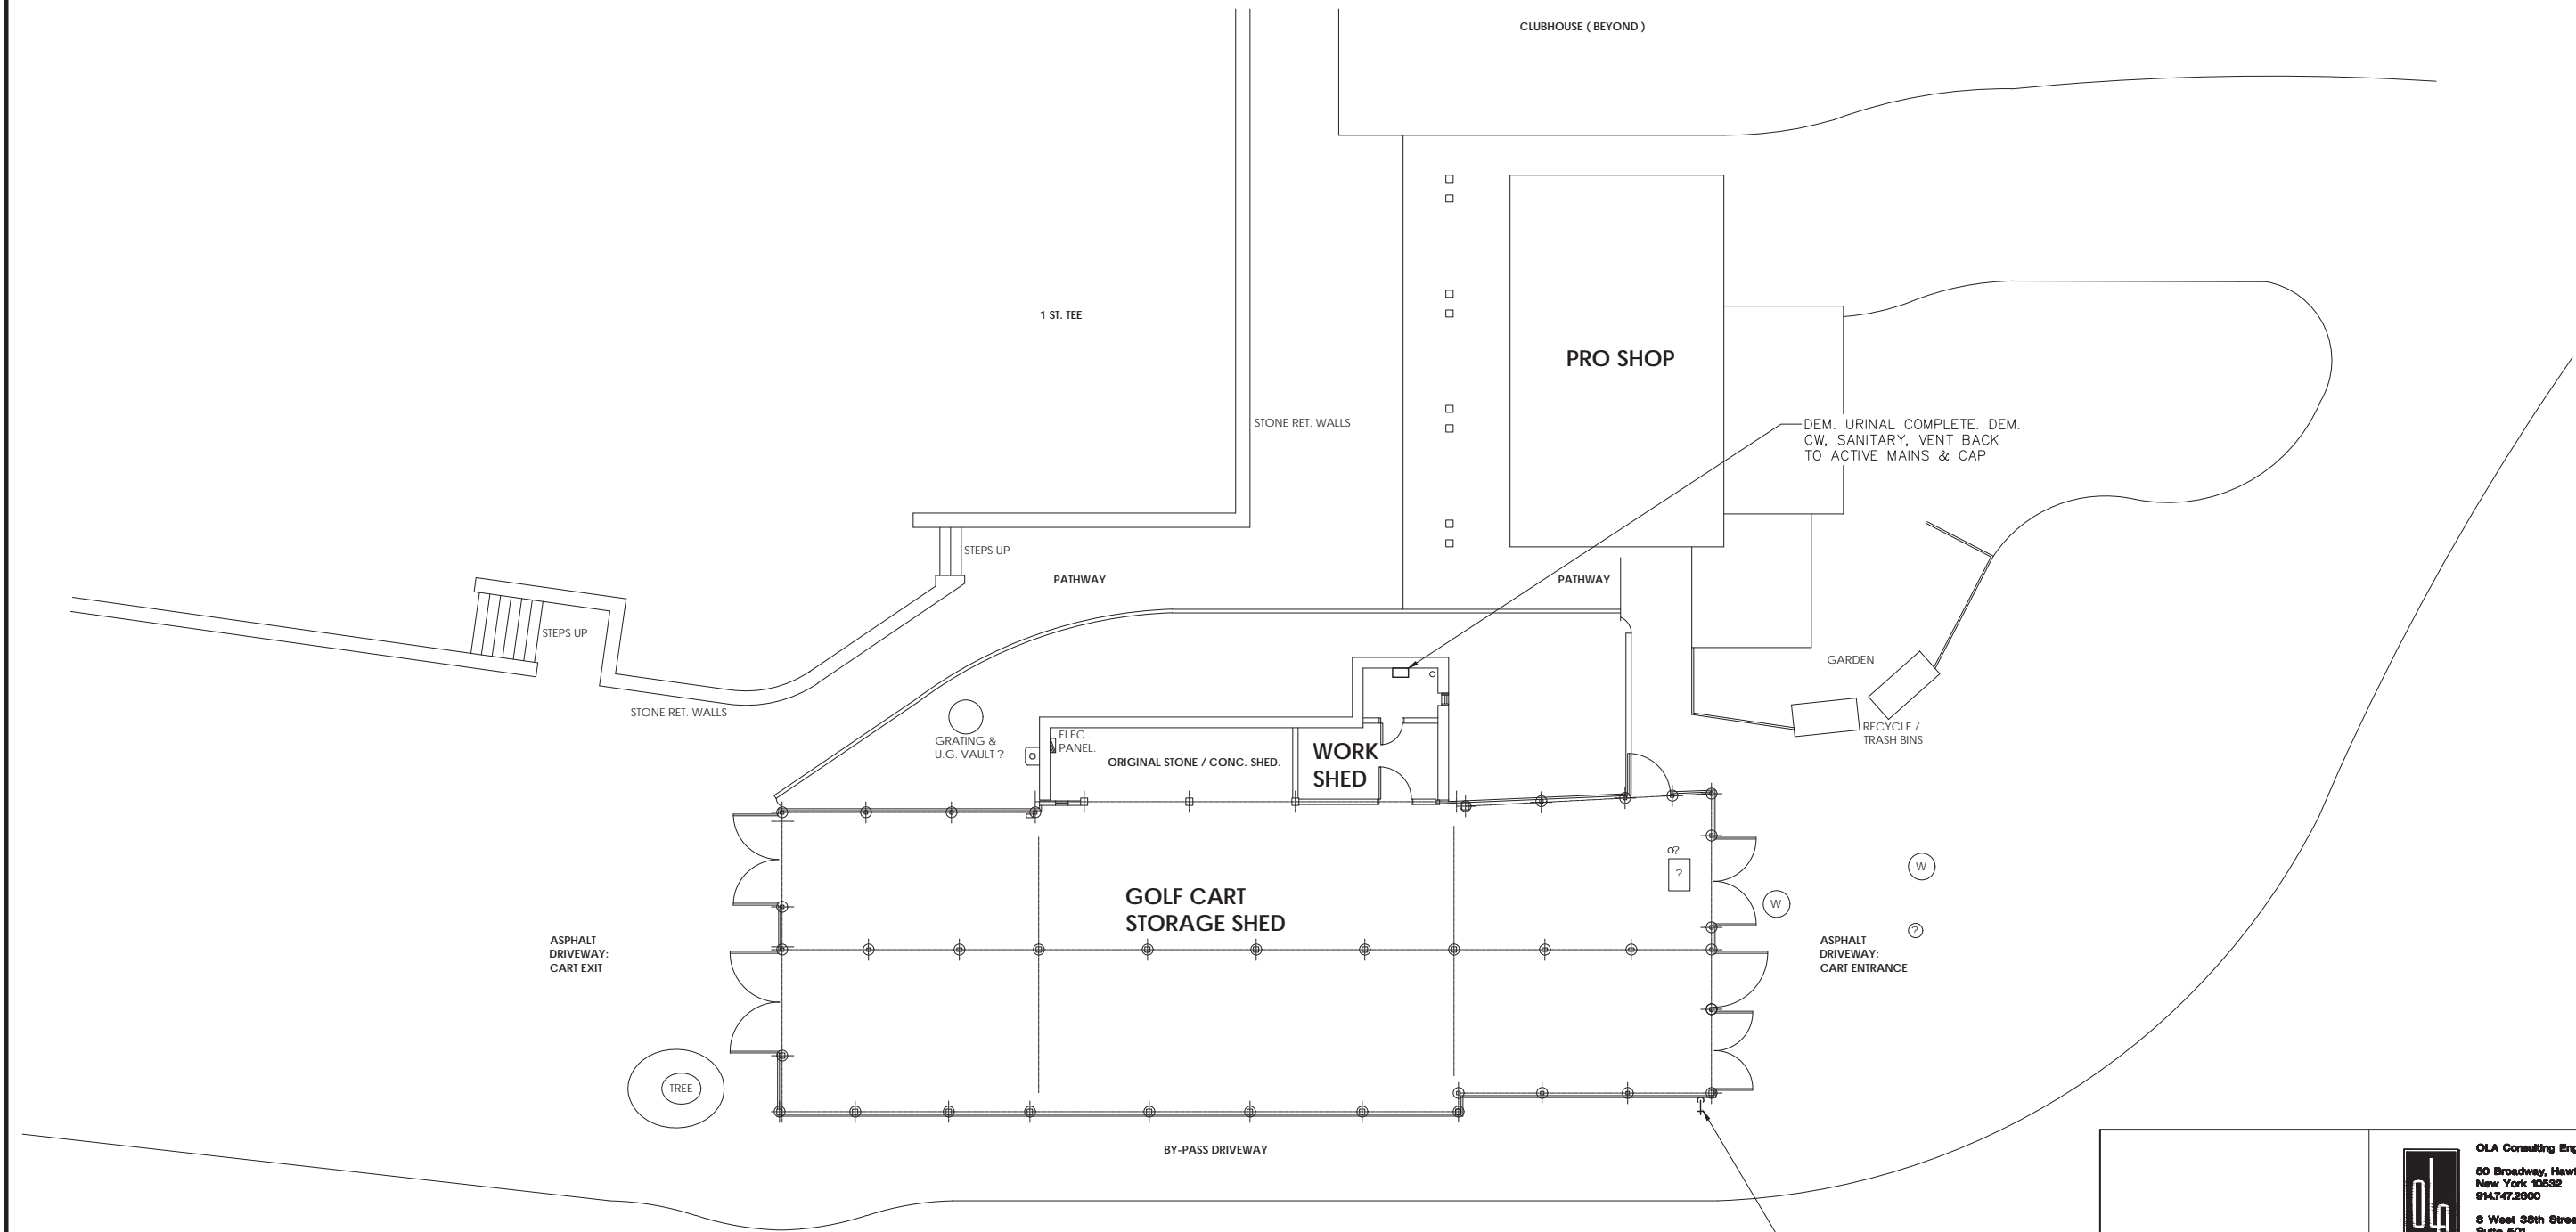



	SYMBOL & ABBREVIATIONS			GENERAL NOTES	EQUIPMENT NOTES CONTINUED
	SYMBOL	ABBREVIATION	DESCRIPTION	<div>1. THE CONTRACT DRAWINGS INDICATE THE EXTENT AND GENERAL ARRANGEMENTS OF THE PLUMBING SYSTEMS. IF ANY DEPARTURES FROM THE DRAWINGS ARE DEEMED NECESSARY BY THE PLUMBING CONTRACTOR, DETAILS OF SUCH DEPARTURES AND THE REASONS THEREFORE SHALL BE SUBMITTED TO THE OWNER AND ENGINEER FOR APPROVAL. NO SUCH DEPARTURES SHALL BE MADE WITHOUT PRIOR WRITTEN APPROVAL OF THE OWNER AND ENGINEER. EQUIPMENT AND PIPING ARRANGEMENTS SHALL PROVIDE ADEQUATE AND ACCEPTABLE CLEARANCES FOR ENTRY, SERVICING, AND MAINTENANCE. ANY CHANGES TO PIPING AND EQUIPMENT LOCATIONS NECESSARY TO AVOID INTERFERENCE WITH OTHER TRADES SHALL BE MADE AT NO EXTRA COST.</div> <div>2. THE PLUMBING WORK SHALL BE PERFORMED IN STRICT ACCORDANCE WITH THE LATEST EDITION OF THE PREVAILING NEW YORK STATE PLUMBING AND BUILDING CODES. IN CASE OF CONFLICT BETWEEN THE CONTRACT DOCUMENTS AND A GOVERNING CODE OR ORDINANCE, THE MORE STRINGENT STANDARD SHALL APPLY.</div> <div>3. THE PLUMBING CONTRACTOR SHALL BE RESPONSIBLE FOR OBTAINING ALL NECESSARY PERMITS AND FOR PAYING RELATED FEES.</div> <div>4. CONNECTIONS TO EXISTING UTILITIES AND SERVICES ARE SHOWN ACCORDING TO THE BEST INFORMATION AVAILABLE. THE CONTRACTOR SHALL VERIFY THE EXACT LOCATIONS, INVERT ELEVATIONS, AND SIZES OF EXISTING PLUMBING SERVICES IN FIELD, AND SHALL CONNECT NEW PLUMBING SERVICES AS INDICATED ON DRAWINGS.</div> <div>5. PRIOR TO FABRICATION, THIS CONTRACTOR SHALL VERIFY ALL MEASUREMENTS AND CONDITIONS ON JOB SITE, AND COORDINATE THIS WORK WITH THE WORK OF ALL OTHER TRADES.</div> <div>6. ALL ACCESS PANELS SHALL BE BY GENERAL CONTRACTOR. THE PLUMBING CONTRACTOR SHALL BE RESPONSIBLE FOR THEIR FEES.</div> <div>7. PROVIDE ALL PLUMBING FIXTURES, PIPING, VALVES AND ACCESSORY ITEMS AS SPECIFIED AND AS REQUIRED FOR A COMPLETE INSTALLATION. ROUGHING DIMENSIONS OF FIXTURES MUST BE COORDINATED WITH THE GENERAL CONTRACTOR.</div> <div>8. PITCH ALL WASTE, SANITARY, AND STORM DRAIN PIPING AT MAXIMUM SLOPE POSSIBLE, BUT NOT LESS THAN 1/8" PER FOOT FOR PIPING ≥3" AND 1/4" PER FOOT FOR PIPING ≤ 2½".</div> <div>9. NO PIPING SHALL RUN EXPOSED IN FINISHED AREAS.</div> <div>10. PROVIDE DIELECTRIC FITTINGS OR COUPLINGS WHEREVER DISSIMILAR METALS ARE JOINED.</div> <div>11. PROVIDE SHUTOFF VALVES AT ALL FIXTURES AND EQUIPMENT ON COLD WATER, AND HOT WATER PIPES.</div> <div>12. ALL WORK SHALL BE PROPERLY TESTED, BALANCED, AND CLEANED AND DISINFECTED. PROVIDE A ONE YEAR WARRANTY FROM DATE OF FINAL INSPECTION ON ALL PARTS AND LABOR.</div> <div>13. PROVIDE ALL PIPE OPENINGS THROUGH PARTITIONS WITH PIPE SLEEVES. FOR PIPES PENETRATING FIRE RATED PARTITIONS, THE SPACE BETWEEN THE PIPE AND THE SLEEVE SHALL BE SEALED WITH FIRE STOPPING MATERIAL. PENETRATIONS FOR PIPING SHALL BE MADE BY CORE DRILLING WHENEVER POSSIBLE.</div> <div>14. PROVIDE TRAP SEAL PRIMERS FOR FLOOR DRAINS WHERE INDICATED ON PLAN. INSTALL THE PRIMER VALVE IN THE COLD WATER SERVICE, WITH THE TRAP CONNECTION PIPED TO THE FLOOR DRAIN TRAP. LOCATE THE VALVE IN AN ACCESSIBLE LOCATION.</div> <div>15. NEW PIPING LAYOUT IS PREDICATED ON RECORD DRAWING DATA OF EXISTING RISERS AND DRAWINGS. MODIFICATIONS TO THE LAYOUT MAY BE REQUIRED DUE TO DIFFERENT ACTUAL CONDITIONS, OBSTRUCTIONS, INTERFERENCES, ETC.</div> <div>16. SEE THE ARCHITECTURAL DRAWINGS FOR EXACT PHASING AND TIME SCHEDULE FOR CONSTRUCTION.</div> <div>17. ALL MOTOR STARTERS AND DISCONNECT SWITCHES FOR PLUMBING EQUIPMENT SHALL BE FURNISHED BY THE PLUMBING CONTRACTOR AND INSTALLED BY THE ELECTRICAL CONTRACTOR, UNLESS OTHERWISE NOTED. DISCONNECT SWITCHES FURNISHED BY THE PLUMBING CONTRACTOR FOR PLUMBING EQUIPMENT SHALL BE HEAVY DUTY TYPE.</div> <div>18. THE CONTRACTOR SHALL BE RESPONSIBLE FOR PROVIDING TEMPORARY VENTILATION AND EXHAUST AIR WHEN WELDING OR SOLDERING OPERATIONS ARE PERFORMED, AS REQUIRED BY OSHA.</div>	<div>5.) <u>GASOLINE TANK – MAINTENANCE BUILDING</u>: SHALL BE ENVIRO–SAFE FIREGUARD 500 GALLON DOUBLE–WALL ABOVEGROUND FUEL TANK WITH INTEGRAL FUEL DISPENSING SYSTEM. PROVIDE STEEL SUPPORT SADDLES, LIFTING LUGS, 6" EMERGENCY VENT, 2" STACK VENT, 818 CLOCK GAUGE WITH FLOAT, 7.5 GALLON OVERSPILL WITH LOCKABLE CAP, SPIN ON FILTER AND HOUSING ASSEMBLY, INTERSTITIAL LEAK GAUGE, STEP LADDER AND PLATFORM, 16" MAN–WAY, BRACKET, PIPING BALL VALVE AND ANTI–SIPHON VALVE, SUCTION LINE FOOT–VALVE 6" FROM BOTTOM TANK, FILL–RITE 711VA PUMP 1" ASSEMBLY METER AND FILTER, 1" AUTOMATIC SHUT–OFF NOZZLE, SWIVEL, &amp; BREAKAWAY 18' X 1" HOSE. TANK SHALL BE PROVIDED WITH EPOXY PRIMER &amp; ACRYLIC POLYURETHANE COATING, UL2085 LABELED AND LISTED, NFPA–30–30A TESTED, 2–HOUR FIRE TESTED, IMPACT AND BALLISTIC TESTED. 60" DIAMETER X 100" LONG; DRY WEIGHT: 3,100 LBS. PROVIDE PNEUMERCATOR LS–600 LEVEL SWITCHES &amp; MP 450S LEVEL GAUGE PROBES. PROVIDE COMPLETE FIRE SUPPRESSION SYSTEM FOR COVERAGE OF THE TANK AND DISPENSING SYSTEM. COORDINATE WITH ARCHITECTURAL STRUCTURE ABOVE TANK.</div> <div>6.) <u>GASOLINE TANK – CART STORAGE</u>: SHALL BE ENVIRO–SAFE FIREGUARD 500 GALLON DOUBLE–WALL ABOVEGROUND FUEL TANK WITH INTEGRAL FUEL DISPENSING SYSTEM. PROVIDE STEEL SUPPORT SADDLES, LIFTING LUGS, 6" EMERGENCY VENT, 2" STACK VENT, 818 CLOCK GAUGE WITH FLOAT, 7.5 GALLON OVERSPILL WITH LOCKABLE CAP, SPIN ON FILTER AND HOUSING ASSEMBLY, INTERSTITIAL LEAK GAUGE, STEP LADDER AND PLATFORM, 16" MAN–WAY, BRACKET, PIPING BALL VALVE AND ANTI–SIPHON VALVE, SUCTION LINE FOOT–VALVE 6" FROM BOTTOM TANK, FILL–RITE 711VA PUMP 1" ASSEMBLY METER AND FILTER, 1" AUTOMATIC SHUT–OFF NOZZLE, SWIVEL, &amp; BREAKAWAY 18' X 1" HOSE. TANK SHALL BE PROVIDED WITH EPOXY PRIMER &amp; ACRYLIC POLYURETHANE COATING, UL2085 LABELED AND LISTED, NFPA–30–30A TESTED, 2–HOUR FIRE TESTED, IMPACT AND BALLISTIC TESTED. 60" DIAMETER X 100" LONG; DRY WEIGHT: 3,100 LBS. PROVIDE PNEUMERCATOR LS–600 LEVEL SWITCHES &amp; MP 450S LEVEL GAUGE PROBES. PROVIDE COMPLETE FIRE SUPPRESSION SYSTEM FOR COVERAGE OF THE TANK AND DISPENSING SYSTEM. COORDINATE WITH ARCHITECTURAL STRUCTURE ABOVE TANK.</div> <div>7.) <u>DIESEL TANK</u>: SHALL BE ENVIRO–SAFE FIREGUARD 500 GALLON DOUBLE–WALL ABOVEGROUND FUEL TANK WITH INTEGRAL FUEL DISPENSING SYSTEM. PROVIDE STEEL SUPPORT SADDLES, LIFTING LUGS, 6" EMERGENCY VENT, 2" STACK VENT, 818 CLOCK GAUGE WITH FLOAT, 7.5 GALLON OVERSPILL WITH LOCKABLE CAP, SPIN ON FILTER AND HOUSING ASSEMBLY, INTERSTITIAL LEAK GAUGE, STEP LADDER AND PLATFORM, 16" MAN–WAY, BRACKET, PIPING BALL VALVE AND ANTI–SIPHON VALVE, SUCTION LINE FOOT–VALVE 6" FROM BOTTOM TANK, FILL–RITE 711VA PUMP 1" ASSEMBLY METER AND FILTER, 1" AUTOMATIC SHUT–OFF NOZZLE, SWIVEL, &amp; BREAKAWAY 18' X 1" HOSE. TANK SHALL BE PROVIDED WITH EPOXY PRIMER &amp; ACRYLIC POLYURETHANE COATING, UL2085 LABELED AND LISTED, NFPA–30–30A TESTED, 2–HOUR FIRE TESTED, IMPACT AND BALLISTIC TESTED. 60" DIAMETER X 100" LONG; DRY WEIGHT: 3,100 LBS. PROVIDE PNEUMERCATOR LS–600 LEVEL SWITCHES &amp; MP 450S LEVEL GAUGE PROBES. PROVIDE COMPLETE FIRE SUPPRESSION SYSTEM FOR COVERAGE OF THE TANK AND DISPENSING SYSTEM. COORDINATE WITH ARCHITECTURAL STRUCTURE ABOVE TANK.</div> <div>8.) <u>FUEL OIL STORAGE TANK</u>: SHALL BE ENVIRO–SAFE FIREGUARD 1,000 GALLON DOUBLE–WALL ABOVEGROUND FUEL OIL STORAGE TANK. PROVIDE STEEL SUPPORT SADDLES, LIFTING LUGS, 6" EMERGENCY VENT, 2" STACK VENT, 818 CLOCK GAUGE WITH FLOAT, 7.5 GALLON 4" ALUMINUM OVERSPILL CONTAINER 179 SERIES WITH HINGED STYLE FILL CAP, MEMCO 1" RETURN LINE, 1.5" PICKUP WITH DROP TUBE AND FOOT VALVE 6" FROM BOTTOM TANK, INTERSTITIAL LEAK GAUGE, STEP LADDER WITH PLATFORM, &amp; 16" MAN–WAY. TANK SHALL BE PROVIDED WITH EPOXY PRIMER &amp; ACRYLIC POLYURETHANE COATING, UL2085 LABELED AND LISTED, NFPA–30–30A TESTED, 2–HOUR FIRE TESTED, IMPACT AND BALLISTIC TESTED. 56" DIAMETER X 150" LONG; DRY WEIGHT: 5,800 LBS. PROVIDE PNEUMERCATOR LS–600 LEVEL SWITCHES &amp; MP 450S LEVEL GAUGE PROBES. PROVIDE COMPLETE FIRE SUPPRESSION SYSTEM FOR COVERAGE OF THE TANK. COORDINATE WITH ARCHITECTURAL STRUCTURE ABOVE TANK.</div> <div>9.) <u>TANK LEVEL MONITORING SYSTEM</u>: SHALL BE BASED ON PNEUMERCATOR TMS3000 SERIES MODULAR MULTI–TANK GAUGING SYSTEM WITH EPA COMPLIANT IN TANK AND SECONDARY CONTAINMENT LEAK DETECTION; ELECTRICAL: 115/230V/1/60. PROVIDE (1) MONITORING SYSTEM AT THE MAINTENANCE BUILDING FOR MONITORING OF THE GASOLINE, DIESEL, AND FUEL OIL TANKS. PROVIDE (1) MONITORING SYSTEM AT THE CART STORAGE BUILDING FOR MONITORING OF THE GASOLINE TANK.</div>
		AFF	ABOVE FINISHED FLOOR		
		AHC	ABOVE HUNG CEILING		
		BFP	BACK FLOW PREVENTOR		
		VTR	VENT THROUGH ROOF		
		FAI	FRESH AIR INTAKE		
		FS	FLOOR SINK		
		RPZ	REDUCED PRESSURE ZONE – BFP		
		DCV	DOUBLE CHECK VALVE – BFP		
		TYP	TYPICAL		
		H.W. HTR	HOT WATER HEATER		
		–	3–WAY VALVE		
		–	BUTTERFLY VALVE		
		–	2–WAY VALVE		
		–	PLUG VALVE		
		–	SOLENOID VALVE		
		–	GATE VALVE		
		–	GLOBE VALVE		
		–	CHECK VALVE		
		–	OS&Y GATE VALVE		
		–	BALL VALVE		
		–	CIRCUIT SETTER		
		–	MANUAL AIR VENT		
		–	T&P RELIEF VALVE		
		–	PRESSURE REDUCING VALVE		
		–	TEE DOWN		
		–	ELBOW DOWN		
		–	TEE UP		
		–	ELBOW UP		
		–	PIPE CAP		
		CODP	CLEAN OUT DECK PLATE		
		WCO	WALL CLEAN OUT		
		FCO	FLOOR CLEAN OUT		
		–	CONCENTRIC REDUCER		
		–	ECCENTRIC REDUCER		
		–	STRAINER		
		–	FLEXIBLE CONNECTION		
		–	FLOW ARROW		
		–	PRESSURE GAGE		
		–	PUMP		
	–	THERMOMETER			
	–	UNION			
	EX.	EXISTING TO REMAIN			
	REL.	REMOVE AND RELOCATE			
	NEW	NEW WORK			
	DEM.	EXISTING TO BE REMOVED			
	CW	COLD WATER			
	HW	HOT WATER			
	HWC	HOT WATER RECIRCULATION			
	V	VENT			
	W	WASTE LINE			
	S	SANITARY			
	LDR	LEADER			
	SD	STORM DRAINAGE			
	PD	PUMP DISCHARGE			

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CHECKED BY <u>RG</u>				
MADE BY <u>AMB</u>				

EQUIPMENT NOTES			
<div>1.) <u>DOMESTIC HOT WATER HEATER, HWH–1</u> SHALL BE ELECTRIC AO–SMITH XI – MODEL DRE–52–6; PROVIDING 25 GPH RECOVERY AT 40°–140°, 6kW INPUT, 50 GALLONS NOMINAL STORAGE CAPACITY, 55" HIGH, 27" DIAMETER, 260 POUNDS SHIPPING WEIGHT. PROVIDE CONDENSATE NEUTRALIZATION SYSTEM &amp; P–TRAP. FURNISH DISCONNECT SWITCH FOR EACH HOT WATER HEATER TO BE INSTALLED BY THE ELECTRICAL CONTRACTOR.</div> <div>2.) DOMESTIC HOT WATER RE–CIRCULATION PUMP, <u>HWC–1</u>, TO BE BASED ON BELL &amp; GOSSETT MODEL NBF–18S, 100% LEAD FREE, 90 WATTS, 115V–1 PHASE–60 HERTZ, 0.74 FULL LOAD AMPS, 3000 RPM AND 5 GPM @ 10 FEET HEAD. FURNISH DISCONNECT SWITCH TO BE INSTALLED BY THE ELECTRICAL CONTRACTOR.</div>			



<div><div><div>OLA Consulting Engineers 60 Broadway, Hawthorne, New York 10632 914.747.2800  8 West 38th Street, Suite 601 New York, NY 10018 646.849.4110  OLA0006.00 olaee.com</div></div><div></div></div>				
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CONTRACTOR		PROJECT COORDINATOR		
NAME		NAME		
SIGNATURE		SIGNATURE		
TITLE	DATE	TITLE	DATE	
WESTCHESTER COUNTY, NEW YORK DEPARTMENT OF PUBLIC WORKS DIVISION OF ENGINEERING				CONTRACT NUMBER 17 - 539 SHEET NUMBER P-001 SHEET NO. 29 OF 59
NEW GOLF CART STORAGE FACILITY AND CLUBHOUSE UPGRADES MOHANSIC GOLF COURSE, YORKYOWN, NEW YORK PLUMBING SYMBOLS, ABBREVIATIONS, & NOTES				SCALE: NONE DATE: 6/4/21 DPW FILE NO. 10-02-P-62-0 REV. NO. 0





 1  
CART STORAGE SHED  
PLUMBING DEMOLITION PLAN  
SCALE: 1/8" = 1'-0"

IN CHARGE OF JW  
CHECKED BY RG  
MADE BY AMB

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REVISION			
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CONTRACTOR		PROJECT COORDINATOR	
NAME SIGNATURE	DATE	NAME SIGNATURE	DATE
TITLE	TITLE	TITLE	TITLE
WESTCHESTER COUNTY, NEW YORK DEPARTMENT OF PUBLIC WORKS DIVISION OF ENGINEERING		CONTRACT NUMBER 17 - 539	SHEET NUMBER P-101
NEW GOLF CART STORAGE FACILITY AND CLUBHOUSE UPGRADES MOHANSIC GOLF COURSE, YORKYOWN, NEW YORK CART STORAGE SHED PLUMBING DEMOLITION PLAN		SCALE: 1/8" = 1'-0" DATE: 6/4/21 DPW FILE NO. 10-02-P-63-0	REV. NO. 0



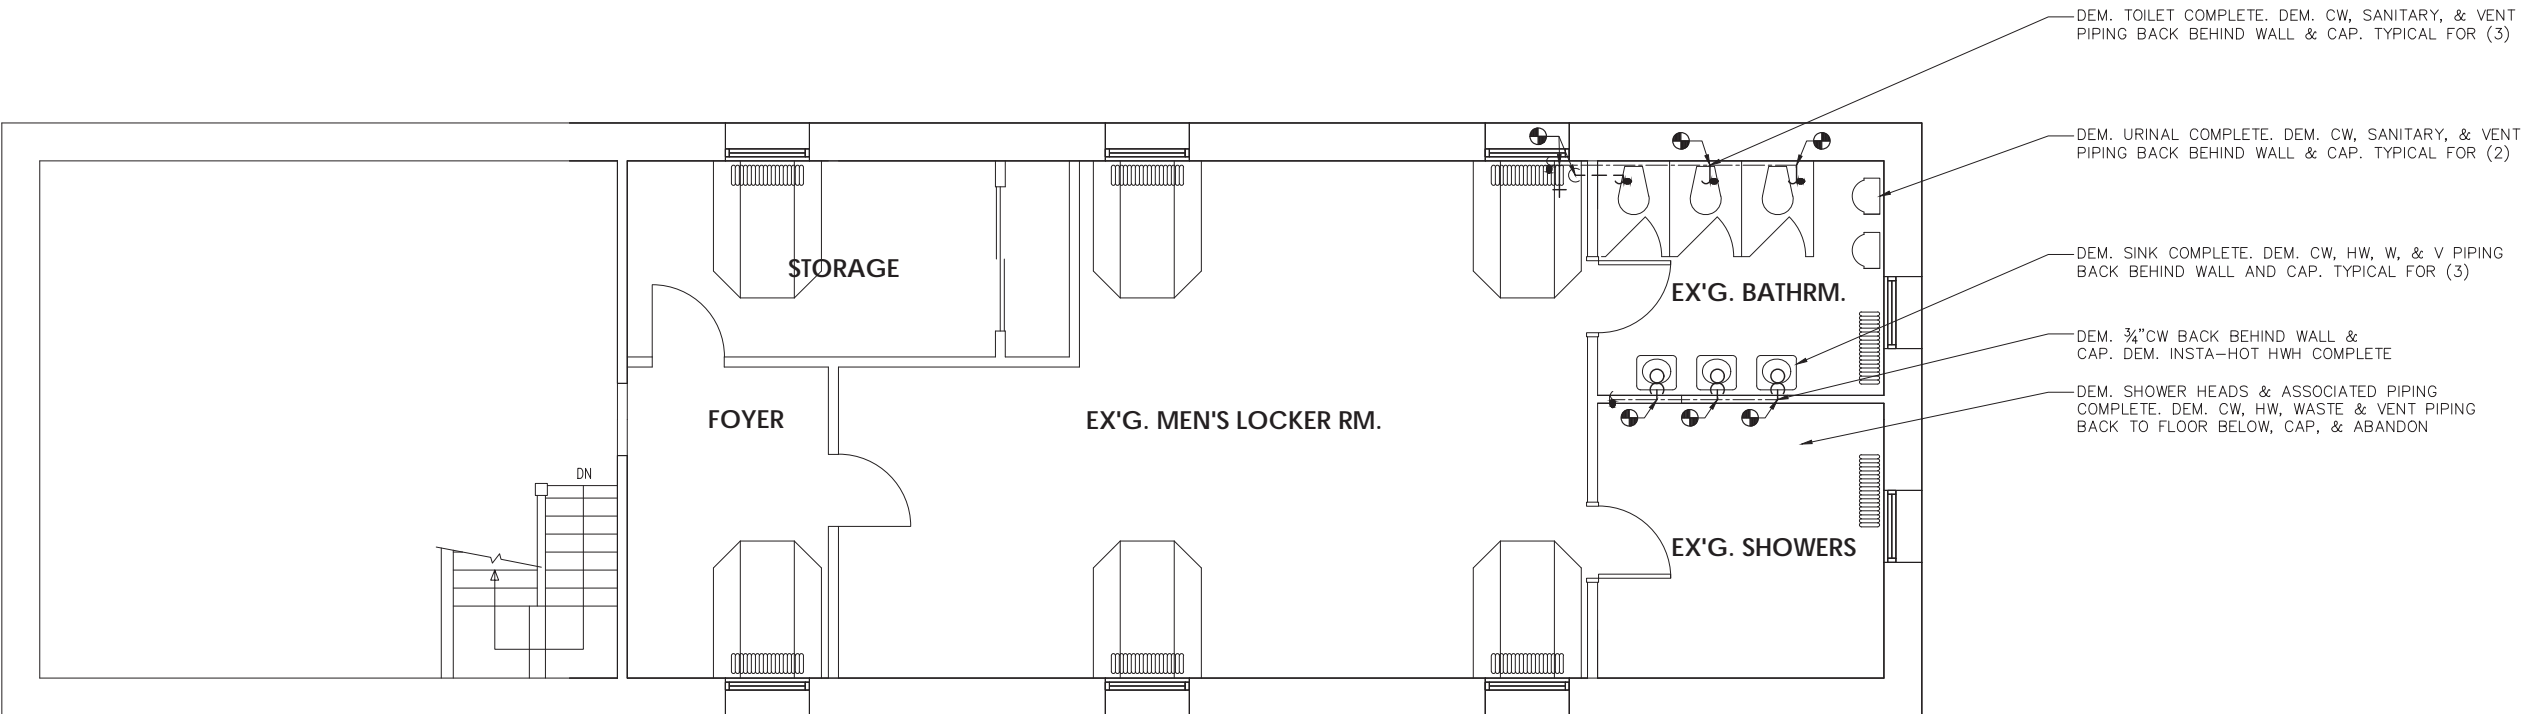

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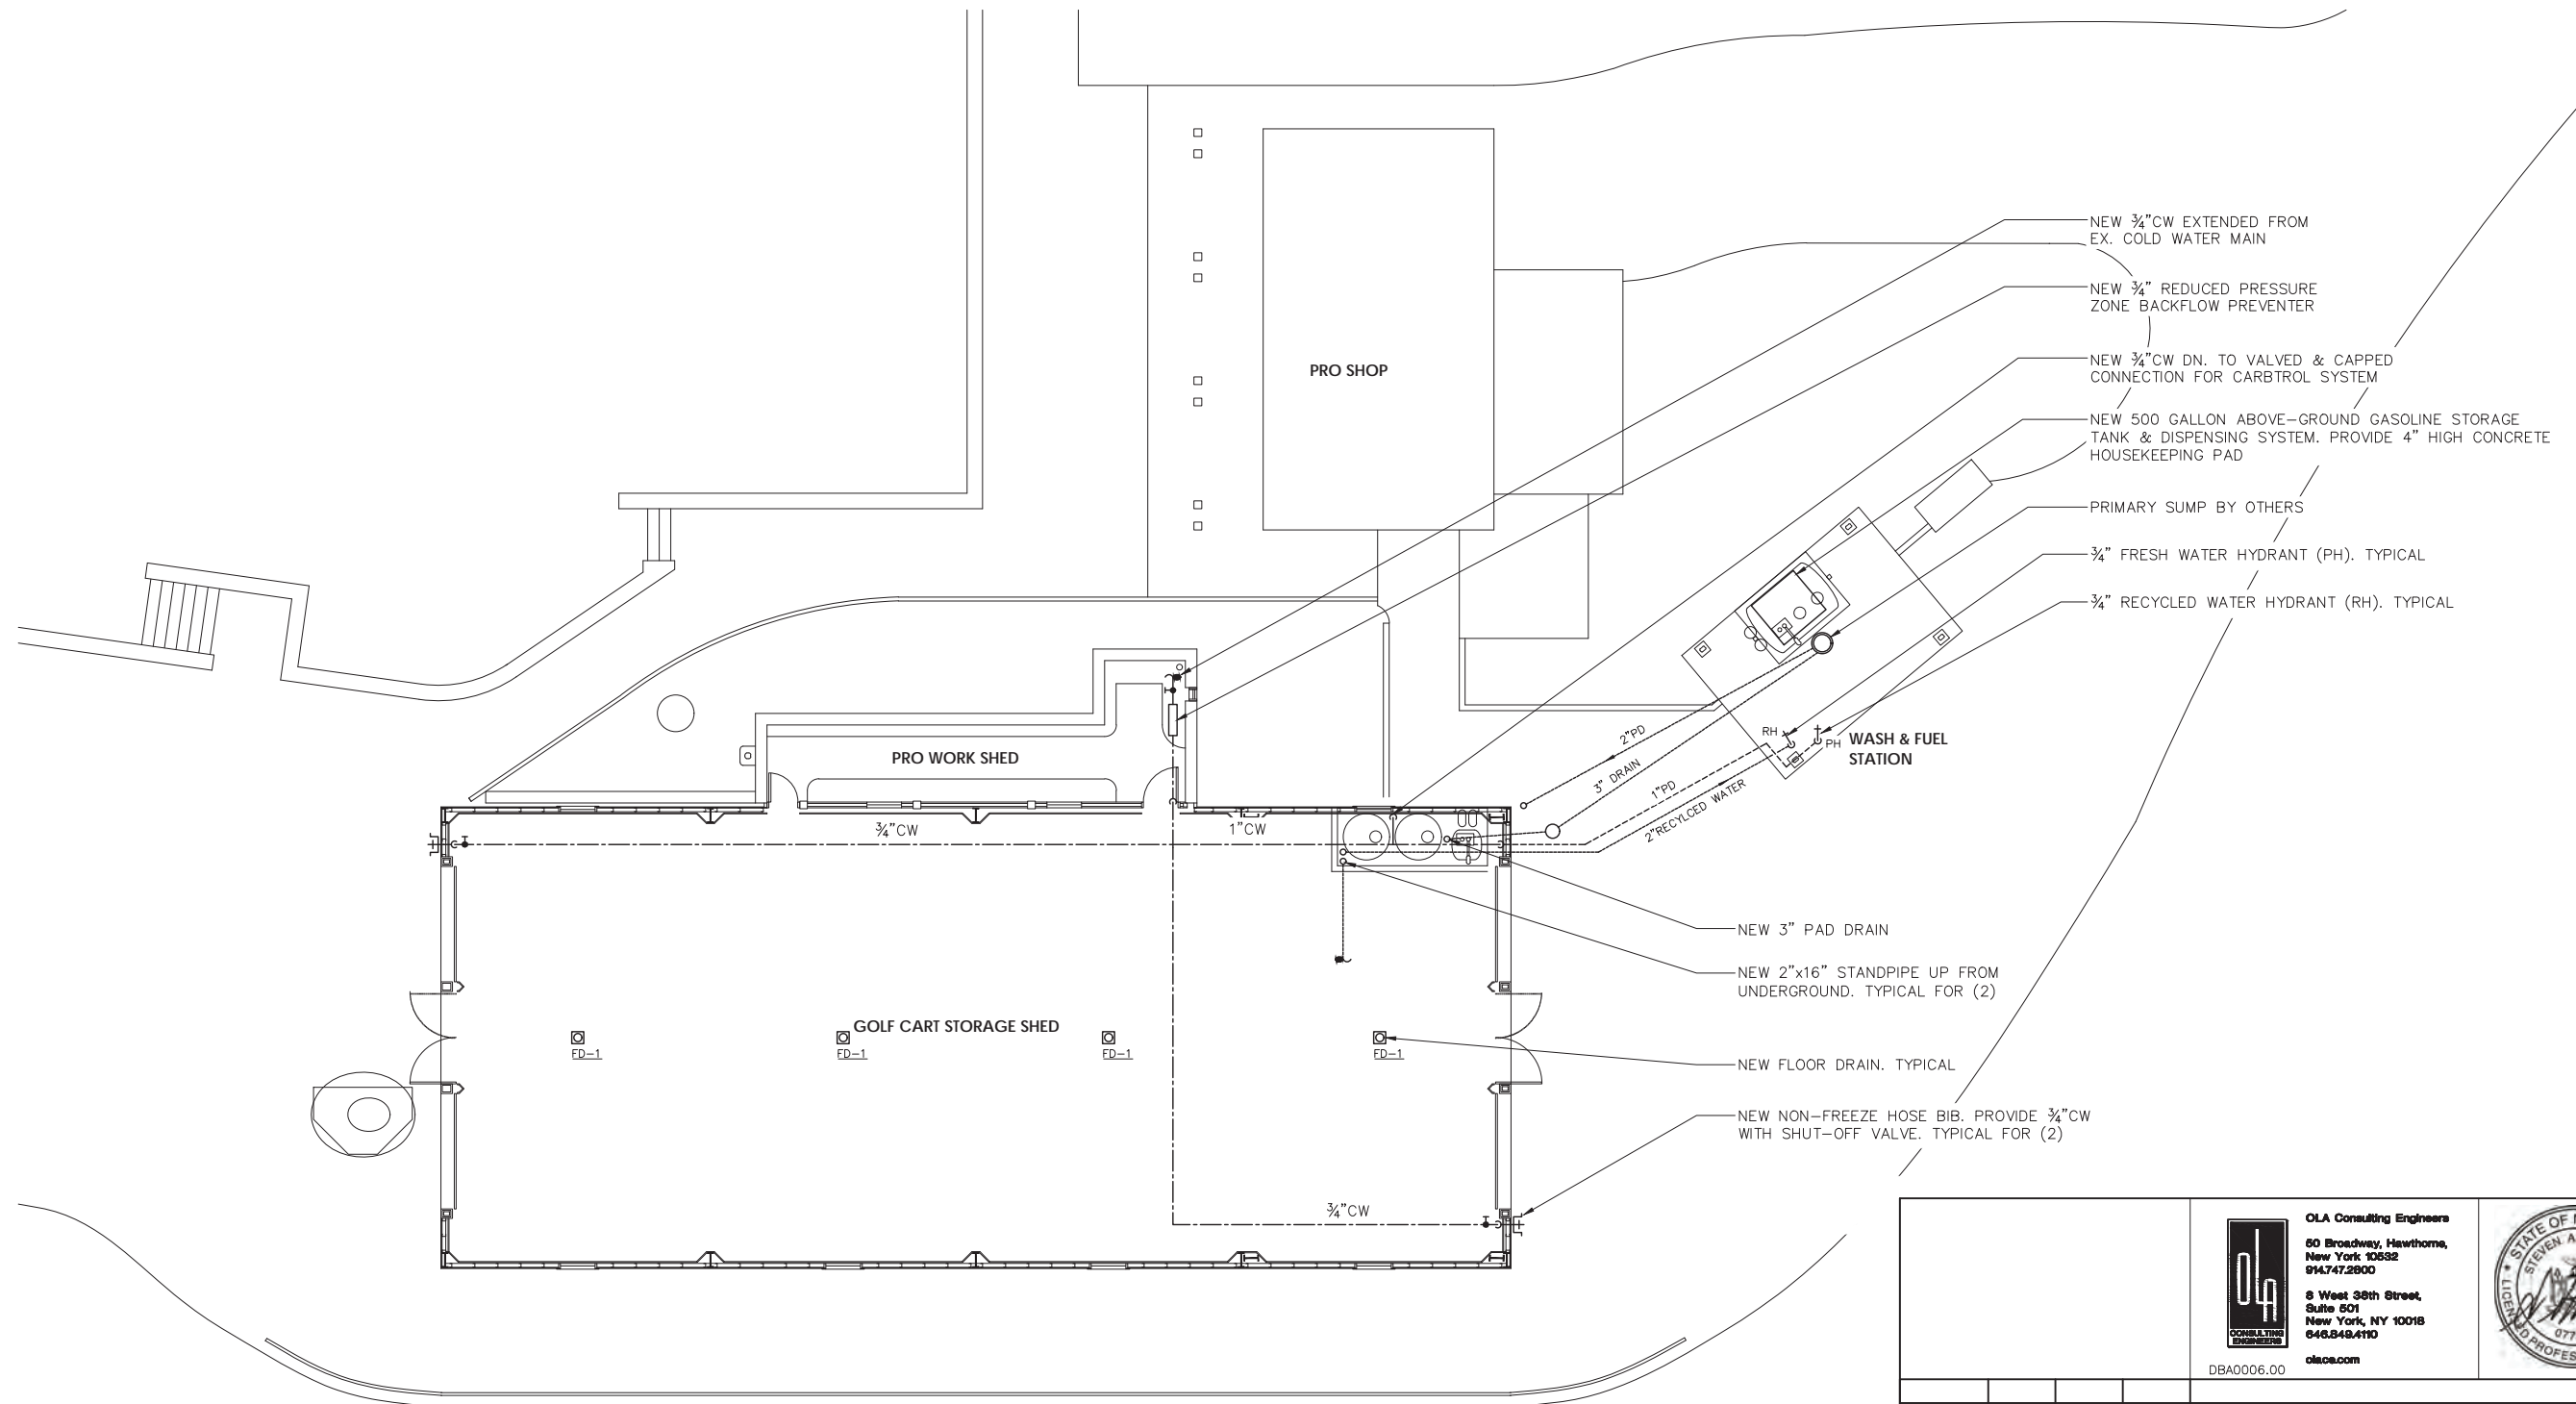
**BATHROOMS & LOCKERS  
PLUMBING DEMOLITION PLAN**  
SCALE: 1/4" = 1'-0"

NOTES:  
1. COORDINATE CUTTING & PATCHING OF FIRST FLOOR PRO SHOP CEILING FOR WORK ASSOCIATED WITH BATHROOM RENOVATIONS.  
2. DEM. GREASE INTERCEPTOR (G.I.) COMPLETE AT KITCHEN. PROVIDE 3" WASTE SPOOL PIECE TO CONNECT INLET & OUTLET PIPING AT REMOVED G.I. INSPECT, SCOPE, CLEAN, JET-WASH, ETC. EX. 3"W LINE FROM KITCHEN. PROVIDE RESULTS TO OWNER/ENGINEER FOR REVIEW & RECORD.

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

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TITLE	TITLE	TITLE	TITLE
WESTCHESTER COUNTY, NEW YORK DEPARTMENT OF PUBLIC WORKS DIVISION OF ENGINEERING		CONTRACT NUMBER 17 - 539	SHEET NUMBER P-102
NEW GOLF CART STORAGE FACILITY AND CLUBHOUSE UPGRADES MOHANSIC GOLF COURSE, YORKYOWN, NEW YORK BATHROOMS & LOCKERS PLUMBING DEMOLITION PLAN		SCALE: 1/4" = 1'-0" DATE: 6/4/21 DPW FILE NO. 10-02-P-64-0	REV. NO. 0




CART STORAGE SHED  
PLUMBING NEW WORK PLAN  
SCALE: 1/8" = 1'-0"  
NOTES:  
1. ALL DOMESTIC WATER PIPING WITHIN CART STORAGE SHALL BE HEAT TRACED TO AVOID FREEZING DURING WINTER MONTHS.  
2. PROVIDE VALVED & CAPPED CONNECTIONS AT LOW POINTS FOR WINTER DRAIN DOWN OF THE DOMESTIC WATER SYSTEM.  
3. REFER TO CARBTROL WASH RECYCLE EQUIPMENT DRAWING EQ-101 FOR UNDERGROUND PIPING REQUIREMENTS RELATED TO WASH STATIONS. FINAL LAYOUT & POINTS OF CONNECTION. COORDINATE SIZE, LOCATION, & MATERIALS WITH CARBTROL.

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WESTCHESTER COUNTY, NEW YORK DEPARTMENT OF PUBLIC WORKS DIVISION OF ENGINEERING		CONTRACT NUMBER 17 - 539	SHEET NUMBER P-201
NEW GOLF CART STORAGE FACILITY AND CLUBHOUSE UPGRADES MOHANSIC GOLF COURSE, YORKTOWN, NEW YORK CART STORAGE SHED PLUMBING NEW WORK PLAN		SHEET NO. 32 OF 59	SCALE: 1/8" = 1'-0" DATE: 6/4/21 DPW FILE NO. 10-02-P-65-0
		REV. NO. 0	




1
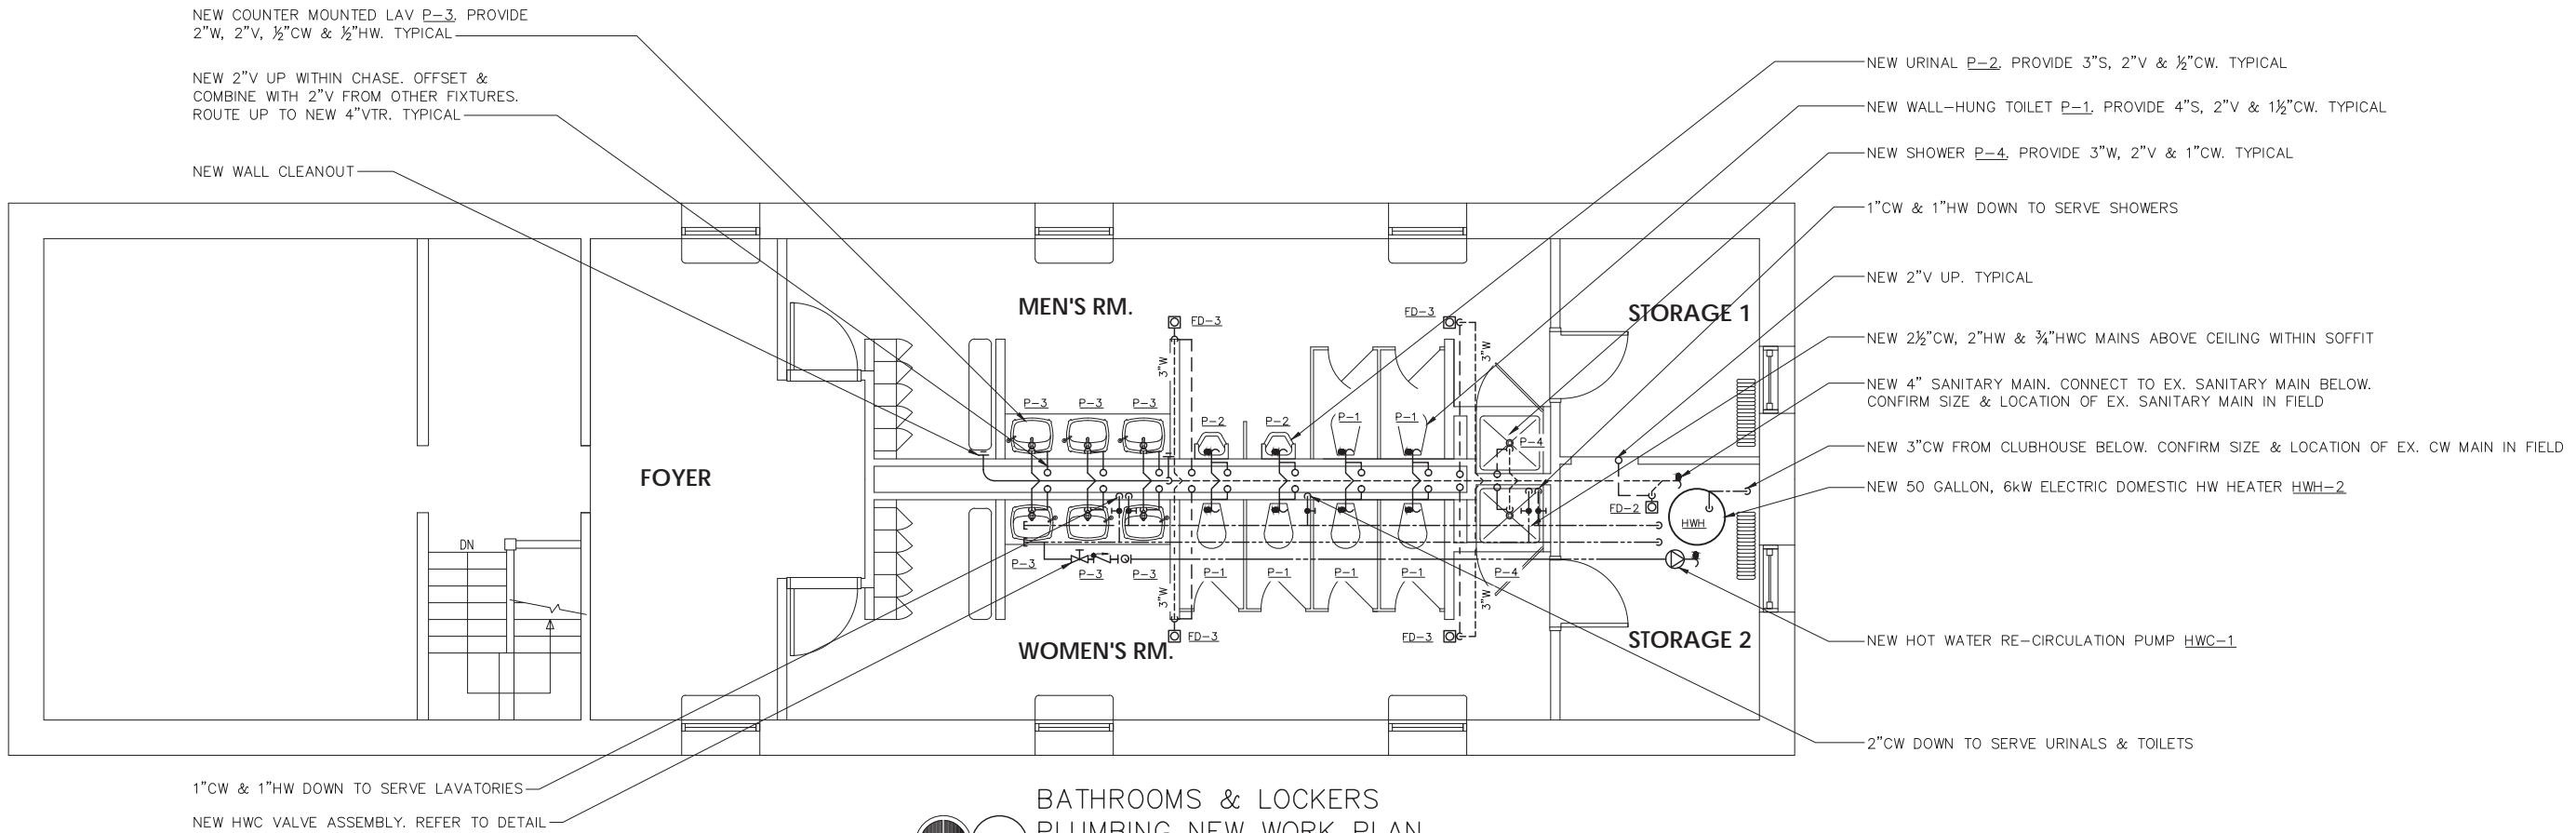
### BATHROOMS & LOCKERS PLUMBING NEW WORK PLAN

SCALE: 1/4" = 1'-0"

NOTES:

1. FLOOR DRAINS SHALL BE PROVIDED WITH A TRAP PRIMER.

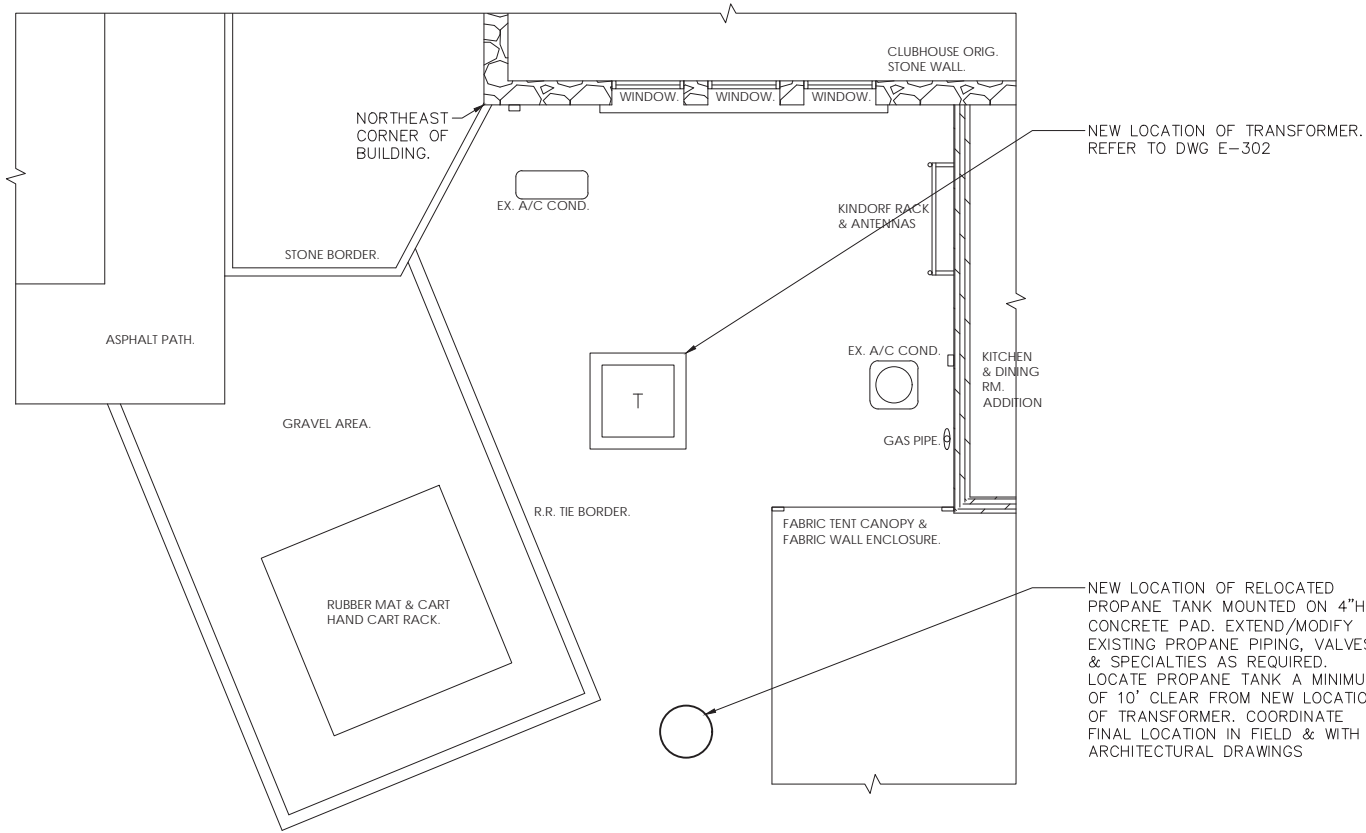

1

### PLUMBING SITE PROPANE TANK PART PLAN



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








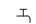

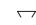




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

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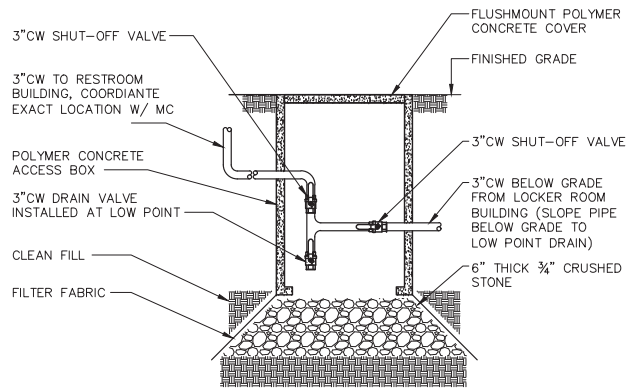
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WESTCHESTER COUNTY, NEW YORK DEPARTMENT OF PUBLIC WORKS DIVISION OF ENGINEERING		CONTRACT NUMBER 17 - 539	SHEET NUMBER P-202
NEW GOLF CART STORAGE FACILITY AND CLUBHOUSE UPGRADES MOHANSIC GOLF COURSE, YORKYOWN, NEW YORK BATHROOMS & LOCKERS PLUMBING NEW WORK PLAN		SCALE: 1/4" = 1'-0" DATE: 6/4/21 DPW FILE NO. 10-02-P-66-0	REV. NO. 0

PLUMBING FIXTURE SCHEDULE								
TAG	SYMBOLS		FIXTURES	PLUMBING CONNECTIONS				DESCRIPTION
	PLAN	ELEVATION		WASTE	VENT	COLD WATER	HOT WATER	
P-1			WATER CLOSET WALL HUNG	4"	2"	1¼"	—	TOILET; MAKE: AMERICAN STANDARD MODEL: 3351.101AF WALL MILLENIUM FLOWISE 1.28 GPF FLUSHOMETER TOILET SYSTEM 1.28 GPF WALL-MOUNT ELONGATED FLUSHOMETER VALVE TOILET, ADA COMPLIANT, 1½" INLET SPUD, FULLY GLAZED 2½" TRAPWAY.  AMERICAN STANDARD FLUSHOMETER SELECTRONIC FLOWISE MODEL 6065.122 1.28 GALLONS PER FLUSH, ELECTRONIC FLUSH VALVE, HARD-WIRED, FULLY MECHANICAL MANUAL OVERRIDE BUTTON, AUTOMATIC FLUSH AFTER 24 HOURS OF NON-USE, 3-SECOND FLUSH DELAY, 1" IPS SCREWDRIVER BAK-CHECK ANGLE STOP, VANDAL RESISTANT STOP CAP, ADJUSTABLE TAILPIECE, INTEGRAL VACUUM BREAKER AND 1½" SPUD COUPLING  PROVIDE WALL CARRIER SIMILAR TO WATTS ISCA-101-R & ISCA-131 FOR BACK TO BACK INSTALLATION & ROUTING OF WASTE HORIZONTAL WITHIN CHASE.
P-2			URINAL	2"	2"	1"	—	URINAL; MAKE: AMERICAN STANDARD MODEL: DECORUM FLOWISE 0.5 GPF HIGH EFFICIENCY URINAL 0.5 GPF VITREOUS CHINA URINAL, ADA COMPLIANT, ¾" INLET SPUD, OUTLET CONNECTION THREADED 2" INSIDE, PROVIDE WALL CARRIER.  AMERICAN STANDARD FLUSHOMETER SELECTRONIC FLOWISE MODEL 6062.002 0.125 GALLONS PER FLUSH, ELECTRONIC FLUSH VALVE, HARD-WIRED, FULLY MECHANICAL MANUAL OVERRIDE BUTTON, AUTOMATIC FLUSH AFTER 24 HOURS OF NON-USE, 3-SECOND FLUSH DELAY, 1" IPS SCREWDRIVER BAK-CHECK ANGLE STOP, VANDAL RESISTANT STOP CAP, ADJUSTABLE TAILPIECE, INTEGRAL VACUUM BREAKER AND 1½" SPUD COUPLING. SEE ARCHITECTS DRAWINGS FOR MOUNTING HEIGHTS.
P-3			COUNTERTOP LAVATORY	2"	2"	½"	½"	LAVATORY; MAKE: KOHLER MODEL: K-2189-1 LADENA 20⅞"x14⅜"x8⅞" DROP-IN MOUNT BATHROOM SINK, RECTANGULAR BASIN WITH CURVED BOTTOM, NO FAUCET HOLES; REQUIRES WALL OR COUNTER MOUNT FAUCET.  FAUCET; MAKE: AMERICAN STANDARD MODEL: 2064.195 SENSOR OPERATED PROXIMITY LAVATORY FAUCET, HARD-WIRED AC, 0.5 GPM PCA, VR MULTI-LAMINAR SPRAY. PROVIDE THERMOSTATIC MIXING VALVE 605XTMV10701.
P-4			SHOWER	2"	1-1/2"	1/2"	1/2"	SHOWER; MAKE: AMERICAN STANDARD MODEL: T675.507.002 COLONY SOFT COLLECTION COLONY SOFT FLOWISE SHOWER TRIM KIT. POLISHED CHROME FINISH, METAL LEVER HANDLES, 1.5 GPM MAX FLOW. SHOWER PAN; MAKE: ZORO MODEL: G 2245680, 36"x36" TERRAZZO SHOWER PAN FOR TILED WALL APPLICATION.
NFHB			HOSE BIB	—	—	—	—	IN UNFINISHED SPACES, WASHDOWN FAUCET SHALL BE POLISHED CHROME-PLATED WALL FAUCET WITH ½" MALE INLET AND ¾" HOSE THREAD OUTLET: CHICAGO #5 WITH #E27 VACUUM BREAKER OR ACCEPTABLE EQUIVALENT.
FD-1			FLOOR DRAIN	3"	2"	—	—	FOR TRAFFIC AREA OF GOLF CART STORAGE & MAINT. GARAGE: WADE #W-1210-27 WITH CAST IRON BODY, CAST IRON DRAINAGE FLANGE, SEDIMENT BUCKET, FLASHING COLLAR, 12" ROUND HEAVY DUTY CAST IRON GRATE. PROVIDE PROSET TRAP GUARD.
FD-2			FLOOR DRAIN	3"	2"	—	—	FOR MECHANICAL AREA: WADE #W-1100-STD5-1-27 WITH 5" ROUND ADJUSTABLE NICKEL-BRASS STRAINER, CAST IRON BODY, CAST IRON DRAINAGE FLANGE, FLASHING CLAMP, AND SEDIMENT BUCKET. PROVIDE PROSET TRAP GUARD.
FD-3			FLOOR DRAIN	3"	2"	—	—	FOR BATHROOMS: WADE #W-1100-STD5-1-27 WITH 5" ROUND ADJUSTABLE NICKEL-BRASS STAINER, CAST IRON BODY, CAST IRON DRAINAGE FLANGE, FLASHING CLAMP, AND SEDIMENT BUCKET.
NOTES: 1.) REFER TO ARCHITECTURAL DRAWINGS FOR FIXTURE, QUANTITY, LOCATIONS, & MOUNTING HEIGHTS.								

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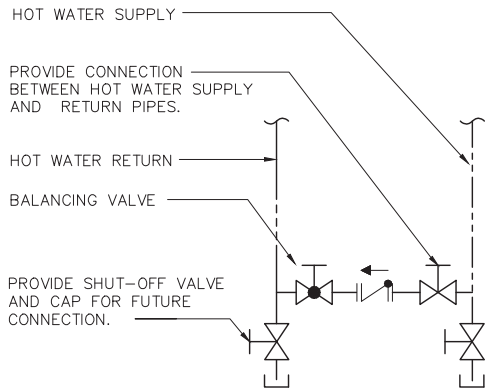
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WESTCHESTER COUNTY, NEW YORK DEPARTMENT OF PUBLIC WORKS DIVISION OF ENGINEERING		CONTRACT NUMBER 17 - 539	SHEET NUMBER P-601	
NEW GOLF CART STORAGE FACILITY AND CLUBHOUSE UPGRADES MOHANSIC GOLF COURSE, YORKYOWN, NEW YORK PLUMBING SCHEDULES		SCALE: NONE DATE: 6/4/21 DPW FILE NO. 10-02-P-67-0	REV. NO. 0	




NOTE: ACCESS BOX TO BE SIMILAR TO PENTEK ULTRA SERIES POLYMER CONCRETE FLUSH-MOUNT PULL BOX. ACCESS BOX TO BE PROVIDED WITH SKID RESISTANT COVER AND HEX HEAD BOLTED COVER. BOX TO BE 13" WIDE, 24" LONG AND 24" DEEP.


8 DOMESTIC WATER SYSTEM DRAIN PIT DETAIL  
SCALE: NONE



6 HOT WATER CONNECTION DETAIL  
SCALE: NONE

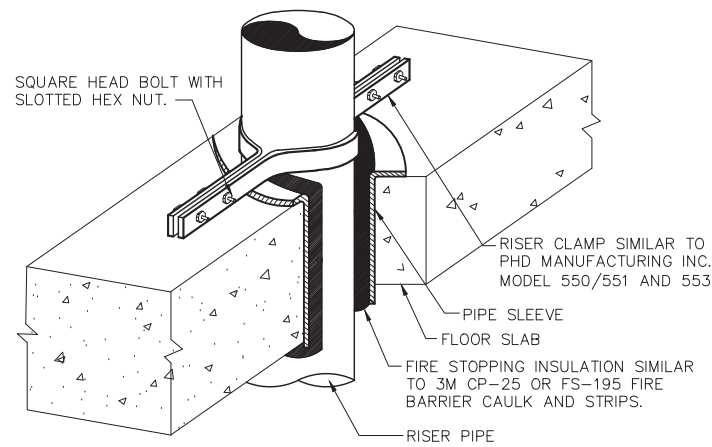


4 VERTICAL PIPE SUPPORT DETAIL  
SCALE: NONE

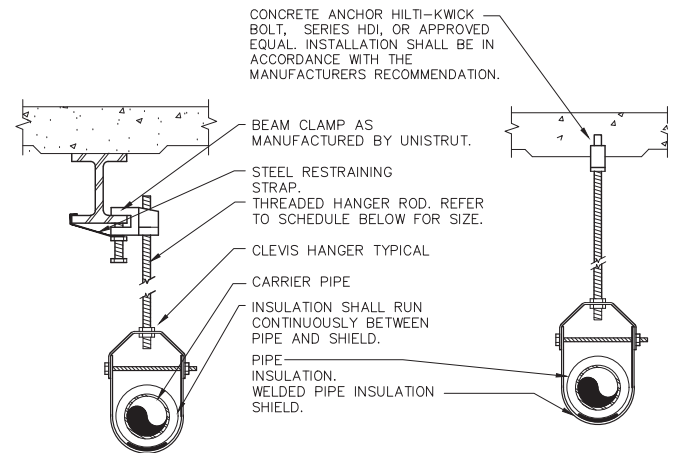


PIPE HANGER SCHEDULE					
PIPE DIA.	3/4"-2"	2 1/2"-3"	4"-5"	6"	8"-12"
HANGER DIA.	3/8"	1/2"	5/8"	3/4"	7/8"

- NOTES:
1. CLEVIS HANGERS WITH WELDED INSULATION SHIELDS SIMILAR TO RAUCH FIG. 100SH ON ALL PIPES LARGER THAN 1".
  2. FOR PIPES 1" OR SMALLER, A BAND HANGER WITH INSULATION SHIELD MAY BE USED SIMILAR TO RAUCH FIG. NO. 1ASH.
  3. FOR NONINSULATED PIPE, INSULATION SHIELDS MAY BE OMITTED.
  4. ALL PIPE HANGERS SHALL BE GALVANIZED STEEL OR FACTORY PAINTED BLACK WITH ENAMEL.
  5. FOR NON FERROUS PIPING WITHOUT INSULATION, ALL HANGERS SHALL COPPER PLATED OR FURNISHED WITH A DI-ELECTRIC BETWEEN PIPE AND HANGERS.


2 ABOVEGROUND PIPE HANGER DETAIL  
SCALE: NONE

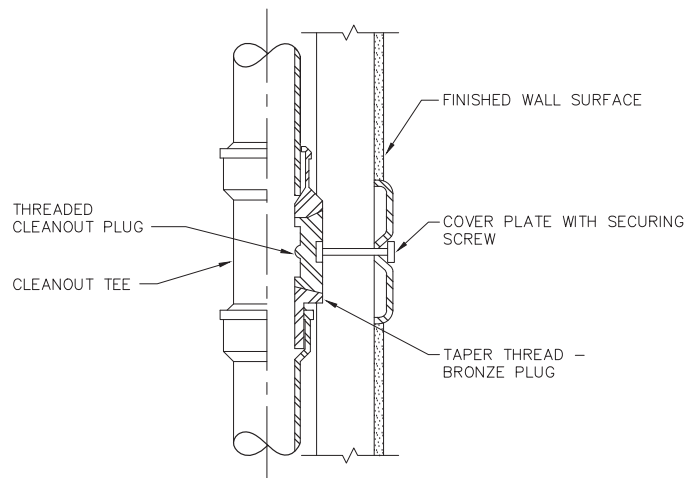

7 CLEANOUT FOR DRAINAGE PIPING  
CONCEALED BEHIND WALLS  
SCALE: NONE

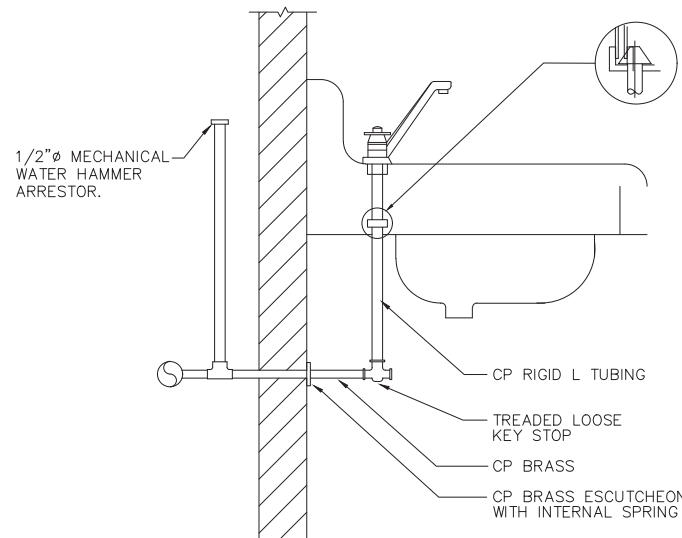

3 TYPICAL LAVATORY SUPPLY CONNECTION  
SCALE: NONE

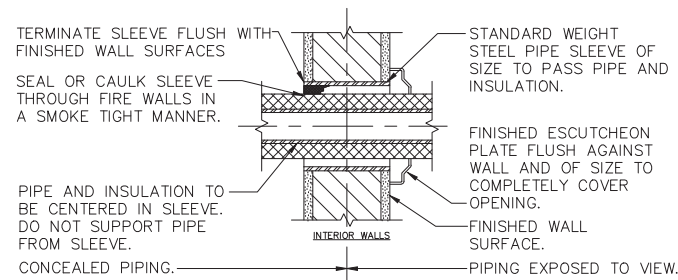

1 PIPE WALL SLEEVE DETAIL  
SCALE: NONE

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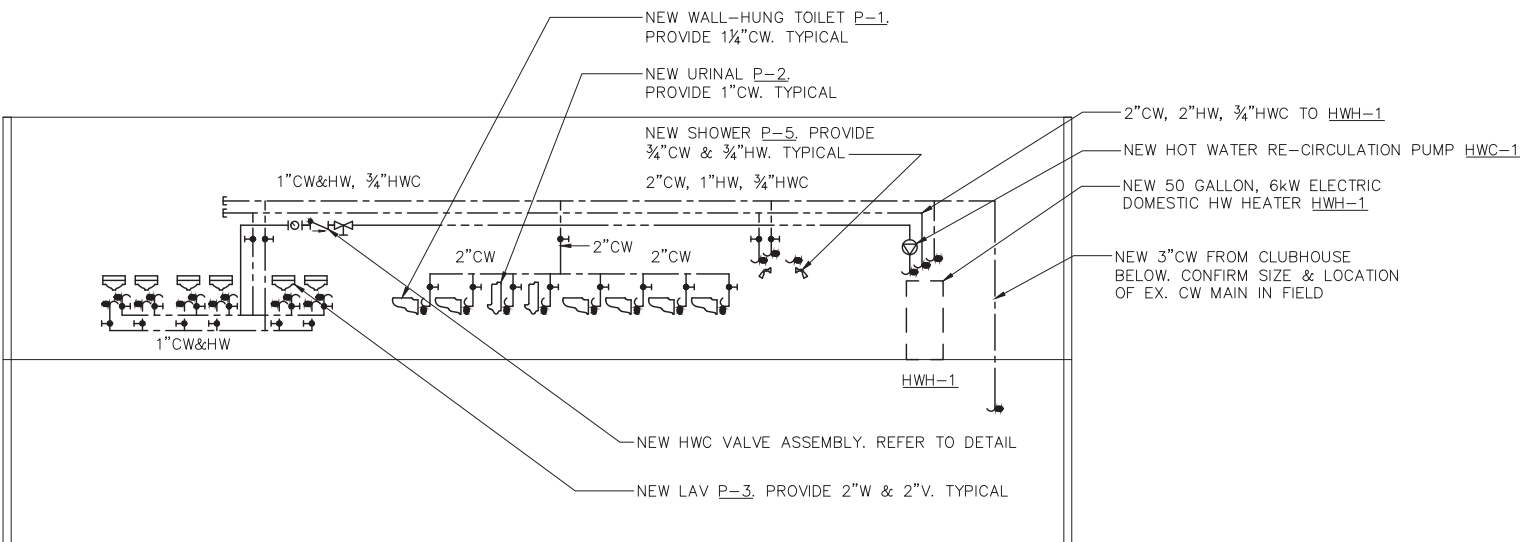
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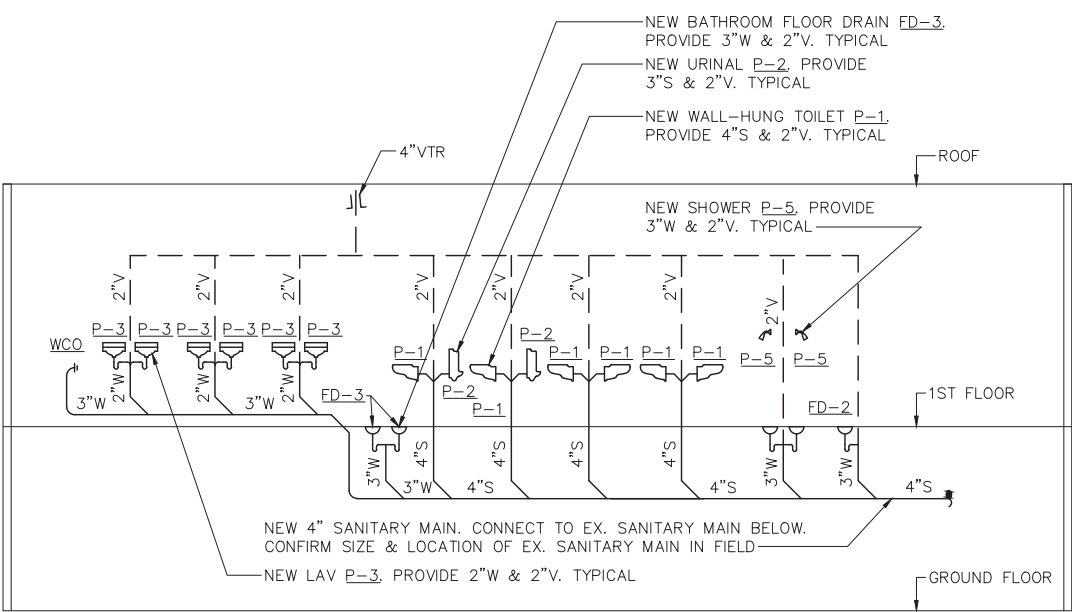
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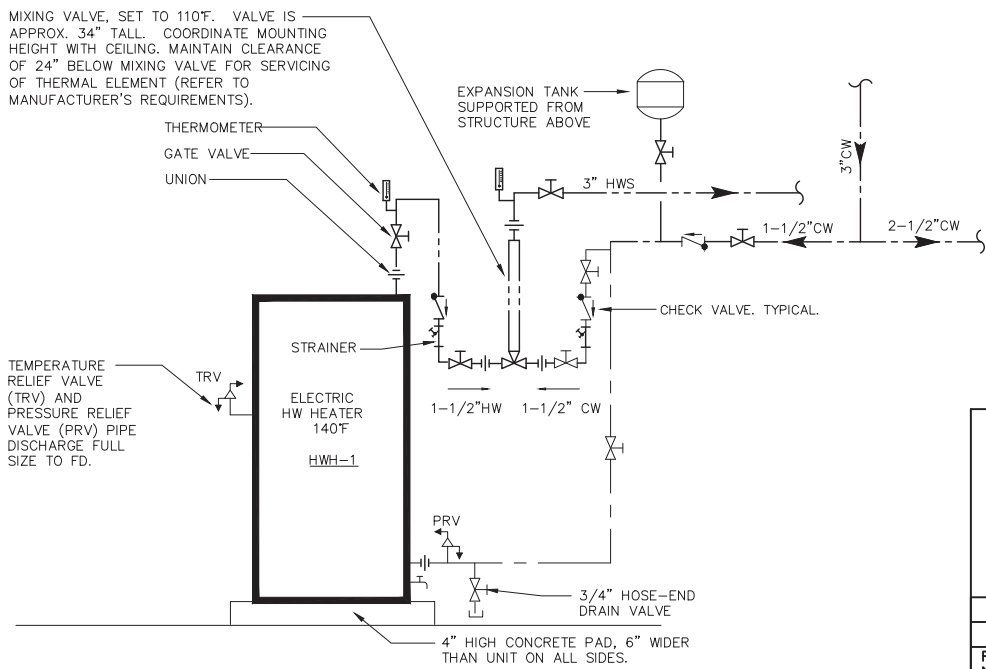
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WESTCHESTER COUNTY, NEW YORK DEPARTMENT OF PUBLIC WORKS DIVISION OF ENGINEERING				CONTRACT NUMBER 17 - 539 SHEET NUMBER P-701 SHEET NO. 35 OF 59
NEW GOLF CART STORAGE FACILITY AND CLUBHOUSE UPGRADES MOHANSIC GOLF COURSE, YORKYOWN, NEW YORK PLUMBING DETAILS 1 OF 2				SCALE: NONE DATE: 6/4/21 DPW FILE NO. 10-02-P-68-0 REV. NO. 0




2 CLUBHOUSE TOILET ROOMS PLUMBING DOMESTIC RISER DIAGRAM  
SCALE: NONE



1 CLUBHOUSE TOILET ROOMS PLUMBING SANITARY RISER DIAGRAM  
SCALE: NONE



3 ELECTRIC HWH SCHEMATIC - BATHROOMS & LOCKERS  
SCALE: NONE

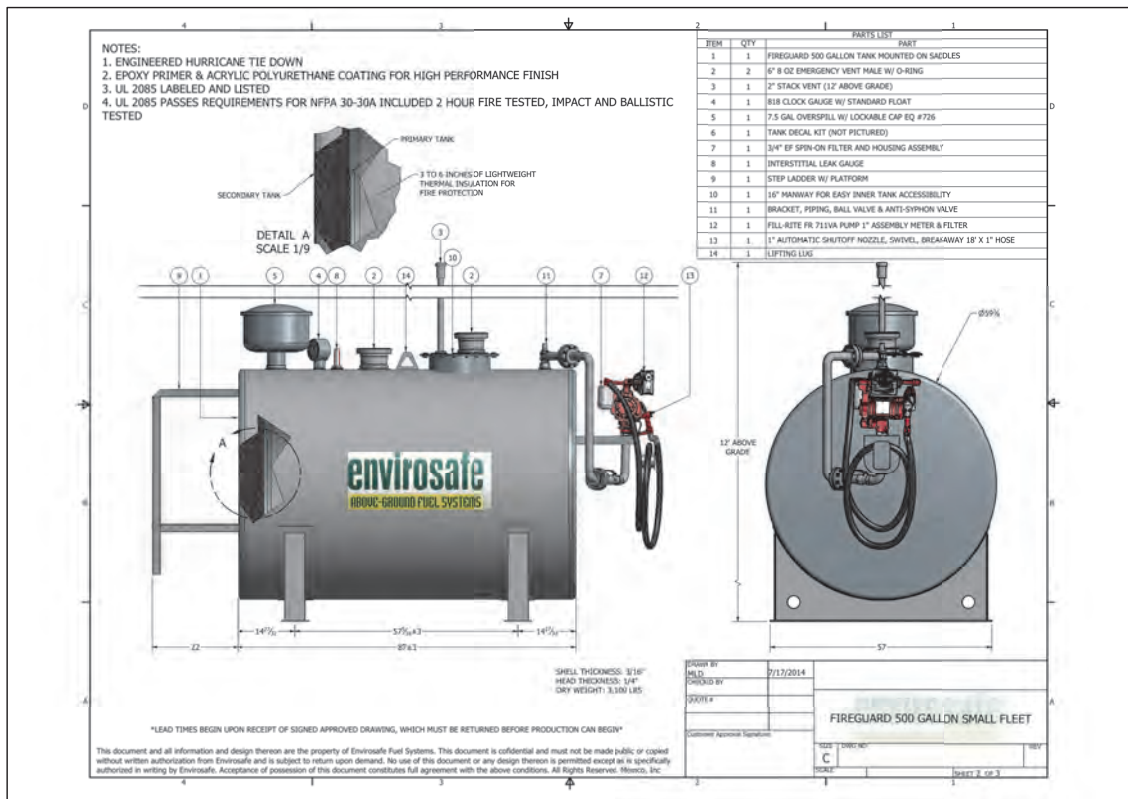

4 500 GALLON DIESEL/GASOLINE STORAGE TANK  
SCALE: NONE

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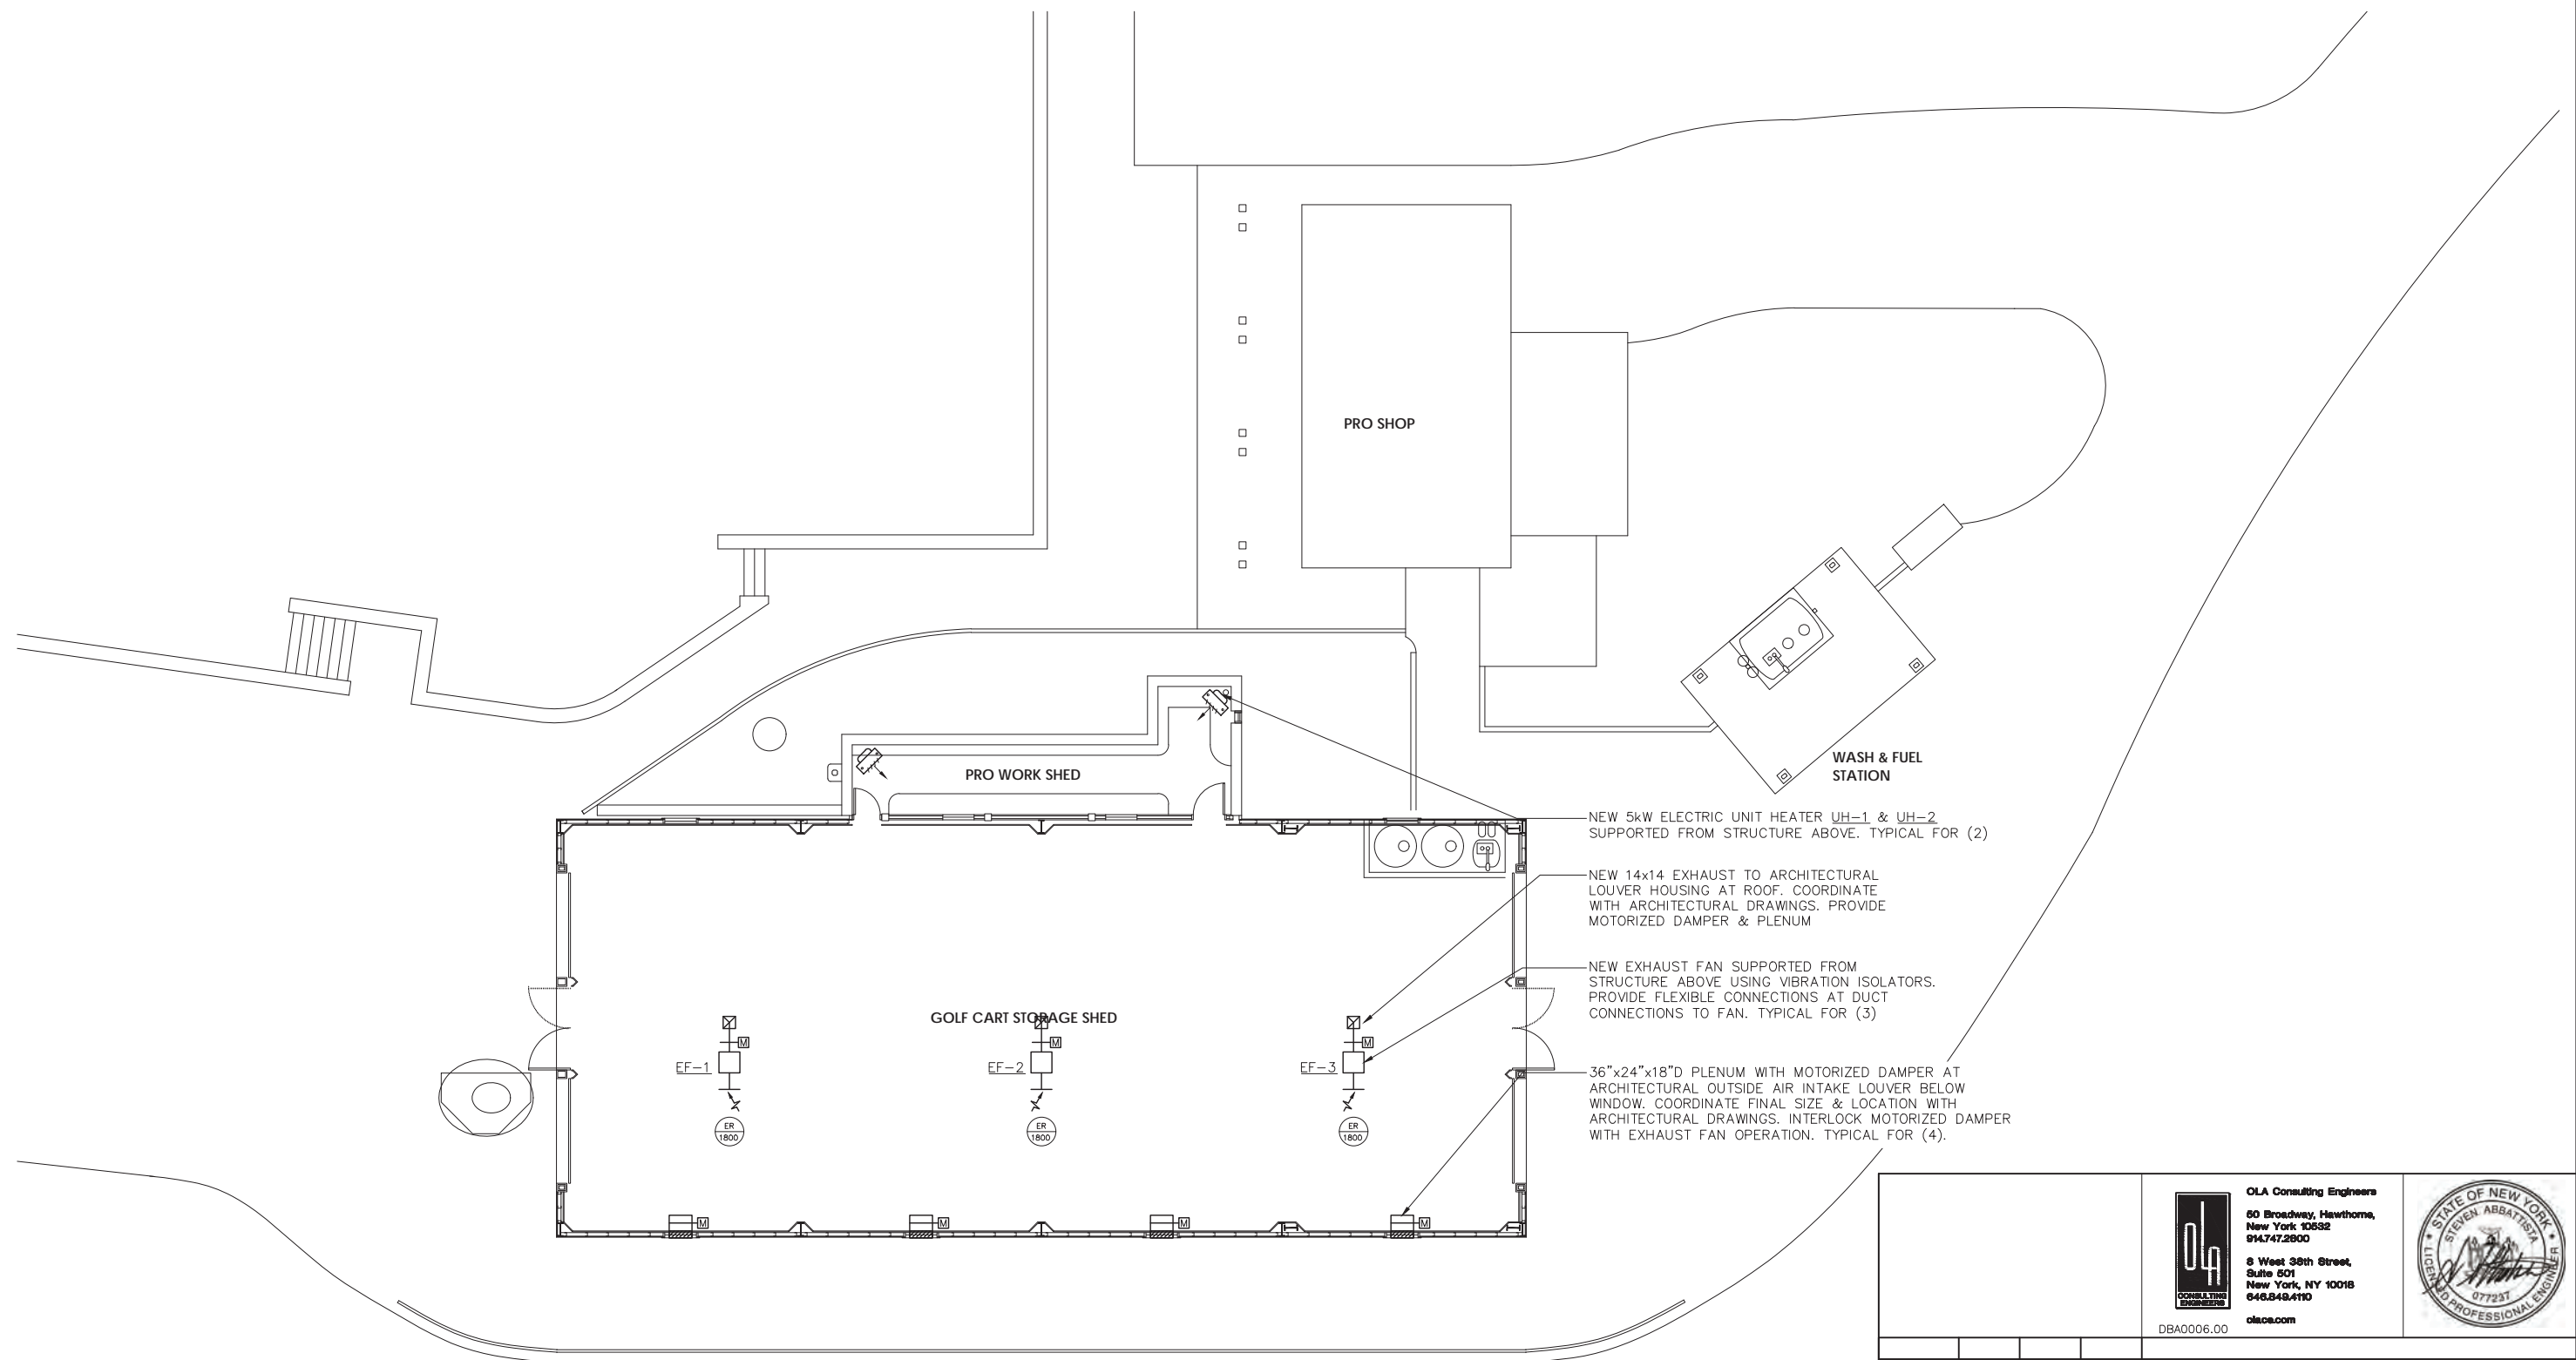
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WESTCHESTER COUNTY, NEW YORK DEPARTMENT OF PUBLIC WORKS DIVISION OF ENGINEERING		SCALE: NONE DATE: 6/4/21 DPW FILE NO. 10-02-P-69-0 REV. NO. 0

NEW GOLF CART STORAGE FACILITY  
AND CLUBHOUSE UPGRADES  
MOHANSIC GOLF COURSE, YORKYOWN, NEW YORK  
PLUMBING DETAILS 2 OF 2

SYMBOL & ABBREVIATIONS						SEQUENCE OF OPERATION			
SYMBOL	ABBREVIATION	DESCRIPTION				<p><b>HP UNITS (HP-1)</b></p> <p>PROVIDE A NEW TEMPERATURE CONTROL PANEL WITH 7-DAY PROGRAMMABLE THERMOSTAT WITH AUTO CHANGE-OVER, SET-BACK, HEAT-OFF-COOL AND ON-AUTO FAN SWITCH. HEATING AND COOLING SHALL BE ENABLED AND DISABLED THROUGH THIS THERMOSTAT.</p> <p>UNIT OFF: THE OUTSIDE AIR INTAKE AND EXHAUST AIR DAMPERS SHALL BE CLOSED, AND THE RETURN AIR DAMPER SHALL BE FULL OPEN.</p> <p>FAN OPERATION: THE UNIT SHALL START AND STOP AT PRE-SET TIMES AS PROGRAMMED THROUGH THE PROGRAMMABLE THERMOSTAT. UPON STARTUP, THE SUPPLY FAN START AND RAMP UP TO THE PROGRAMMED SPEED. THE OUTDOOR AIR DAMPER AND THE EXHAUST AIR DAMPERS SHALL OPEN AND THE RETURN AIR DAMPER SHALL CLOSE TO THE MINIMUM OUTDOOR AIR POSITION. UPON FAN SHUT DOWN THE OUTDOOR AIR DAMPER AND EXHAUST DAMPERS SHALL FULLY CLOSE AND THE RETURN AIR DAMPER SHALL FULLY OPEN.</p> <p>COOLING OPERATION: UNIT SUPPLY FAN SHALL RUN CONTINUOUSLY AND THE CONTROL CIRCUITS ENERGIZED DURING THE PROGRAMMED OCCUPIED PERIODS. THE OUTSIDE AIR INTAKE DAMPER SHALL BE OPEN AND SUPPLY AIR FAN ON. DX COOLING SHALL CYCLE TO MAINTAIN SPACE TEMPERATURE SET-POINT AT 75°F (ADJUSTABLE).</p> <p>HEATING OPERATION: UNIT SUPPLY FAN SHALL RUN CONTINUOUSLY DURING THE PROGRAMMED OCCUPIED PERIODS. THE OUTSIDE AIR INTAKE DAMPER SHALL BE OPEN AND SUPPLY AIR FAN ON. DX HEATING SHALL CYCLE TO MAINTAIN SPACE TEMPERATURE SET-POINT AT 68°F (ADJUSTABLE).</p> <p>MORNING WARM-UP OPERATION: UNIT SHALL START AND OPERATE FOR A PREDETERMINED PERIOD AS PROGRAMMED INTO THE UNITARY CONTROLS. DURING THIS CYCLE; OUTSIDE, INTAKE, AND EXHAUST AIR DAMPERS SHALL REMAIN CLOSED, AND RETURN AIR DAMPER SHALL REMAIN OPEN. THE COMPRESSOR SHALL ENERGIZE TO MAINTAIN DISCHARGE AIR TEMPERATURE SET POINT. WHEN THE ZONE TEMPERATURE COMES TO WITHIN 2°F (ADJUSTABLE) OF SET POINT, THE UNIT SHALL OPERATE IN OCCUPIED MODE.</p> <p>MORNING COOL-DOWN OPERATION: UNIT SHALL START AND OPERATE FOR A PREDETERMINED PERIOD AS PROGRAMMED INTO THE UNITARY CONTROLS. DURING THIS CYCLE; OUTSIDE, INTAKE, AND EXHAUST AIR DAMPERS SHALL REMAIN CLOSED, AND RETURN AIR DAMPER SHALL REMAIN OPEN. THE COMPRESSOR SHALL ENERGIZE TO MAINTAIN DISCHARGE AIR TEMPERATURE SET POINT. WHEN THE ZONE TEMPERATURE COMES WITHIN 2°F OF SET POINT, THE UNIT SHALL OPERATE IN OCCUPIED MODE.</p> <p>LIMIT CONTROLS: PROVIDE A HIGH/LOW LIMIT CONTROL(S) IN THE SUPPLY FAN DISCHARGE ARRANGED TO OVERRIDE TEMPERATURE CONTROLS AND PREVENT DISCHARGE TEMPERATURE FROM DROPPING BELOW 50°F AND RISING ABOVE 110°F (ADJUSTABLE). ALL DAMPERS SHALL GO TO THE UNIT OFF POSITION.</p> <p>MISCELLANEOUS: WHENEVER UNITS ARE SHUTDOWN, THE OUTSIDE AIR INTAKE AND EXHAUST AIR DAMPERS SHALL BE CLOSED AND THE RETURN AIR DAMPER SHALL BE OPEN. PROVIDE ALL WIRING AS REQUIRED.</p> <p><b>TOILET EXHAUST-FAN:</b> TOILET EXHAUST FAN SHALL BE INTERLOCKED WITH A TIME-CLOCK TO OPERATE DURING OCCUPIED PERIODS.</p> <p><b>EXHAUST-FAN:</b> EXHAUST FAN SHALL BE INTERLOCKED WITH A TIME-CLOCK TO OPERATE DURING OCCUPIED PERIODS AND/OR 24-7 BASED ON AREA SERVED.</p> <p><b>ELECTRIC UNIT HEATER:</b> PROVIDE 7-DAY PROGRAMMABLE THERMOSTAT WITH ON-AUTO-OFF SWITCH, LOCATED AS SHOWN ON PLAN AND COORDINATED WITH ARCHITECTURAL DRAWINGS. UNIT HEATER SHALL ENERGIZE TO MAINTAIN TEMPERATURE SET-POINT OF 55°F (ADJUSTABLE).</p>			
-	AC-	AIR CONDITIONING UNIT		CD	3-WAY				
-	AD	ACCESS DOOR		CD	4-WAY				
-	AFF	ABOVE FINISHED FLOOR		RR/RG/ER	RETURN REGISTER/GRILLE/EXHAUST REGISTER				
-	AHC	ABOVE HUNG CEILING		-	SUPPLY DUCT UP				
-	AP	ACCESS PANEL		-	SUPPLY DUCT DOWN				
-	BHP	BRAKE HORSEPOWER		-	RETURN DUCT UP				
-	BTU	BRITISH THERMAL UNIT		-	RETURN DUCT DOWN				
-	CFM	CUBIC FEET PER MINUTE		-	TRANSITION FROM SQUARE TO ROUND DUCT				
-	COD	CABLE OPERATED DAMPER		-	TRANSITION				
-	DB	DRY BULB TEMPERATURE		-	DUCT DROP				
-	DIA. OR Ø	DIAMETER		-	DUCT RISE				
-	DX	DIRECT EXPANSION		-	SQUARE VANED ELBOW				
-	EA	EXHAUST AIR		-	DUCT RISE				
-	EAT	ENTERING AIR TEMPERATURE		-	DUCT DROP				
-	ER	EXHAUST REGISTER		-	DUCT TRANSITION				
-	ESP	EXTERNAL STATIC PRESSURE		-	ALUMINUM DUCT				
-	EW	ENTERING WATER TEMPERATURE		AL	ACOUSTIC LINING				
-	FCU	FAN COIL UNIT		FD/AD	FIRE DAMPER W/ ACCESS DOOR				
-	FPM	FEET PER MINUTE		SD/AD	SMOKE DAMPER W/ ACCESS DOOR				
-	FPS	FEET PER SECOND		CFSD	COMBINATION FIRE/SMOKE DAMPER W/ ACCESS DOOR				
-	GPM	GALLONS PER MINUTE		VD	VOLUME DAMPER				
-	HP	HORSE POWER		AL	ACOUSTIC LINING				
-	LAT	LEAVING AIR TEMPERATURE		-	DUCT SIZE - 1ST FIGURE IS SIDE SHOWN				
-	LF	LINEAR FEET		FC	FLEXIBLE CONNECTION				
-	LWT	LEAVING WATER TEMPERATURE		-	ALUMINUM DUCT				
-	MBH	1000 BRITISH THERMAL UNITS PER HOUR		-	EXHAUST REGISTER				
-	MER	MECHANICAL EQUIPMENT ROOM		-	NEW CEILING DIFFUSER				
-	NIC	NOT IN CONTRACT	-	-	-				
-	OAI	OUTSIDE AIR INTAKE	-	-	-				
-	PSI	POUNDS PER SQUARE INCH	-	-	-				
-	RA	RETURN AIR	<b>GENERAL NOTES</b> <ol style="list-style-type: none"><li>DUCT DIMENSIONS SHOWN ON MECHANICAL DRAWINGS REFER TO INSIDE CLEAR DUCT DIMENSIONS. WHERE DUCTWORK IS LINED THE CONTRACTOR SHALL INCREASE THE SIZE OF DUCT TO COMPENSATE FOR LINING.</li><li>CONTRACTOR TO FIELD VERIFY ALL EXISTING CONDITIONS PRIOR TO THE BEGINNING OF WORK AND COORDINATE NEW WORK.</li><li>THE CONTRACTOR SHALL INSTALL FIRE DAMPERS WITH ACCESS DOORS IN ALL DUCTS PENETRATING FIRE RATED WALLS WHETHER SPECIFICALLY SHOWN ON THE DRAWING OR NOT.</li><li>PROVIDE ALL PIPE OPENINGS THROUGH PARTITIONS WITH PIPE SLEEVES. FOR PIPES PENETRATING FIRE RATED PARTITIONS, THE SPACE BETWEEN THE PIPE AND THE SLEEVE SHALL BE SEALED WITH FIRE STOPPING MATERIAL.</li><li>COORDINATE DUCTWORK, GRILLE, DIFFUSER AND REGISTER LOCATIONS WITH LIGHTS, ARCHITECTURAL ELEMENTS AND SHELVEING.</li><li>THIS CONTRACTOR SHALL SUBMIT FOR REVIEW A COMPOSITE SHOP DRAWING, FULLY COORDINATED WITH ALL OTHER TRADES, INDICATING DUCTWORK, PLUMBING PIPING, SMOKE DETECTORS, LIGHTS, CONDUITS, DIFFUSERS, GRILLES, ETC.</li><li>CONTRACT DRAWINGS AS FAR AS THEY RELATE TO THE GENERAL ARRANGEMENT AND LOCATION OF EQUIPMENT, PIPING AND SHEETMETAL, SHALL BE UNDERSTOOD AS DIAGRAMMATIC. ANY CHANGES TO SHEETMETAL AND EQUIPMENT LOCATIONS NECESSARY TO AVOID INTERFERENCE WITH OTHER TRADES SHALL BE MADE AT NO EXTRA COST.</li><li>PROVIDE CABLE OPERATED DAMPERS ON DUCTWORK ABOVE DRYWALL CEILINGS.</li><li>ALL RETURN DUCTWORK ENDING ABOVE HUNG CEILING TO HAVE ½"WMS.</li><li>SEE ARCHITECTURAL DRAWINGS FOR EXACT PHASING AND TIME SCHEDULE FOR CONSTRUCTION.</li></ol>						
-	RF-	RETURN FAN							
-	RPM	REVOLUTIONS PER MINUTE							
-	SA	SUPPLY AIR							
-	SP	STATIC PRESSURE							
-	TD	TRANSFER DUCT							
-	TF-	TRANSFER FAN							
-	TSP	TOTAL STATIC PRESSURE							
-	TYP.	TYPICAL							
-	U.O.N.	UNLESS OTHERWISE NOTED							
-	WB	WET BULB TEMPERATURE							
-	WG	INCHES OF WATER GAUGE							
-	EX.	EXISTING TO REMAIN							
-	REL.	REMOVE AND RELOCATE							
-	NEW	NEW WORK							
-	DEM.	EXISTING TO BE REMOVED							
	-	THERMOSTAT							
	-	AIR INTO REGISTER							
	-	POINT OF CONNECTION DISCONNECTION							
	SR	SUPPLY REGISTER							
	CD	1-WAY							
	CD	2-WAY							
	CD	2-WAY							
IN CHARGE OF <u>JW</u>			<div>IT IS A VIOLATION OF NYS LAW FOR ANY PERSON TO ALTER THIS DOCUMENT IN ANY WAY, UNLESS ACTING UNDER THE DIRECTION OF A LICENSED PROFESSIONAL ENGINEER. IF A DOCUMENT BEARING THE SEAL OF AN ENGINEER IS ALTERED, THE ALTERING ENGINEER SHALL AFFIX TO THE DOCUMENT THEIR SEAL AND THE NOTATION "ALTERED BY" FOLLOWED BY THEIR SIGNATURE AND THE DATE OF SUCH ALTERATION, AND A SPECIFIC DESCRIPTION OF THE ALTERATION.</div>						
CHECKED BY <u>RG</u>									
MADE BY <u>AMB</u>									

				<div>OLA Consulting Engineers 60 Broadway, Hawthorne, New York 10632 914.747.2800  8 West 38th Street, Suite 601 New York, NY 10018 646.849.4110 olaee.com</div>			
REVISION NUMBER	DATE	MADE BY	APP'D BY	REVISION			
RECORD DRAWING CERTIFICATION							
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CONTRACTOR				PROJECT COORDINATOR			
NAME		SIGNATURE		NAME		SIGNATURE	
TITLE		DATE		TITLE		DATE	
WESTCHESTER COUNTY, NEW YORK DEPARTMENT OF PUBLIC WORKS DIVISION OF ENGINEERING				CONTRACT NUMBER 17 - 539	SHEET NUMBER M-001		
NEW GOLF CART STORAGE FACILITY AND CLUBHOUSE UPGRADES MOHANSIC GOLF COURSE, YORKYOWN, NEW YORK MECH. SYMBOLS, ABBREVIATIONS, & NOTES				SCALE: NONE DATE: 6/4/21		REV. NO.: 0	



**CART STORAGE SHED  
MECHANICAL NEW WORK PLAN**

SCALE: 1/8" = 1'-0"

NOTES:


1. OUTDOOR INTAKE AIR SHALL BE PROVIDED THROUGH ARCHITECTURAL LOUVERS LOCATED BELOW WINDOWS ALONG THE EAST PERIMETER WALL. REFER TO ARCHITECTURAL DRAWINGS.

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NAME	SIGNATURE	NAME	SIGNATURE	DATE
TITLE	DATE	TITLE	DATE	DATE
WESTCHESTER COUNTY, NEW YORK DEPARTMENT OF PUBLIC WORKS DIVISION OF ENGINEERING				CONTRACT NUMBER 17 - 539 SHEET NO. 38 OF 59
NEW GOLF CART STORAGE FACILITY AND CLUBHOUSE UPGRADES MOHANSIC GOLF COURSE, YORKYOWN, NEW YORK CART STORAGE SHED MECHANICAL NEW WORK PLAN				SCALE: 1/8" = 1'-0" DATE: 6/4/21 DPW FILE NO. 10-02-M-71-0 REV. NO. 0





 1  
BATHROOMS & LOCKERS  
MECHANICAL NEW WORK PLAN  
SCALE: 1/4" = 1'-0"

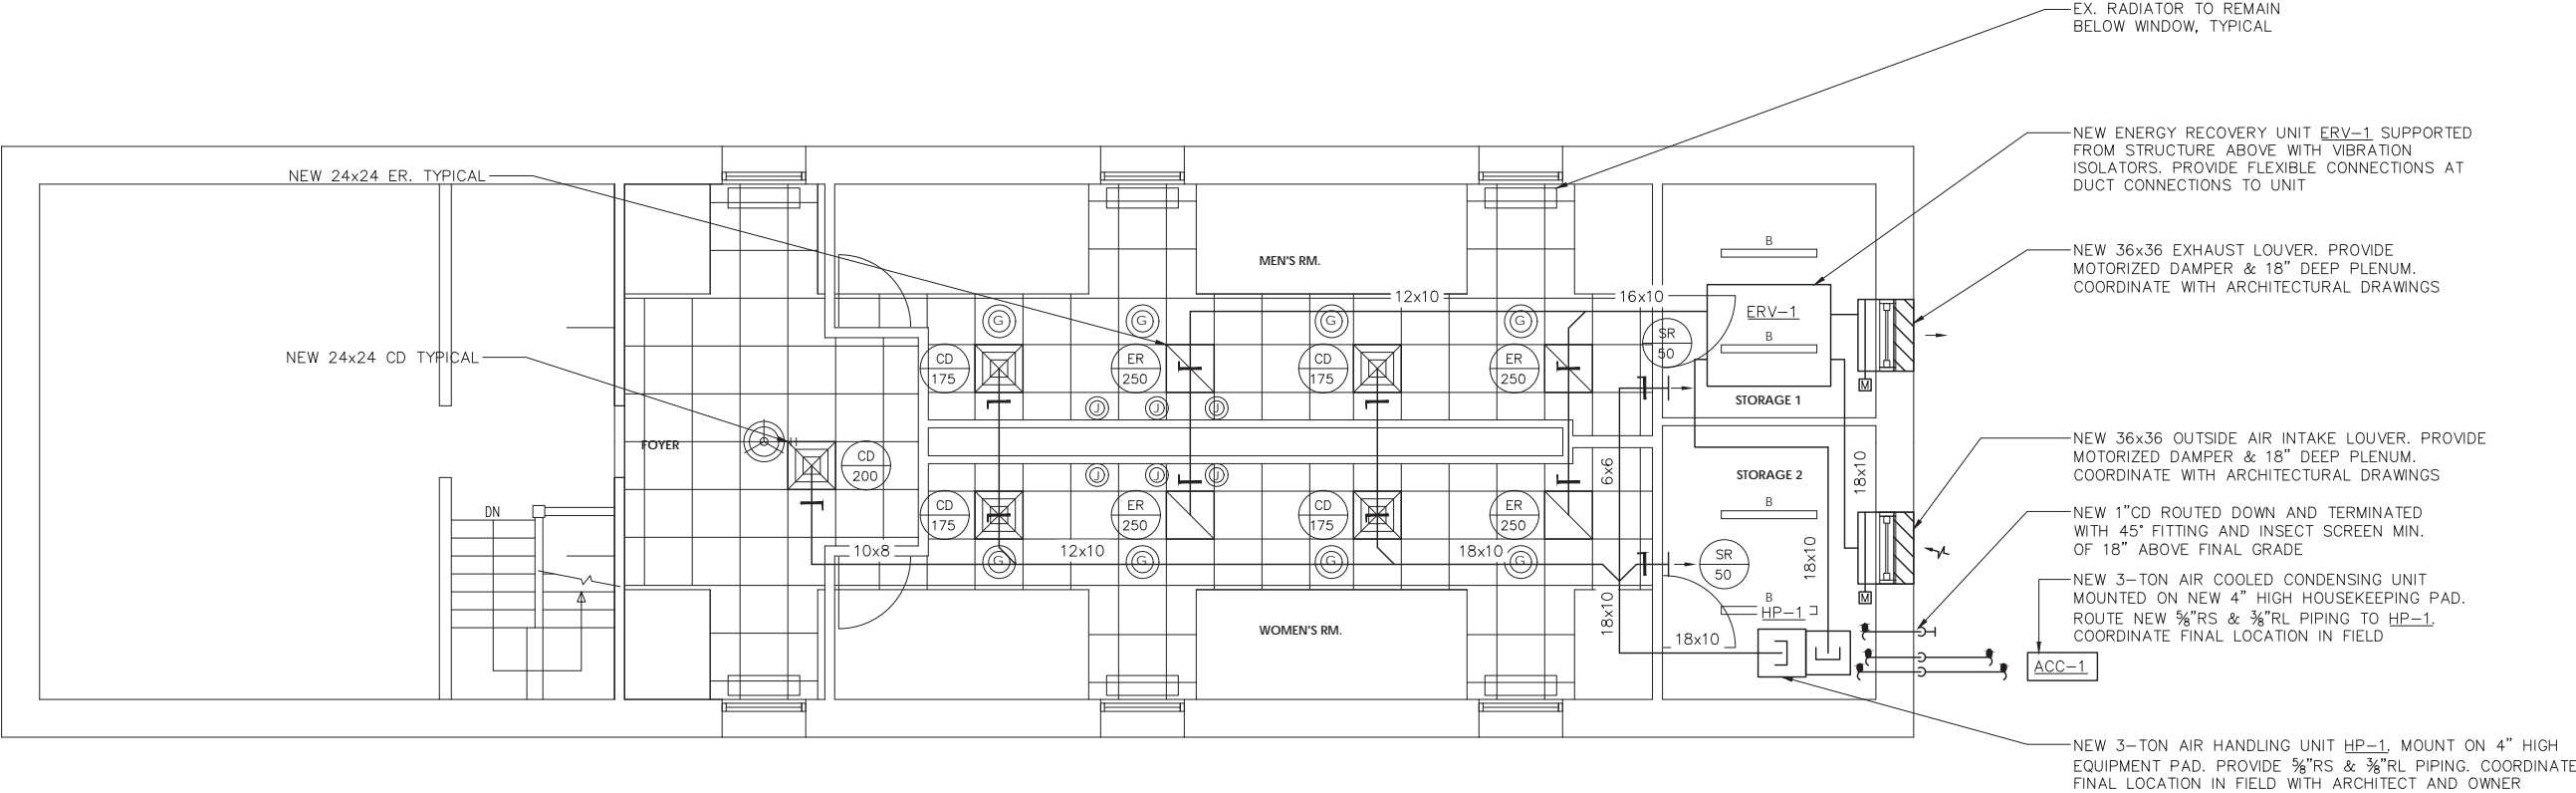- NOTES:  
1. SUPPLY AND RETURN DUCTWORK ABOVE TOILET ROOM SHALL BE RUN ABOVE CEILING. COORDINATE WITH ARCHITECTURAL DRAWINGS.

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CONTRACTOR		PROJECT COORDINATOR	
NAME SIGNATURE	NAME SIGNATURE	DATE	DATE
TITLE	TITLE	TITLE	TITLE
WESTCHESTER COUNTY, NEW YORK DEPARTMENT OF PUBLIC WORKS DIVISION OF ENGINEERING		CONTRACT NUMBER 17 - 539	SHEET NUMBER M-202
NEW GOLF CART STORAGE FACILITY AND CLUBHOUSE UPGRADES MOHANSIC GOLF COURSE, YORKYOWN, NEW YORK BATHROOMS & LOCKERS MECHANICAL NEW WORK PLAN		SCALE: 1/4" = 1'-0" DATE: 6/4/21 DPW FILE NO. 10-02-M-72-0	REV. NO. 0

EXHAUST FAN SCHEDULE

DESIGNATION	EF-1	EF-2	EF-3
LOCATION	GOLF CART STORAGE	GOLF CART STORAGE	GOLF CART STORAGE
AREA SERVED	GOLF CART STORAGE	GOLF CART STORAGE	GOLF CART STORAGE
MODEL	SQ-140 (VARI-GREEN)	SQ-140 (VARI-GREEN)	SQ-140 (VARI-GREEN)
CFM	1,800	1,800	1,800
BHP	0.3	0.3	0.3
HP	¾	¾	¾
FAN RPM	1140	1140	1140
SP (IN H <sub>2</sub> O)	0.375	0.375	0.375
VOLTS/ø/Hz	230/1/60	230/1/60	230/1/60
INTERLOCK	-	-	-

NOTES:  
1. FANS BASED ON GREENHECK.  
2. ALL MOTORS SHALL BE PREMIUM EFFICIENCY.  
3. FURNISH MOTOR STARTERS AND DISCONNECT SWITCHES FOR EACH FAN.  
4. FURNISH MOTOR AND BELT GUARD FOR ALL EXTERNAL MOTOR DRIVES.  
5. FURNISH RUBBER IN SHEAR OR SPRING VIBRATION ISOLATORS AS PER THE SPECIFICATION.  
6. FURNISH WALL MOUNTED SPEED CONTROLLER OR THERMOSTAT AS INDICATED ON PLAN.

ENERGY RECOVERY SCHEDULE

DESIGNATION	ERV-1
LOCATION	STORAGE
AREA SERVED	TOILET/LOCKER ROOM
MANUFACTURER	GREENHECK
MODEL	ERV-20-15L
WEIGHT	779
SUPPLY FAN:	
CFM	1,000
MIN OA CFM	1,000
HP	¾
ESP/TSP	0.75/0.845
EXHAUST FAN:	
CFM	1,000
HP	¾
ESP/TSP	0.75/0.849


ENERGY CONSERVATION WHEEL:(SUMMER OAT 95/75, WINTER OAT 0/0)	
SUMMER SAT DB/WB	78.3/66.2
SUMMER RAT DB/WB	75.0/63.9
SUMMER EAT DB/WB	91.5/73.2
WINTER SAT DB/WB	60.7/48.8
WINTER RAT DB/WB	55.8/35.0
WINTER EAT DB/WB	20.4/19.0
FILTERS DATA:	
QUANTITY/SIZE	8-20x20 (EXHAUST AIR) 8-20x20 (OUTDOOR AIR)
EFFICIENCY	MERV 8
ELECTRICAL DATA:	
VOLTS/ø/Hz	208 / 1 / 60
MCA	18.5
MAX FUSE SIZE	25.0
NOTES: 1. FURNISH THE FOLLOWING OPTIONS AND ACCESSORIES: •ROOM TEMPERATURE SENSOR. •PREMIUM EFFICIENCY MOTORS •ANGLE FILTER SECTIONS WITH MERV-8 FILTERS. •DIRTY FILTER SENSOR - OUTDOOR AND EXHAUST AIR. •OUTDOOR AIRFLOW MONITORING. •ROTATION SENSOR. •DUCT FLANGE. •MICROPROCESSOR CONTROLS. •SPRING VIBRATION ISOLATORS. •MOTORIZED SUPPLY AND RETURN LOW LEAKAGE DAMPERS. •FROST CONTROL - MODULATING WHEEL. 3. FURNISH EXTRA DRIVE BELT AND EXTRA FILTER SET. 4. PROVIDE UNIT MOUNTED DISCONNECT SWITCH. 5. UNIT SHALL BE UL LISTED.	

EQUIPMENT NOTES:

- 1.) LOUVERS: SHALL BE RUSKIN MODEL ELF375DX DRAINABLE BLADE, 37.5’ BRUSHED ALUMINUM 6063-T5, ANODIZED CUSTOM COLOR TO BE SUBMITTED FOR APPROVAL. FURNISH 1/2” GALVANIZED STEEL BIRD SCREEN. COORDINATE WITH ARCHITECTURAL PLANS.
- 2.) MOTORIZED DAMPER: SHALL BE RUSKIN MODEL CD40. 4” DEEP EXTRUDED ALUMINUM AIRFOIL DAMPER. DAMPER SHALL HAVE OPPOSED BLADES, MOTOR, AND LINKAGE. DAMPER SHALL BE 120V, 3 AMP MAX. DAMPER SHALL BE LOW-LEAKAGE RATED TYPE.  
2.1) OUTSIDE AIR INTAKE & EXHAUST DAMPERS SHALL BE CLASS I MOTORIZED DAMPERS WITH MAXIMUM LEAKAGE RATE OF 4 CFM/FT² @ 1.0” W.G.; TESTED IN ACCORDANCE WITH AMCA 500D. DAMPERS SHALL BE CONFIGURED TO CLOSE AUTOMATICALLY WHEN THE SYSTEMS OF SPACE SERVED ARE NOT IN USE.
- 3.) CEILING DIFFUSERS: SHALL BE TITUS MODEL TDC WITH OPPOSED BLADE VOLUME DAMPER. ALL STEEL CONSTRUCTION. FINISH SHALL BE BAKED ON ENAMEL, COLOR SHALL BE WHITE. FRAME SHALL BE SUITABLE FOR LAY IN OR SURFACE MOUNTING. NECK SHALL BE ROUND. REFER TO PLANS FOR MODULE SIZE, NECK SIZE, AND CFM. COORDINATE WITH ARCH PLANS.
- 4.) SUPPLY AIR REGISTERS: SHALL BE TITUS MODEL 300FL, 1/2” SPACING, DOUBLE DEFLECTION, ALL ALUMINUM CONSTRUCTION, AIRFOIL BLADES WITH OPPOSED BLADE VOLUME DAMPER, SIZE AND CFM AS NOTED ON PLANS. FINISH SHALL BE BAKED ON ENAMEL, COLOR SHALL BE WHITE. FRAME SHALL BE SUITABLE FOR SURFACE MOUNT OR LAY IN. COORDINATE WITH ARCH PLANS.
- 5.) RETURN & EXHAUST AIR REGISTERS: SHALL BE TITUS MODEL 355FL, 1/2” SPACING, 35’ FIXED DEFLECTION, ALL ALUMINUM CONSTRUCTION, AIRFOIL BLADES WITH OPPOSED BLADE VOLUME DAMPERS, SIZE AND CFM AS NOTED ON PLANS. FINISH SHALL BE BAKED ON ENAMEL, COLOR SHALL BE WHITE. FRAME SHALL BE SUITABLE FOR SURFACE MOUNT OR LAY IN. COORDINATE WITH ARCH PLANS.
- 8.) HEAVY DUTY SIDEWALL RETURN AIR REGISTERS – FOR USE IN CART STORAGE SHED: SHALL BE TITUS MODEL J3RL, STEEL CONSTRUCTION, WITH 1/2” SPACING, 38’ FIXED DEFLECTION, 16-GAUGE BORDER, 14-GAUGE BLADES, SUPPORT BARS 6” ON CENTER, OPPOSED BLADE VOLUME DAMPER IN NECK, SIZE AND CFM AS NOTED ON PLANS. FINISH SHALL BE BAKED ON ENAMEL. SUBMIT COLOR CHART FOR APPROVAL. FRAME SHALL BE SUITABLE FOR SURFACE MOUNTING. COORDINATE WITH ARCH PLANS.
- 9.) THERMOSTAT GUARDS: PROVIDE LOCKING TAMPER PROOF COVER FOR ALL THERMOSTATS AND CO2 SENSORS. COVER SHALL BE CLEAR ACRYLIC PLASTIC WITH TUMBLER TYPE KEY LOCK. SIMILAR TO HONEYWELL CG-512A.
- 10.) REFRIGERANT PIPE INSULATION: SHALL BE AP ARMAFLEX PIPE INSULATION. 1” THICK UNSLIT, TO BE INSTALLED BEFORE FINAL CONNECTION. FIELD FABRICATE FITTING INSULATION WITH MITER-CUTS. ALL BUTT JOINTS AND SEAMS ARE TO BE SEALED WITH ARMSTRONG 520 ADHESIVE. ALL INSULATION INSTALLED OUTDOORS SHALL BE COATED WITH ARMSTRONG ARMAFLEX FINISH, AS PER THE MANUFACTURERS RECOMMENDATIONS.
- 11.) VERTICAL INDOOR HEAT PUMP (HP-1): SHALL BE 3-TON VERTICAL DUCTED DAIKIN MODEL FTQ36PBVJU RATED AT 36,000 BTUH COOLING / 40,000 BTUH/HEATING; 1,200 CFM @ 0.8” ESP; ⅝”RL & ⅝”HG, R-410A REFRIGERANT. MICROPROCESSOR THERMOSTAT FOR COOLING AND HEATING. ELECTRICAL: 208-230/1/60, 2.8 MCA, 15 MOCP.  
  
OUTDOOR UNIT ACC-1 SHALL BE 3-TON DAIKIN MODEL RZQ36PVJU9 OUTDOOR COMPRESSOR RATED AT 36,000 BTUH COOLING / 40,000 BTUH HEATING; ELECTRICAL: 208-230/1/60, 27 MCA, 30 MOCP.
- 12.) ELECTRIC UNIT HEATER (UH-1 & UH-2): SHALL BE MARKEL MODEL F1FUH05003, RATED AT 400 CFM, 17.1 MBH, 5 kW, 208V/1ø/60Hz, 24 AMPS. PROVIDE THE FOLLOWING OPTIONS: FAN GUARD, AIR DEFLECTION LOUVER, SUMMER FAN SWITCH, HEAT PURGE FAN DELAY SWITCH, DISCONNECT SWITCH, & WALL THERMOSTAT.
- 13.) VIBRATION ISOLATORS: ALL INDOOR AND OUTDOOR HVAC EQUIPMENT SHALL BE MOUNTED ON SPRING VIBRATION ISOLATORS, WITH A RATED STATIC DEFLECTION OF AT LEAST 1”. USE MASON TYPE "SLF" OR "SLFH" FOR FLOOR MOUNTED EQUIPMENT, RATED FOR MACHINE LOAD. USE MASON TYPE "30" OR "W30" FOR EQUIPMENT SUSPENDED FROM CEILING. ASSUMING THE EQUIPMENT IS MOUNTED TO PROVIDE FOR EQUAL LOAD DISTRIBUTION, EACH SPRING SHALL BE RATED FOR 1/4 THE UNIT'S TOTAL WEIGHT. SYSTEMS MUST BE ENGINEERED FOR 95% ISOLATION EFFICIENCY AT THE LOWEST ROTATIONAL SPEED OF THE UNIT.

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CLINCH LOCK CONNECTION CORNER FILLER OR GASKET  $L = 1/4 W$ , 4" MINIMUM

ACOUSTIC LINING TYPICAL

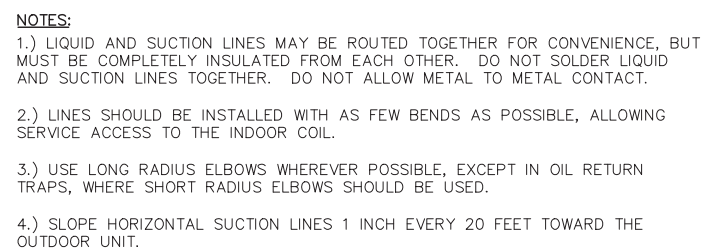45 DEGREE ENTRY

CLINCH LOCK

TYPICAL FOR LINED OR UNLINED DUCT CONNECTIONS USE BULL NOSE ON ALL EXPOSED LINING EDGES.

CLOSE ALL OPENINGS AT CORNERS WITH FILLER PIECE OR GASKET.

CUT OPENING SIZE, AND SHAPE ACCURATELY

CONICAL DOVETAIL JOINT

BELL MOUTH

SPIN IN

PROFILE VARIES

NOTCH

POWER ACTUATED STUD INTO CONCRETE DECK WITH WASHER AND NUT

BAR JOIST AND OR 1" BEAM

POWER ACTUATED OR WELDED STUD TO STEEL WITH WASHER AND NUT.

STRAP HANGER. REFER TO SCHEDULE BELOW FOR SIZE.

SHEET METAL SCREWS TYPICAL.

EXPANSION SHIELD WITH BOLT

EXPANSION NAIL WITH WASHER.

CONCRETE SLAB

DUCT

DUCT

NOTES:

1. FOR DUCTS OVER 49" WIDE, THE STRAP HANGER SHALL BE TURNED UNDER THE BOTTOM OF THE DUCT.
2. ALL ANCHORS AND INSERTS SHALL HAVE NEW YORK CITY BOARD OF STANDARD AND APPEALS, (BSA) APPROVAL.

HANGER STRAP SCHEDULE		
DUCT SIZE	HANGER SIZE	MAXIMUM SPACING
UP TO 2 SQ.FT.	1" X 1/16"	8'-0"
2 SQ.FT. TO 4 SQ.FT.	1" X 1/8"	8'-0"
4 SQ.FT. TO 10 SQ.FT.	1" X 1/8"	6'-0"
OVER 10 SQ.FT.	1" X 1/8"	4'-0"

4 HANGER RODS  
SECURED TO  
BUILDING STRUCTURE,  
3/8" DIA. MIN.

FOR FANS WITH  
EXTERNAL MOTOR  
PROVIDE MOTOR AND  
BELT GUARD.

EXHAUST OR INTAKE  
FAN.

FOR DUCTS WITH  
ACOUSTIC LINING,  
DIMENSIONS SHOWN ON  
PLANS ARE INSIDE  
CLEAR DIMENSIONS.

DOUBLE NUT ON  
HANGER RODS

FLEXIBLE CONNECTION  
6" MIN.

RUBBER-IN-SHEAR OR  
SPRING TYPE VIBRATION  
ISOLATORS, AS PER THE  
SPECIFICATION, TYPICAL

Diagram illustrating a branch duct arrangement for surface mounted air outlets. The diagram shows a main duct transitioning to a round sheet metal duct, supported by hangers. The duct is connected to a ceiling diffuser with an opposed blade volume damper. The arrangement is similar for plenum slot diffusers.

Labels and Callouts:

- MAIN OR BRANCH DUCT
- TRANSITION TO ROUND SHEET METAL DUCT
- SUPPORT ALL SHEET METAL DUCTWORK FROM BUILDING STRUCTURAL MEMBERS ONLY.
- THE MAXIMUM HANGER SPACING SHALL BE 10'-0"
- FASTEN DUCTS WITH CLAMPS.
- CEILING "T" BAR, TYPICAL
- CEILING DIFFUSER WITH OPPOSED BLADE VOLUME DAMPER
- ACOUSTIC TILE SUSPENDED CEILING SHOWN. BRANCH DUCT CONNECTION IS SIMILAR FOR A SURFACE MOUNTED AIR OUTLETS.
- AIR FLOW
- BELL MOUTH CONNECTION TO MAIN OR BRANCH DUCT MAY ALSO BE USED.
- VOLUME DAMPER
- CEILING SUPPORTS. DO NOT SUPPORT DUCTWORK FROM CEILING SUPPORTS.



**NOTE:** THIS BRANCH DUCT ARRANGEMENT IS SIMILAR FOR PLENUM SLOT DIFFUSERS.

The diagrams illustrate various duct fittings and transitions:

- Top Left:** A vertical duct with a horizontal branch. Labels include "MAIN DUCT", "AIR FLOW", "VD" (vertical distance), "W" (width), "W/4 OR A MINIMUM OF 5\"", and "45°".
- Top Right:** A horizontal duct with a vertical branch. Labels include "SQUARE VANED ELBOW 5' OR LESS", "CEILING OR TOP REGISTER OR TOP", "W", and "RADIUS ELBOW OVER 5'".
- Bottom Left:** A horizontal duct with a vertical branch. Labels include "W3", "W2", "VD", and "W3".
- Bottom Center:** A horizontal duct with a vertical branch. Labels include "NOTE: SPLIT WITH ONE 90° BRANCH IS SIMILAR TO A DOUBLE ELBOW SPLIT.", "W2", "VD", and "W3".
- Bottom Right:** A horizontal duct with a vertical branch. Labels include "VD", "NECK SIZE AS SHOWN ON PLAN", and "RADIUS ELBOW".
- Bottom Left (Small):** A horizontal duct with a vertical branch. Labels include "NECK SIZE AS SHOWN ON PLAN", "VD", and "TAP OR NECK".
- Bottom Center (Small):** A horizontal duct with a vertical branch. Labels include "VD", "NECK SIZE AS SHOWN ON PLAN", and "SPLIT".
- Bottom Right (Small):** A horizontal duct with a vertical branch. Labels include "D", "DUCT DROP IN DIRECTION OF AIR FLOW", "R", and "DUCT RISE IN DIRECTION OF AIR FLOW".


NOTES:

- 1.) SINGLE LINE REPRESENTATIONS REFER TO DOUBLE LINE DETAILS.
- 2.) USE RADIUS OR SQUARE VANED BENDS FOR BOTH ELBOWS AND SPLITS AS DETERMINED BY SPACE LIMITATIONS, AND THE DISTANCE FROM AIR OUTLETS.
- 3.) ALL SQUARE ELBOWS SHALL HAVE FACTORY TURNING VANES, AND MAINTAIN A CONSTANT WIDTH.
- 4.) WHERE DUCTS SPLIT, THE SOLID LINE REPRESENTATION IS PREFERRED, UNLESS PRECLUDED BY SPACE, OR OTHERWISE INDICATED.
- 5.) USE ELBOW SPLIT FOR BRANCH CONNECTIONS ONLY WHERE NECK SIZE IS GIVEN.

				 <p><b>OLA Consulting Engineers</b> 80 Broadway, Hawthorne, New York 10532 914747-2800  8 West 39th Street, Suite 601 New York, NY 10018 646.849.4110  olaee.com</p>			
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CONTRACTOR				PROJECT COORDINATOR			
NAME _____ SIGNATURE _____				NAME _____ SIGNATURE _____			
TITLE _____ DATE _____				TITLE _____ DATE _____			
WESTCHESTER COUNTY, NEW YORK DEPARTMENT OF PUBLIC WORKS DIVISION OF ENGINEERING						CONTRACT NUMBER 17 - 539	
						SHEET NUMBER M-701	
NEW GOLF CART STORAGE FACILITY AND CLUBHOUSE UPGRADES MOHANSIC GOLF COURSE, YORCKOWN, NEW YORK MECHANICAL DETAILS 1 OF 2						SHEET NO. 41 OF 59	
						SCALE: NONE DATE: 6/4/21  DPW FILE NO.  10-02-M-74-0	
						REV. NO.: 0	



IN CHARGE OF JW  
CHECKED BY RG  
MADE BY AMB

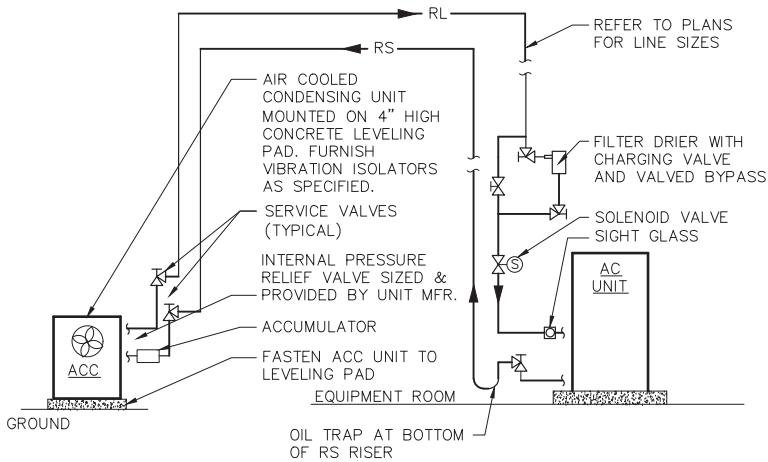IT IS A VIOLATION OF NYS LAW FOR ANY PERSON TO ALTER THIS DOCUMENT IN ANY WAY, UNLESS ACTING UNDER THE DIRECTION OF A LICENSED PROFESSIONAL ENGINEER. IF A DOCUMENT BEARING THE SEAL ON AN ENGINEER IS ALTERED, THE ALTERING ENGINEER SHALL AFFIX TO THE DOCUMENT THEIR SEAL AND THE NOTATION "ALTERED BY" FOLLOWED BY THEIR SIGNATURE AND THE DATE OF SUCH ALTERATION, AND A SPECIFIC DESCRIPTION OF THE ALTERATION.



- NOTES:**
- 1.) PROVIDE TRAPS AS FOLLOWS:
    - A. FOR RISES UP TO 50', USE 1 TRAP AT THE BOTTOM OF THE SUCTION RISER.
    - B. FOR RISES BETWEEN 50' AND 100', INSTALL A SECOND TRAP HALF WAY UP THE RISER.
    - C. FOR RISES OVER 100', INSTALL TRAPS AT 1/3 INTERVALS.
  - 2.) REFRIGERANT PIPING SHALL BE INSTALLED SO THAT THEY WILL NOT OBSTRUCT SERVICE ACCESS TO EITHER THE INDOOR COIL OR CONDENSING UNIT, THE AIR HANDLER IN GENERAL OR THE FILTER.
  - 3.) SLOPE HORIZONTAL SUCTION LINES APPROX. 1" EVERY 20 FEET TOWARD THE CONDENSING UNIT TO FACILITATE OIL RETURN.
  - 4.) ALL FASTENERS AND SUPPORTS LOCATED OUTDOORS SHALL BE GALVANIZED

1 REFRIGERANT PIPING SCHEMATIC  
SCALE: NONE

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WESTCHESTER COUNTY, NEW YORK DEPARTMENT OF PUBLIC WORKS DIVISION OF ENGINEERING				CONTRACT NUMBER 17 - 539	SHEET NUMBER M-702
				SHEET NO. 42 OF 59	
NEW GOLF CART STORAGE FACILITY AND CLUBHOUSE UPGRADES MOHANSIC GOLF COURSE, YORKYOWN, NEW YORK MECHANICAL DETAILS 2 OF 2				SCALE: NONE DATE: 6/4/21 DPW FILE NO. 10-02-M-75-0	
				REV. NO. 0	

SYMBOLS AND ABBREVIATIONS						GENERAL NOTES		
SYMBOL	ABBREVIATION	DESCRIPTION	SYMBOL	ABBREVIATION	DESCRIPTION	SYMBOL	ABBREVIATION	DESCRIPTION
	—	CONDUIT AND WIRING		—	FUSED SWITCH		PBO	PROVIDED BY OTHERS
	----	CONDUIT & WIRING TO BE REMOVED UON		GND	GROUND AS PER LOCAL CODE		PNL	PANEL
	—UG—	BURIED CONDUIT		—	GROUND BAR		PT	PRESSURE TREATED
	—OH—	OVERHEAD CONDUCTORS		—	GROUND ROD		PVC	POLY VINYL CHLORIDE
		HOMERUN TO PANEL, ARROWS INDICATE # 1P		XFMR	TRANSFORMER		REL.	REMOVE AND RELOCATE
		MULTI-POLE HOMERUN		CT	CURRENT TRANSFORMER		RGS	RIGID GALVANIZED STEEL
		ELECTRICAL EQUIPMENT AS INDICATED		—	UTILITY POLE		SCH	SCHEDULE
		ELECTRICAL EQUIPMENT TO BE REMOVED UON		WM	WATER MAIN		SW	SWITCH(ES)
		ELECTRIC METER		NC	NORMALLY CLOSED CONTACTS		TELCO	TELEPHONE COMPANY
		JUNCTION BOX		NO	NORMALLY OPEN CONTACTS		TYP	TYPICAL
		FUSED DISCONNECT SWITCH		MD	MOTORIZED DAMPER		UG	UNDERGROUND
		UNFUSED DISCONNECT SWITCH		SD OR CFSD	SMOKE DAMPER		UON	UNLESS OTHERWISE NOTED
		COMBINATION MOTOR STARTER/FUSED DISC.		UH	UNIT HEATER		VIF	VERIFY IN FIELD
		MOTOR STARTER		A	AMPERE(S)		V	VOLT(S)
		MOTOR		AC	AIR CONDITIONER		WH	WATER HEATER
		BATTERY PACK EMERGENCY LIGHT FIXTURE		ACC	AIR CONDITIONER CONDENSER		WP	WEATHERPROOF
		EXIT LIGHT, FACES-SHADED, CHEVRON-ARROW		AFF	ABOVE FINISHED FLOOR			
	S <sub>x</sub>	SINGLE POLE SWITCH (x – INDICATES FIXTURE BEING CONTROLLED)		AF	AMPERAGE OF FUSE			
	S <sub>x</sub> <sup>3</sup>	THREE WAY SWITCH (x – INDICATES FIXTURE BEING CONTROLLED)		AGL	ABOVE GRADE LEVEL			
	S <sub>x</sub> <sup>4</sup>	FOUR WAY SWITCH (x – INDICATES FIXTURE BEING CONTROLLED)		AL	ALUMINIUM			
	S <sub>x</sub> <sup>DIM</sup>	DIMMER SWITCH (x – INDICATES FIXTURE BEING CONTROLLED)		AS	AMPERAGE OF SWITCH			
	S <sub>M</sub>	MOTOR RATED TOGGLE SWITCH		AWG	AMERICAN WIRE GAUGE			
		WALL MOUNTED OCCUPANCY SENSOR		BCW	BARE COPPER WIRE			
		WALL MOUNTED VACANCY SENSOR						
		CEILING MOUNTED OCCUPANCY SENSOR						
		DUPLEX RECEPTACLE						
		DOUBLE DUPLEX RECEPTACLE						
		SPECIAL RECEPTACLE						
		FIRE ALARM MANUAL PULL STATION						
		FIRE ALARM COMBINATION AUDIO/VISUAL DEVICE (15/75 CD – STROBE)						
		FIRE ALARM COMBINATION AUDIO/VISUAL DEVICE (110 CD – STROBE)						
		FIRE ALARM STROBE 15/75 CD						
		FIRE ALARM STROBE 110 CD						
		SMOKE DETECTOR						
		HEAT DETECTOR						
		CARBON MONOXIDE DETECTOR						
	SB	FIRE ALARM DEVICE. SB – SOUNDER BASE FOR CARBON MONOXIDE DETECTOR						
	ANN	FIRE ALARM ANNUNCIATOR PANEL						
	CM	FIRE ALARM CONTROL MODULE						
	MM	FIRE ALARM MONITORING MODULE						
	FACP	FIRE ALARM CONTROL PANEL						
	BPS	BOOSTER POWER SUPPLY						
	R	FIRE ALARM RELAY						
	EGL	ELECTRICAL HAND DEVICE						
	EPO	EMERGENCY POWER OFF SWITCH						
	CB	CIRCUIT BREAKER						
		ENCLOSED CIRCUIT BREAKER						
<div>IN CHARGE OF <u>JW</u></div> <div>CHECKED BY <u>DS</u></div> <div>MADE BY <u>CT</u></div> <div>IT IS A VIOLATION OF NYS LAW FOR ANY PERSON TO ALTER THIS DOCUMENT IN ANY WAY, UNLESS ACTING UNDER THE DIRECTION OF A LICENSED PROFESSIONAL ENGINEER. IF A DOCUMENT BEARING THE SEAL ON AN ENGINEER IS ALTERED, THE ALTERING ENGINEER SHALL AFFIX TO THE DOCUMENT THEIR SEAL AND THE NOTATION "ALTERED BY" FOLLOWED BY THEIR SIGNATURE AND THE DATE OF SUCH ALTERATION, AND A SPECIFIC DESCRIPTION OF THE ALTERATION.</div>						<div>NOTES: 1.) ALL SYMBOLS AND ABBREVIATIONS MAY NOT BE APPLICABLE FOR THIS PROJECT. 2.) SEE LIGHTING FIXTURE SCHEDULE FOR LIGHT FIXTURE SYMBOLS.</div>		
						<div>1.) ALL WORK SHOWN IS NEW UNLESS OTHERWISE NOTED (UON) EXISTING TO REMAIN (EX.).</div> <div>2.) THE DRAWINGS ARE TO BE CONSIDERED SCHEMATIC ONLY AND DO NOT NECESSARILY SHOW THE EXACT LOCATIONS AND DETAILS OF THE WORK TO BE INSTALLED.</div> <div>3.) THE ELECTRICAL CONTRACTOR SHALL BE RESPONSIBLE FOR OBTAINING ALL NECESSARY PERMITS AND PAYING ALL FEES ASSOCIATED WITH THIS WORK INCLUDING FILING WITH THE UTILITY COMPANY (AS REQUIRED), AND WITH LOCAL AUTHORITY HAVING JURISDICTION.</div> <div>4.) ALL WORK INVOLVING THE ELECTRIC SERVICE SHALL BE COORDINATED AND APPROVED BY THE UTILITY COMPANY.</div> <div>5.) ALL CONDUCTORS SHALL BE COPPER UON "ON DRAWINGS".</div> <div>6.) ELECTRONIC FILES OF THE MECHANICAL, ELECTRICAL, PLUMBING AND FIRE PROTECTION DRAWINGS ARE AVAILABLE TO THE CONTRACTOR. THE ENGINEER MAY GRANT THE CONTRACTOR A LIMITED LICENSE TO MAKE A DERIVATIVE WORK OF THE DATABASE FOR THE PURPOSE OF SHOP DRAWINGS, SUBMITTALS AND AS-BUILT DRAWINGS. UPON REQUEST, THE ENGINEER SHALL PROVIDE A RELEASE FORM THAT MUST BE SIGNED AND RETURNED BY THE CONTRACTOR PRIOR TO RELEASE OF THE ELECTRONIC FILES.</div> <div>7.) CIRCUIT NUMBERS ARE FOR INFORMATION PURPOSES ONLY. ACTUAL CIRCUIT NUMBERS SHALL BE DETERMINED IN THE FIELD.</div> <div>8.) CORE DRILLING OR TRENCHING THROUGH AN EXISTING FLOOR SLAB, WHEN REQUIRED, SHALL BE COORDINATED WITH THE OWNER. FLOOR SLABS SHALL BE RADAR SCANNED PRIOR TO CORE DRILLING OR TRENCHING. ALL WORK, INCLUDING CORE DRILLING, RADAR SCAN, INSTALLATION OF FIRE STOPPING, &amp; CONDUIT/CABLE INSTALLATION SHALL BE PERFORMED DURING NON-BUSINESS HOURS AND INCLUDED IN BASE BID. USE EXTREME CAUTION DURING ANY CUTTING OPERATION TO AVOID DAMAGE TO EXISTING EQUIPMENT/SYSTEMS. ANY ITEMS DAMAGED AS A RESULT OF CORE DRILLING SHALL BE REPAIRED AT NO COST TO THE CLIENT. ALL CORES SHALL BE FIRE SEALED.</div> <div>9.) FOR EACH WALL MOUNTED COMMUNICATIONS OUTLET, PROVIDE A 1900 JUNCTION BOX WITH AN EXTENDER COLLAR AND 1 INCH CONDUIT WITH DRAGLINE 6 INCHES ABOVE ACCESSIBLE CEILING FOR INSTALLATION OF CABLE BY OTHERS.</div> <div>10.) COMMUNICATION WIRING BY OTHERS. COORDINATE COMMUNICATION JACKS WITH REPRESENTATIVE, TYPICAL.</div> <div>11.) WHERE GFI RECEPTACLES ARE CIRCUITED WITH GENERAL CONVENIENCE RECEPTACLES, THE GFI RECEPTACLE SHALL BE THE LAST DEVICE ON THE CIRCUIT.</div> <div>12.) INSTALL CONDUIT EXPANSION FITTINGS AT ALL LOCATIONS WHERE CONDUITS CROSS BUILDING OR STRUCTURE EXPANSION JOINTS.</div> <div>13.) UNLESS OTHERWISE NOTED, DISCONNECT SWITCHES, STARTERS, HOAS AND MOTOR RATED TOGGLE SWITCHES FOR MECHANICAL PUMPS, CABINET AND UNIT HEATERS, RETURN FANS, ROOF FANS, VAV BOXES, COMPRESSORS, FAN COIL UNITS, AIR HANDLERS AND CONDENSERS SHALL BE FURNISHED BY THE MECHANICAL CONTRACTOR AND INSTALLED BY THE ELECTRICAL CONTRACTOR. COORDINATE ALL WORK WITH THE MECHANICAL CONTRACTOR.</div> <div>14.) DISCONNECT SWITCHES FOR MOTORIZED DAMPERS, CFSD/SD AND VAV BOXES SUPPLIED BY MECHANICAL CONTRACTOR AND INSTALLED AND WIRED BY ELECTRICAL CONTRACTOR. SWITCHES NOT SHOWN ON PLANS.</div> <div>15.) INCLUDE IN BASE BID (2) 1P-20A CIRCUITS ON EACH AREA LISTED (150' LENGTH EACH) FOR HVAC SYSTEM CONTROL PANELS. EXACT LOCATION OF CONTROL PANELS SHALL BE COORDINATED WITH DIVISION 15 IN THE FIELD. CIRCUITS SHALL ORIGINATE FROM THE FOLLOWING PANELBOARDS:<div>CLUBHOUSE RESTROOMS/STORAGE – PPCH1-19,21 GOLF CART STORAGE SHED – PPCS-29,31</div></div> <div>16.) THE ELECTRICAL CONTRACTOR SHALL PROVIDE ALL CUTTING, PATCHING, PAINTING, AND FINAL RESTORATION REQUIRED TO FACILITATE THE DEMOLITION AND INSTALLATION OF ALL ELECTRICAL EQUIPMENT, INCLUDING BUT NOT LIMITED TO PANELBOARDS, CONDUITS, WIRING, DEVICES, FIXTURES, ETC. INCLUDING ABOVE CEILINGS. CONTRACTOR TO REMOVE AND REPLACE CEILINGS, AND OPEN AND PATCH WALLS, AS REQUIRED TO EXECUTE THE ELECTRICAL WORK.</div>		
						<div><div><div><div></div><div></div><div></div><div></div></div><div>REVISION NUMBERDATEMADE BYAPP'D BYREVISION</div><div>RECORD DRAWING CERTIFICATION</div><div><div><input type="checkbox"/> AS BUILT – CHANGES AS NOTED</div><div><input type="checkbox"/> AS BUILT – NO CHANGES</div></div><div><div><div>CONTRACTOR</div><div>NAME</div><div>SIGNATURE</div><div>TITLE</div><div>DATE</div></div><div><div>PROJECT COORDINATOR</div><div>NAME</div><div>SIGNATURE</div><div>TITLE</div><div>DATE</div></div></div><div><div>WESTCHESTER COUNTY, NEW YORK</div><div>DEPARTMENT OF PUBLIC WORKS</div><div>DIVISION OF ENGINEERING</div><div>NEW GOLF CART STORAGE FACILITY AND CLUBHOUSE UPGRADES</div><div>MOHANSIC GOLF COURSE, YORKYOWN, NEW YORK</div><div>ELEC. SYMBOLS, ABBREVIATIONS &amp; NOTES</div></div><div><div>CONTRACT NUMBER</div><div>17 - 539</div><div>SHEET NUMBER</div><div>E-001</div><div>SHEET NO. 43 OF 59</div><div>SCALE: NONE</div><div>DATE: 6/4/21</div><div>DPW FILE NO.</div><div>10-02-E-76-0</div><div>REV. NO.</div><div>0</div></div></div></div>		


	<div>DEFINITION OF TERMS</div> <div>1.) WHEREVER IN THE CONTRACT DOCUMENTS THE WORD "CLIENT" IS USED, IT MUST BE UNDERSTOOD THAT "WESTCHESTER COUNTY DEPARTMENT OF PUBLIC WORKS &amp; TRANSPORTATION " IS INTENDED.</div> <div>2.) WHEREVER IN THE CONTRACT DOCUMENTS THE WORD "ARCHITECT" IS USED, IT MUST BE UNDERSTOOD THAT "BUSING ASSOCIATES ARCHITECTS, LLP" IS INTENDED.</div> <div>3.) WHEREVER IN THE CONTRACT DOCUMENTS THE WORD "ENGINEER" IS USED, IT MUST BE UNDERSTOOD THAT "OLA CONSULTING ENGINEERS" IS INTENDED.</div> <div>4.) WHEREVER IN THE CONTRACT DOCUMENTS THE WORDS "ELECTRICAL UTILITY" OR "POWER COMPANY" ARE USED, IT MUST BE UNDERSTOOD THAT "CON EDISON" IS INTENDED. CON EDISON CASE #MC-512542, REPRESENTATIVE JENNIFER O'KEEFE.</div> <div>5.) WHEREVER IN THE CONTRACT DOCUMENTS THE WORDS "TELEPHONE UTILITY" OR "TELCO" ARE USED, IT MUST BE UNDERSTOOD THAT "VERIZON" IS INTENDED.</div> <div>6.) WHEREVER IN THE CONTRACT DOCUMENTS THE WORDS "FIRE ALARM SYSTEM" OR "FIRE ALARM VENDOR" ARE USED, IT MUST BE UNDERSTOOD THAT "OPEN SYSTEMS" IS INTENDED.</div> <div>7.) "WORK" MUST BE DEEMED TO CONSIST OF ALL LABOR AND OPERATIONS, TRANSPORTATION, HOISTING, MATERIALS, TOOLS, EQUIPMENT, SERVICES, INSPECTIONS, INVESTIGATIONS, COORDINATION AND SUPERVISION REQUIRED AND / OR REASONABLY NECESSARY TO PRODUCE THE CONSTRUCTION REQUIRED BY THE CONTRACT DOCUMENTS.</div> <div>8.) "FURNISH" MEANS THE DESIGN, FABRICATION, PURCHASE AND DELIVERY TO THE JOB SITE.</div> <div>9.) "INSTALL OR INSTALLATION" MEANS THE ACT OF PHYSICALLY PLACING, APPLYING, SETTING, ERECTING, ANCHORING, SECURING, ETC., CONSTRUCTION MATERIALS, EQUIPMENT, FURNISHINGS, APPLIANCES, AND SIMILAR ITEMS SPECIFIED AND FURNISHED AT THE JOB SITE. INSTALLATION OF SPECIFIED ITEMS MUST BE COMPLETE IN ALL RESPECTS.</div> <div>10.) "PROVIDE" MEANS TO FURNISH AND INSTALL CONSTRUCTION MATERIAL, EQUIPMENT, ETC. AS DEFINED ABOVE.</div> <div>11.) THE FOLLOWING ARE DEFINITIONS OF SHOP DRAWING STAMP ACTIONS:</div> <div>A.) "NO EXCEPTIONS TAKEN" MEANS THAT THE SHOP DRAWING IS CORRECT AS TO PERFORMANCE, CAPACITY, ETC. AND SUBSTANTIAL CONFORMANCE TO THE CONTRACT DRAWINGS AND SPECIFICATIONS. FABRICATION AND/OR PURCHASE MAY COMMENCE.</div> <div>B.) "MAKE CORRECTIONS NOTED" MEANS THAT THE SHOP DRAWING IS CORRECT AS TO PERFORMANCE, CAPACITY, ETC. AND SUBSTANTIAL CONFORMANCE TO THE CONTRACT DRAWINGS AND/OR SPECIFICATIONS, SUBJECT TO AND IN COMPLIANCE WITH THE ANNOTATIONS AND/OR CORRECTIONS INDICATED ON THE SHOP DRAWING. FABRICATION AND/OR PURCHASE MAY COMMENCE.</div> <div>C.) "AMEND AND RESUBMIT" MEANS THAT THE COMMENTS AND/OR CORRECTION ARE SO EXTENSIVE AND IMPORTANT THAT THE REVIEWER WANTS TO SEE HOW THE COMMENTS AND/OR CORRECTIONS ARE RESOLVED PRIOR TO RELEASE FOR FABRICATION AND/OR PURCHASE. FABRICATIONS AND/OR PURCHASE MAY <u>NOT</u> COMMENCE.</div> <div>D.) "REJECTED" MEANS THAT THE SHOP DRAWING DOES NOT COMPLY OR CONFORM TO THE CONTRACT DRAWINGS AND/OR SPECIFICATIONS. FABRICATION AND/OR PURCHASE MAY <u>NOT</u> COMMENCE.</div>	<div>TRENCHING NOTES</div> <div>1.) CONTRACTOR SHALL LOCATE ALL EXISTING UNDERGROUND UTILITIES THAT ARE NOT PART OF N.Y. STATE "CODE 753" PRIOR TO DIGGING.</div> <div>2.) ALL EXCAVATING IN THE AREA OF THE EXISTING UNDERGROUND EQUIPMENT, PIPES AND CONDUITS SHALL BE PERFORMED BY HAND.</div> <div>3.) ANY AREA/PLANTS OR LANDSCAPING OR PAVEMENTS DISTURBED DURING THE EXCAVATION SHALL BE RESTORED OR REPLACED TO MATCH EXISTING CONDITIONS BY THE CONTRACTOR AT NO COST TO THE OWNER.</div> <div>4.) ANY EXISTING BURIED CONDUITS, DRAINAGE, SPRINKLER PIPING, ETC. THAT IS DISTURBED AND/OR DAMAGED DURING CONSTRUCTION SHALL BE REPAIRED BY THE CONTRACTOR AT NO COST TO THE OWNER.</div> <div>5.) THE PLANS SHOW SOME KNOWN SUBSURFACE STRUCTURES, ABOVE GROUND STRUCTURES AND/OR UTILITIES BELIEVED TO EXIST IN THE WORKING AREA, EXACT LOCATION OF WHICH MAY VARY FROM THE LOCATIONS INDICATED. IN PARTICULAR, THE CONTRACTOR IS WARNED THAT THE EXACT OR EVEN APPROXIMATE LOCATION OF SUCH PIPELINES, SUBSURFACE STRUCTURES AND/OR UTILITIES IN THE AREA MAY OR MAY NOT BE SHOWN; AND IT SHALL BE HIS RESPONSIBILITY TO PROCEED WITH GREAT CARE IN EXECUTING ANY WORK. 48 HOURS BEFORE YOU DIG, DRILL OR BLAST, CALL 1-800-962-7962 (NY STATE).</div>																																																																													
	<div>DEMOLITION NOTES</div> <div>1.) ALL EQUIPMENT SHALL BE DISCONNECTED AND REMOVED BACK TO POWER SOURCE ORIGINATION UNLESS OTHERWISE NOTED (UON) EXISTING TO REMAIN (EX.).</div> <div>2.) CONTRACTOR SHALL VERIFY EXTENT OF DEMOLITION WORK IN THE FIELD PRIOR TO BID AND SHALL INCLUDE ALL LABOR AND MATERIALS IN BASE BID INCLUDING ALL TEMPORARY CONNECTIONS, CONDUIT AND WIRE IN ORDER TO ACCOMMODATE CONSTRUCTION AND PROVIDE CONTINUOUS SERVICE TO DEVICES AND SYSTEMS TO REMAIN, TEMPORARY AND PERMANENTLY. WORK REQUIRING THE SHUT-DOWN OF THE BUILDING POWER SHALL BE PERFORMED DURING OVERTIME AND SHALL BE INCLUDED IN BASE BID.</div> <div>3.) CIRCUIT BREAKER, CONDUIT AND CONDUCTOR SIZES INDICATED SHALL BE FIELD VERIFIED PRIOR TO BID.</div> <div>4.) ALL EXISTING ELECTRICAL EQUIPMENT NO LONGER IN USE, SUCH AS DISCONNECT SWITCHES, MOTOR CONTROLLERS, MOTOR STARTER PANELS, ETC. SHALL BE REMOVED UON.</div> <div>5.) ALL DISCONNECTED &amp; REMOVED EXISTING ELECTRICAL ITEMS THAT ARE NOT BEING REUSED SHALL BE RETURNED TO THE OWNER OR DISPOSED OF AS DIRECTED.</div> <div>6.) THE CONTRACTOR SHALL INCLUDE IN THE BASE BID FOR ALL MATERIAL &amp; LABOR REQUIRED FOR THE EXTENSIONS, REROUTING &amp; RELOCATION OF EXISTING SYSTEM COMPONENTS, EQUIPMENT, WIRING, CONDUITS &amp; CABLING SO AS TO MAINTAIN OPERATION OF ALL SYSTEMS THROUGHOUT THE BUILDING DURING DEMOLITION &amp; CONSTRUCTION PHASES.</div>																																																																														
	<div>TYPICAL BRANCH CIRCUIT WIRING LEGEND</div> <div><div><div>2-#12 &amp; 1-#12 GND (1-1P-20A OR 1-1P-15A CB)</div><div>3-#12 &amp; 1-#12 GND (3P-20A OR 3P-15A CB)</div><div>2-#12 &amp; 1-#12 GND (2P-20A OR 2P-15A CB)</div></div><div><div><div><div><div>13</div><div>CIRCUIT #</div><div>RECEPTACLE</div></div><div><div>15</div><div>LIGHT FIXTURE TYPE</div><div>SWITCH CONTROL</div><div>LIGHT FIXTURE</div><div>CIRCUIT #</div></div></div></div></div><div>NOTES: 1.) EACH 120V AND 277V CIRCUIT SHALL HAVE A DEDICATED NEUTRAL CONDUCTOR. SHARED NEUTRAL HOMERUNS ARE NOT PERMITTED. 2.) CONDUCTORS SHALL BE INCREASED FOR VOLTAGE DROP AND DERATING AS PER APPLICABLE ELECTRICAL CODE. FOR CIRCUITS THAT ARE BETWEEN 100' AND 150' IN LENGTH, PHASE AND NEUTRAL CONDUCTORS SHALL BE #10 AWG. FOR CIRCUITS THAT ARE BETWEEN 150' AND 225' IN LENGTH, PHASE AND NEUTRAL CONDUCTORS SHALL BE #8 AWG. FOR LENGTHS GREATER THAN 225' IN LENGTH, VERIFY CONDUCTOR SIZES WITH ENGINEER.</div></div>	<table><tr><td colspan="4"><div><div><div>OLA Consulting Engineers</div><div>60 Broadway, Hawthorne, New York 10632 914.747.2800</div><div>8 West 38th Street, Suite 501 New York, NY 10018 646.848.4190</div><div>ola.co.com</div></div><div>DBA0006.00</div></div></td><td colspan="2"><div><div>STATE OF NEW YORK</div><div>STEVEN ABBATISIO</div><div>07723T</div><div>LICENSED PROFESSIONAL ENGINEER</div></div></td></tr><tr><td></td><td></td><td></td><td></td><td colspan="2"></td></tr><tr><td>REVISION NUMBER</td><td>DATE</td><td>MADE BY</td><td>APP'D BY</td><td colspan="2">REVISION</td></tr><tr><td colspan="6">RECORD DRAWING CERTIFICATION</td></tr><tr><td colspan="6"><div><input type="checkbox"/> AS BUILT - CHANGES AS NOTED</div><div><input type="checkbox"/> AS BUILT - NO CHANGES</div></td></tr><tr><td colspan="3">CONTRACTOR</td><td colspan="3">PROJECT COORDINATOR</td></tr><tr><td colspan="3">NAME _____</td><td colspan="3">NAME _____</td></tr><tr><td colspan="3">SIGNATURE _____</td><td colspan="3">SIGNATURE _____</td></tr><tr><td colspan="3">TITLE _____</td><td colspan="3">TITLE _____</td></tr><tr><td colspan="3">DATE _____</td><td colspan="3">DATE _____</td></tr><tr><td colspan="4">WESTCHESTER COUNTY, NEW YORK DEPARTMENT OF PUBLIC WORKS DIVISION OF ENGINEERING</td><td>CONTRACT NUMBER 17 - 539</td><td>SHEET NUMBER E-002</td></tr><tr><td colspan="4">NEW GOLF CART STORAGE FACILITY AND CLUBHOUSE UPGRADES MOHANSIC GOLF COURSE, YORKTOWN, NEW YORK ELECTRICAL NOTES</td><td colspan="2">SCALE: NONE DATE: 6/4/21 DPW FILE NO. 10-02-E-77-0</td></tr><tr><td colspan="4"></td><td>REV. NO.</td><td>0</td></tr></table>		<div><div><div>OLA Consulting Engineers</div><div>60 Broadway, Hawthorne, New York 10632 914.747.2800</div><div>8 West 38th Street, Suite 501 New York, NY 10018 646.848.4190</div><div>ola.co.com</div></div><div>DBA0006.00</div></div>				<div><div>STATE OF NEW YORK</div><div>STEVEN ABBATISIO</div><div>07723T</div><div>LICENSED PROFESSIONAL ENGINEER</div></div>								REVISION NUMBER	DATE	MADE BY	APP'D BY	REVISION		RECORD DRAWING CERTIFICATION						<div><input type="checkbox"/> AS BUILT - CHANGES AS NOTED</div> <div><input type="checkbox"/> AS BUILT - NO CHANGES</div>						CONTRACTOR			PROJECT COORDINATOR			NAME _____			NAME _____			SIGNATURE _____			SIGNATURE _____			TITLE _____			TITLE _____			DATE _____			DATE _____			WESTCHESTER COUNTY, NEW YORK DEPARTMENT OF PUBLIC WORKS DIVISION OF ENGINEERING				CONTRACT NUMBER 17 - 539	SHEET NUMBER E-002	NEW GOLF CART STORAGE FACILITY AND CLUBHOUSE UPGRADES MOHANSIC GOLF COURSE, YORKTOWN, NEW YORK ELECTRICAL NOTES				SCALE: NONE DATE: 6/4/21 DPW FILE NO. 10-02-E-77-0					
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# 1 ELECTRICAL SITE DEMOLITION PLAN SCALE: 1" = 32'-0"

## NOTES:


- 1.) PRIMARY SERVICE - 2,400V, 1Ø.
- 2.) SECONDARY SERVICES - 120/240V, 1Ø, 3W.

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WESTCHESTER COUNTY, NEW YORK DEPARTMENT OF PUBLIC WORKS DIVISION OF ENGINEERING		NEW GOLF CART STORAGE FACILITY AND CLUBHOUSE UPGRADES MOHANSIC GOLF COURSE, YORKTOWN, NEW YORK ELECTRICAL SITE DEMOLITION PLAN		
CONTRACT NUMBER 17-539		SHEET NUMBER E-010		SCALE: AS NOTED DATE: 6/4/21
SHEET NO. 45 OF 59		DPW FILE NO. 10-02-E-78-0		REV. NO. 0

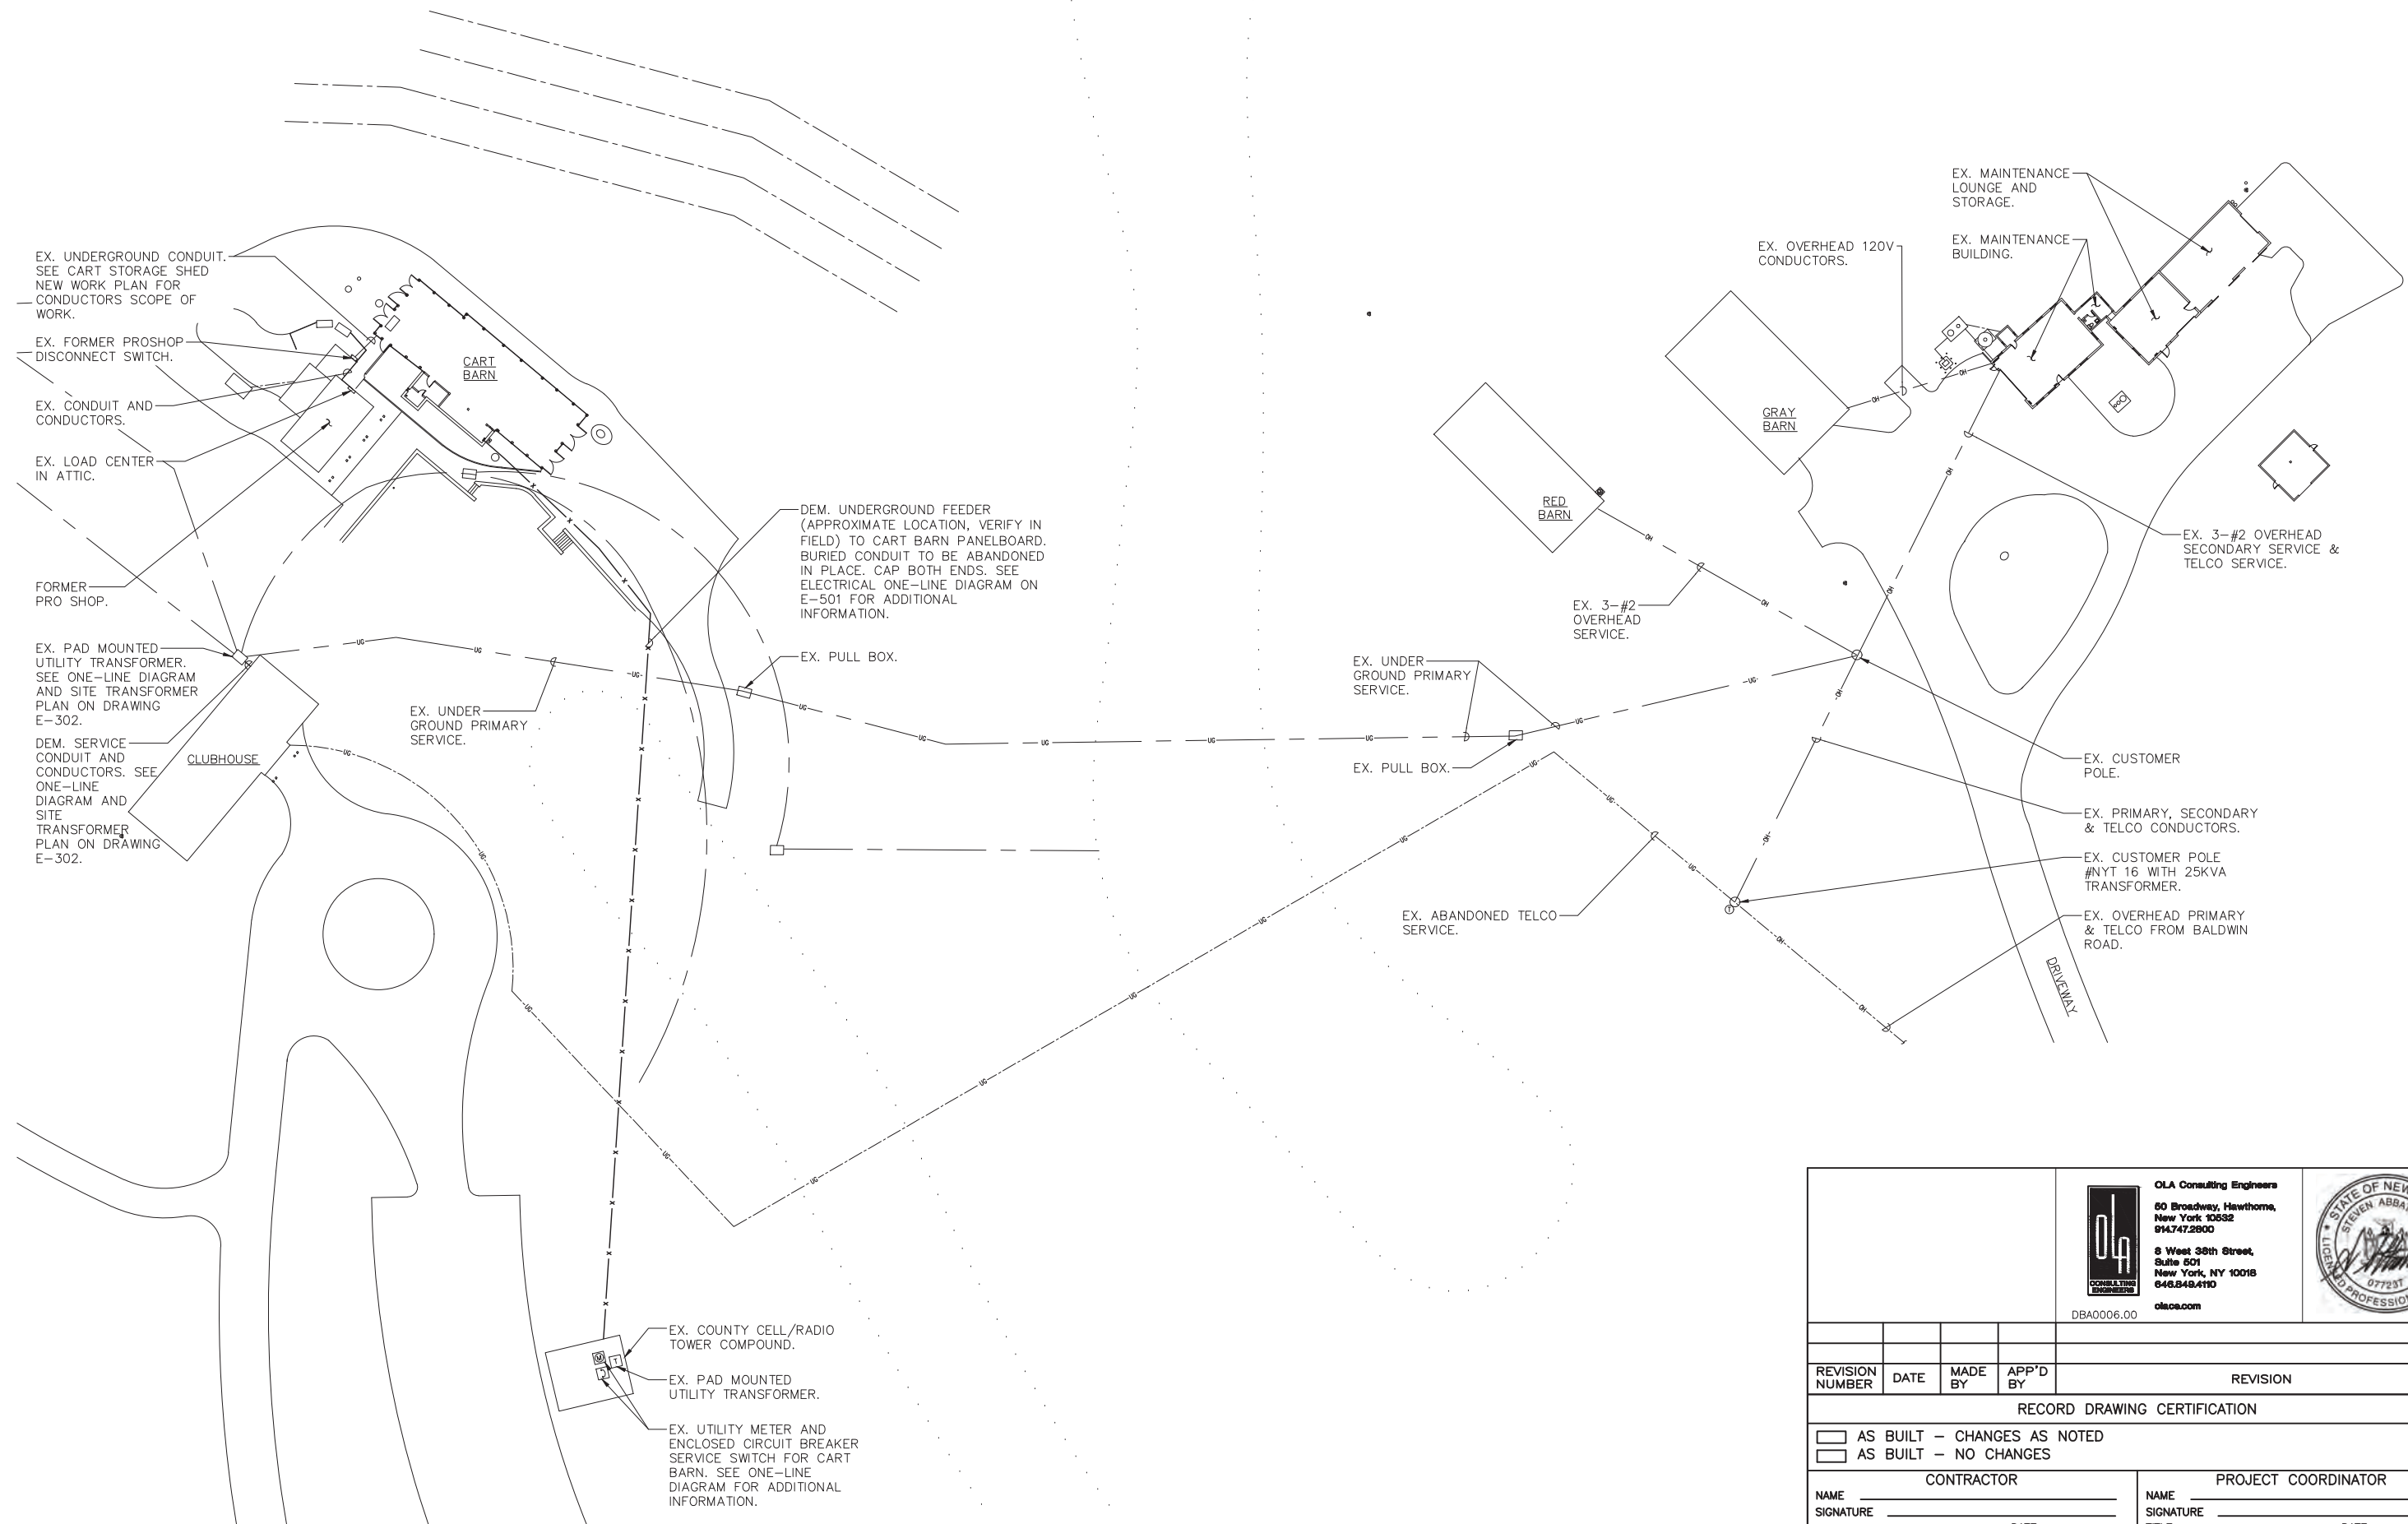

# ELECTRICAL SITE NEW WORK PLAN

SCALE: 1" = 32'-0"
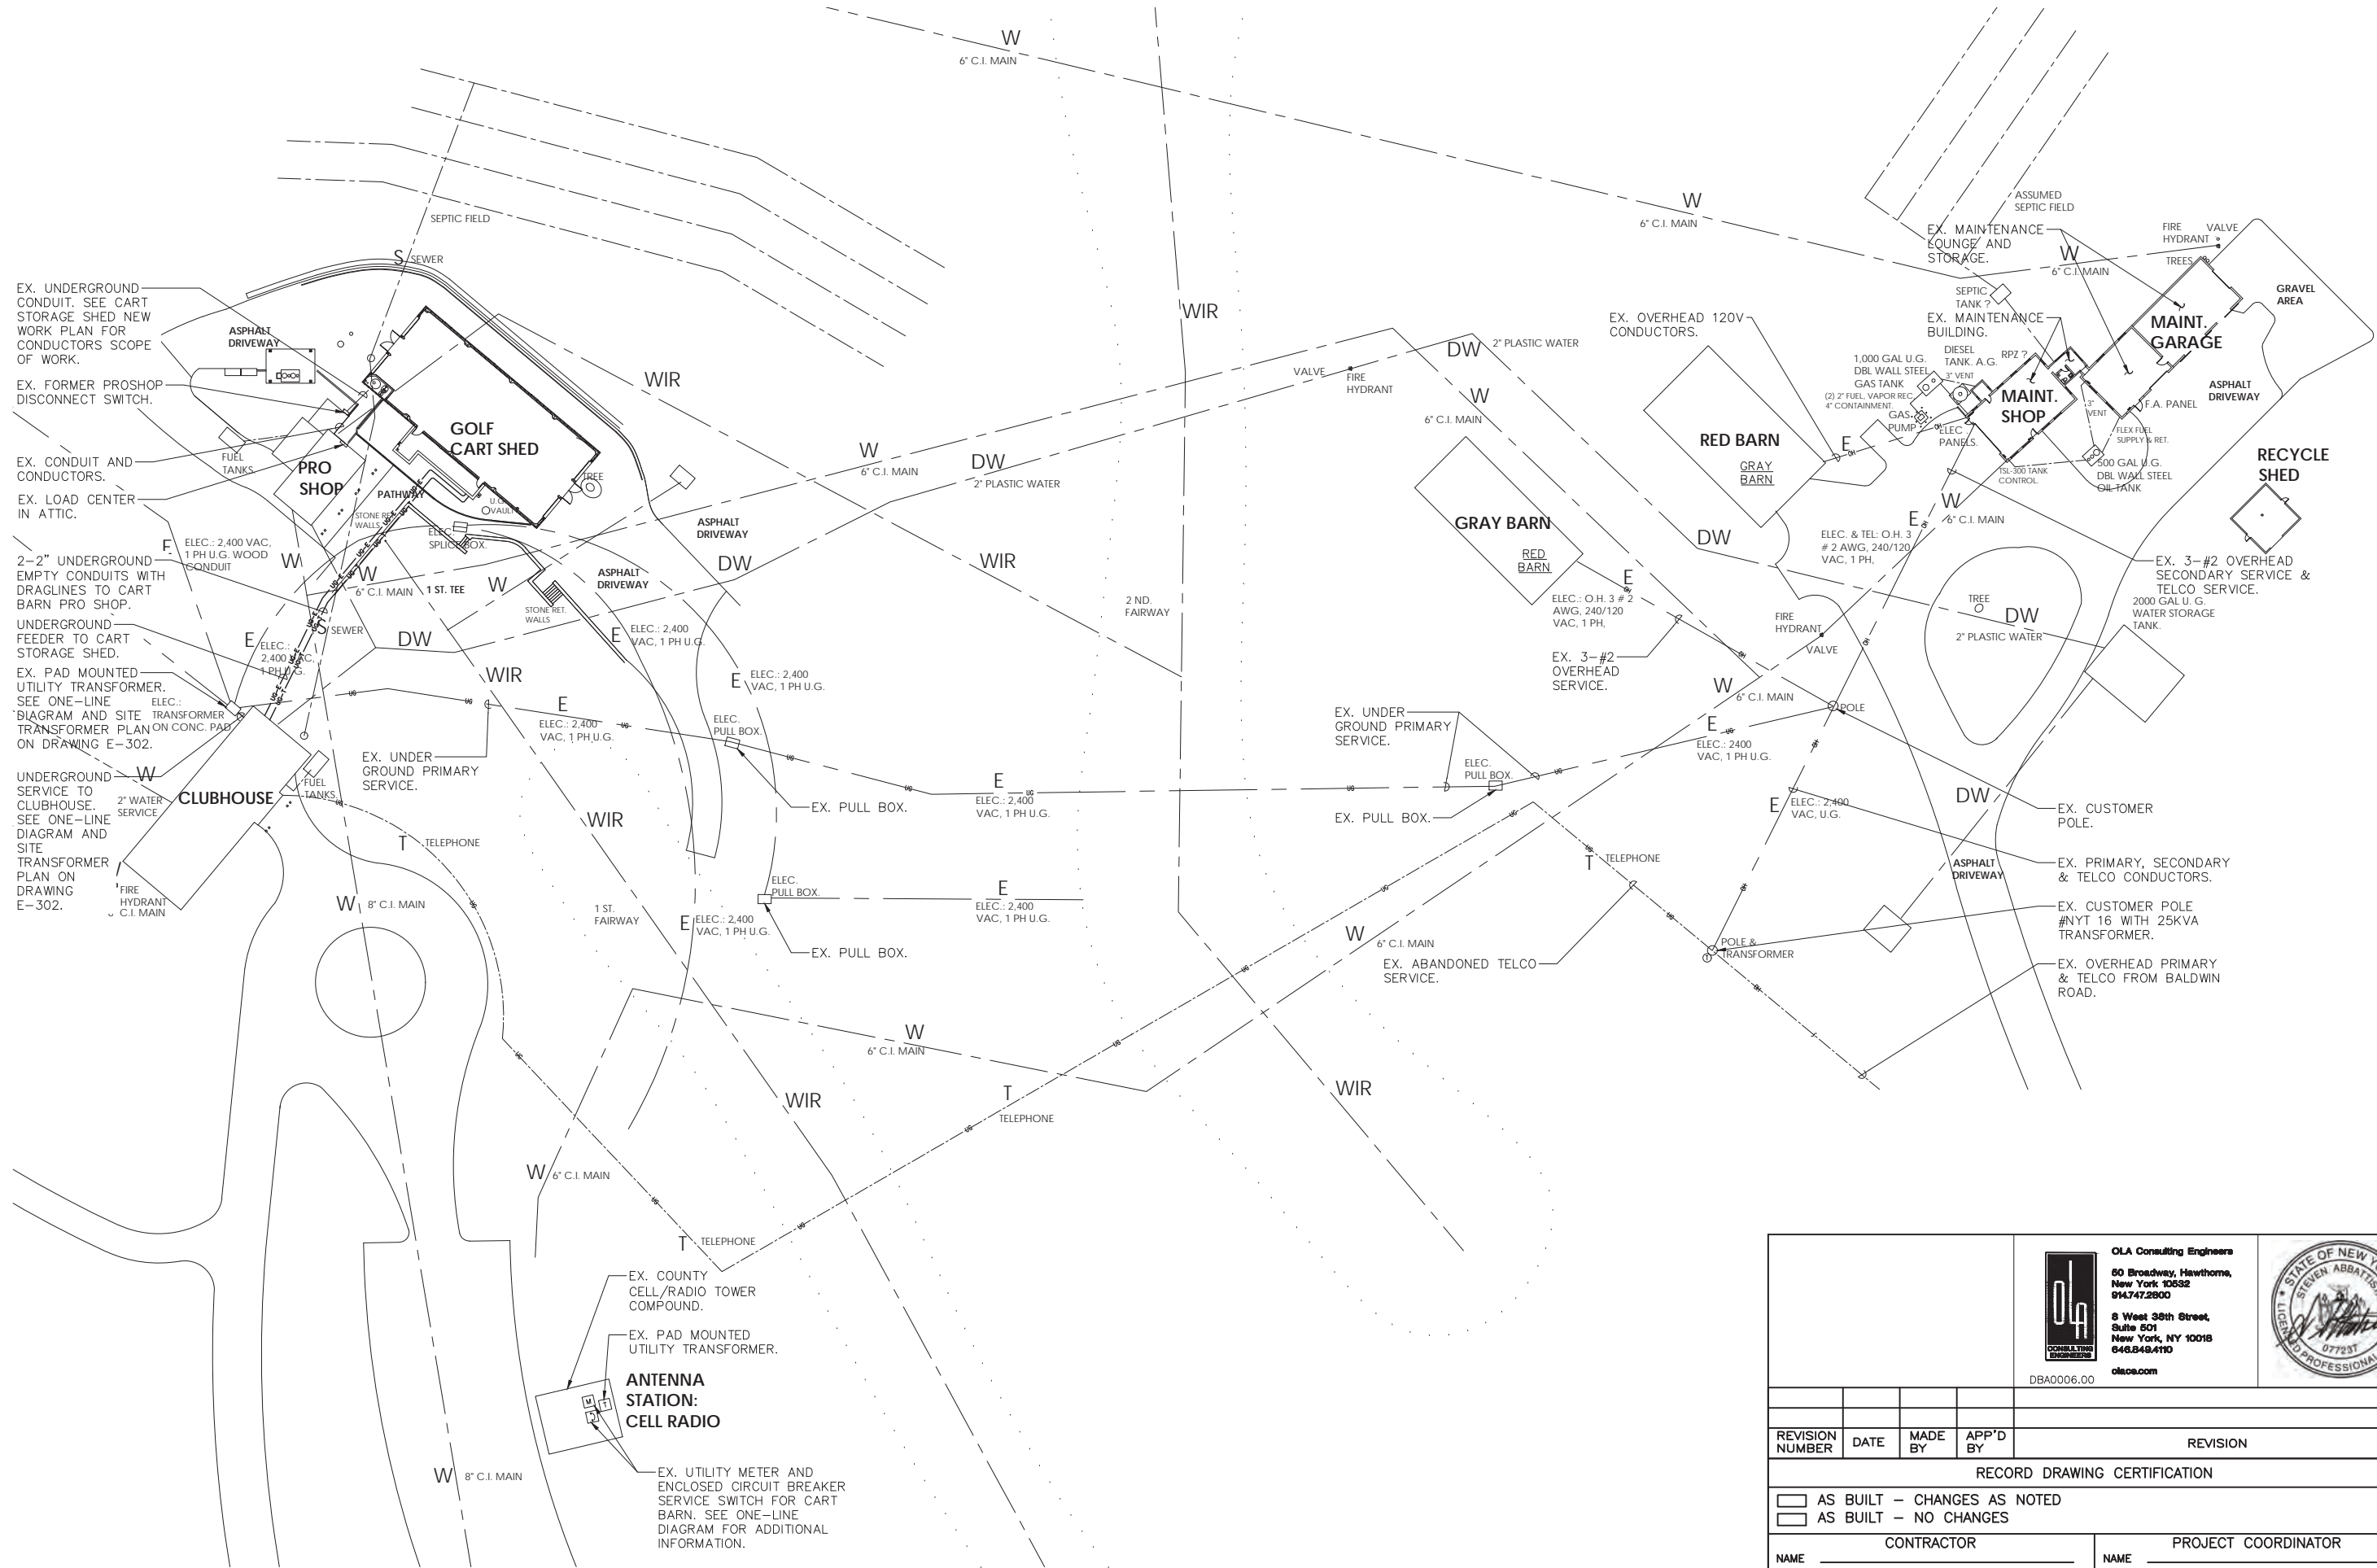
## NOTES:

- 1.) PRIMARY SERVICE - 2,400V, 1Ø.
- 2.) SECONDARY SERVICES - 120/240V, 1Ø, 3W.

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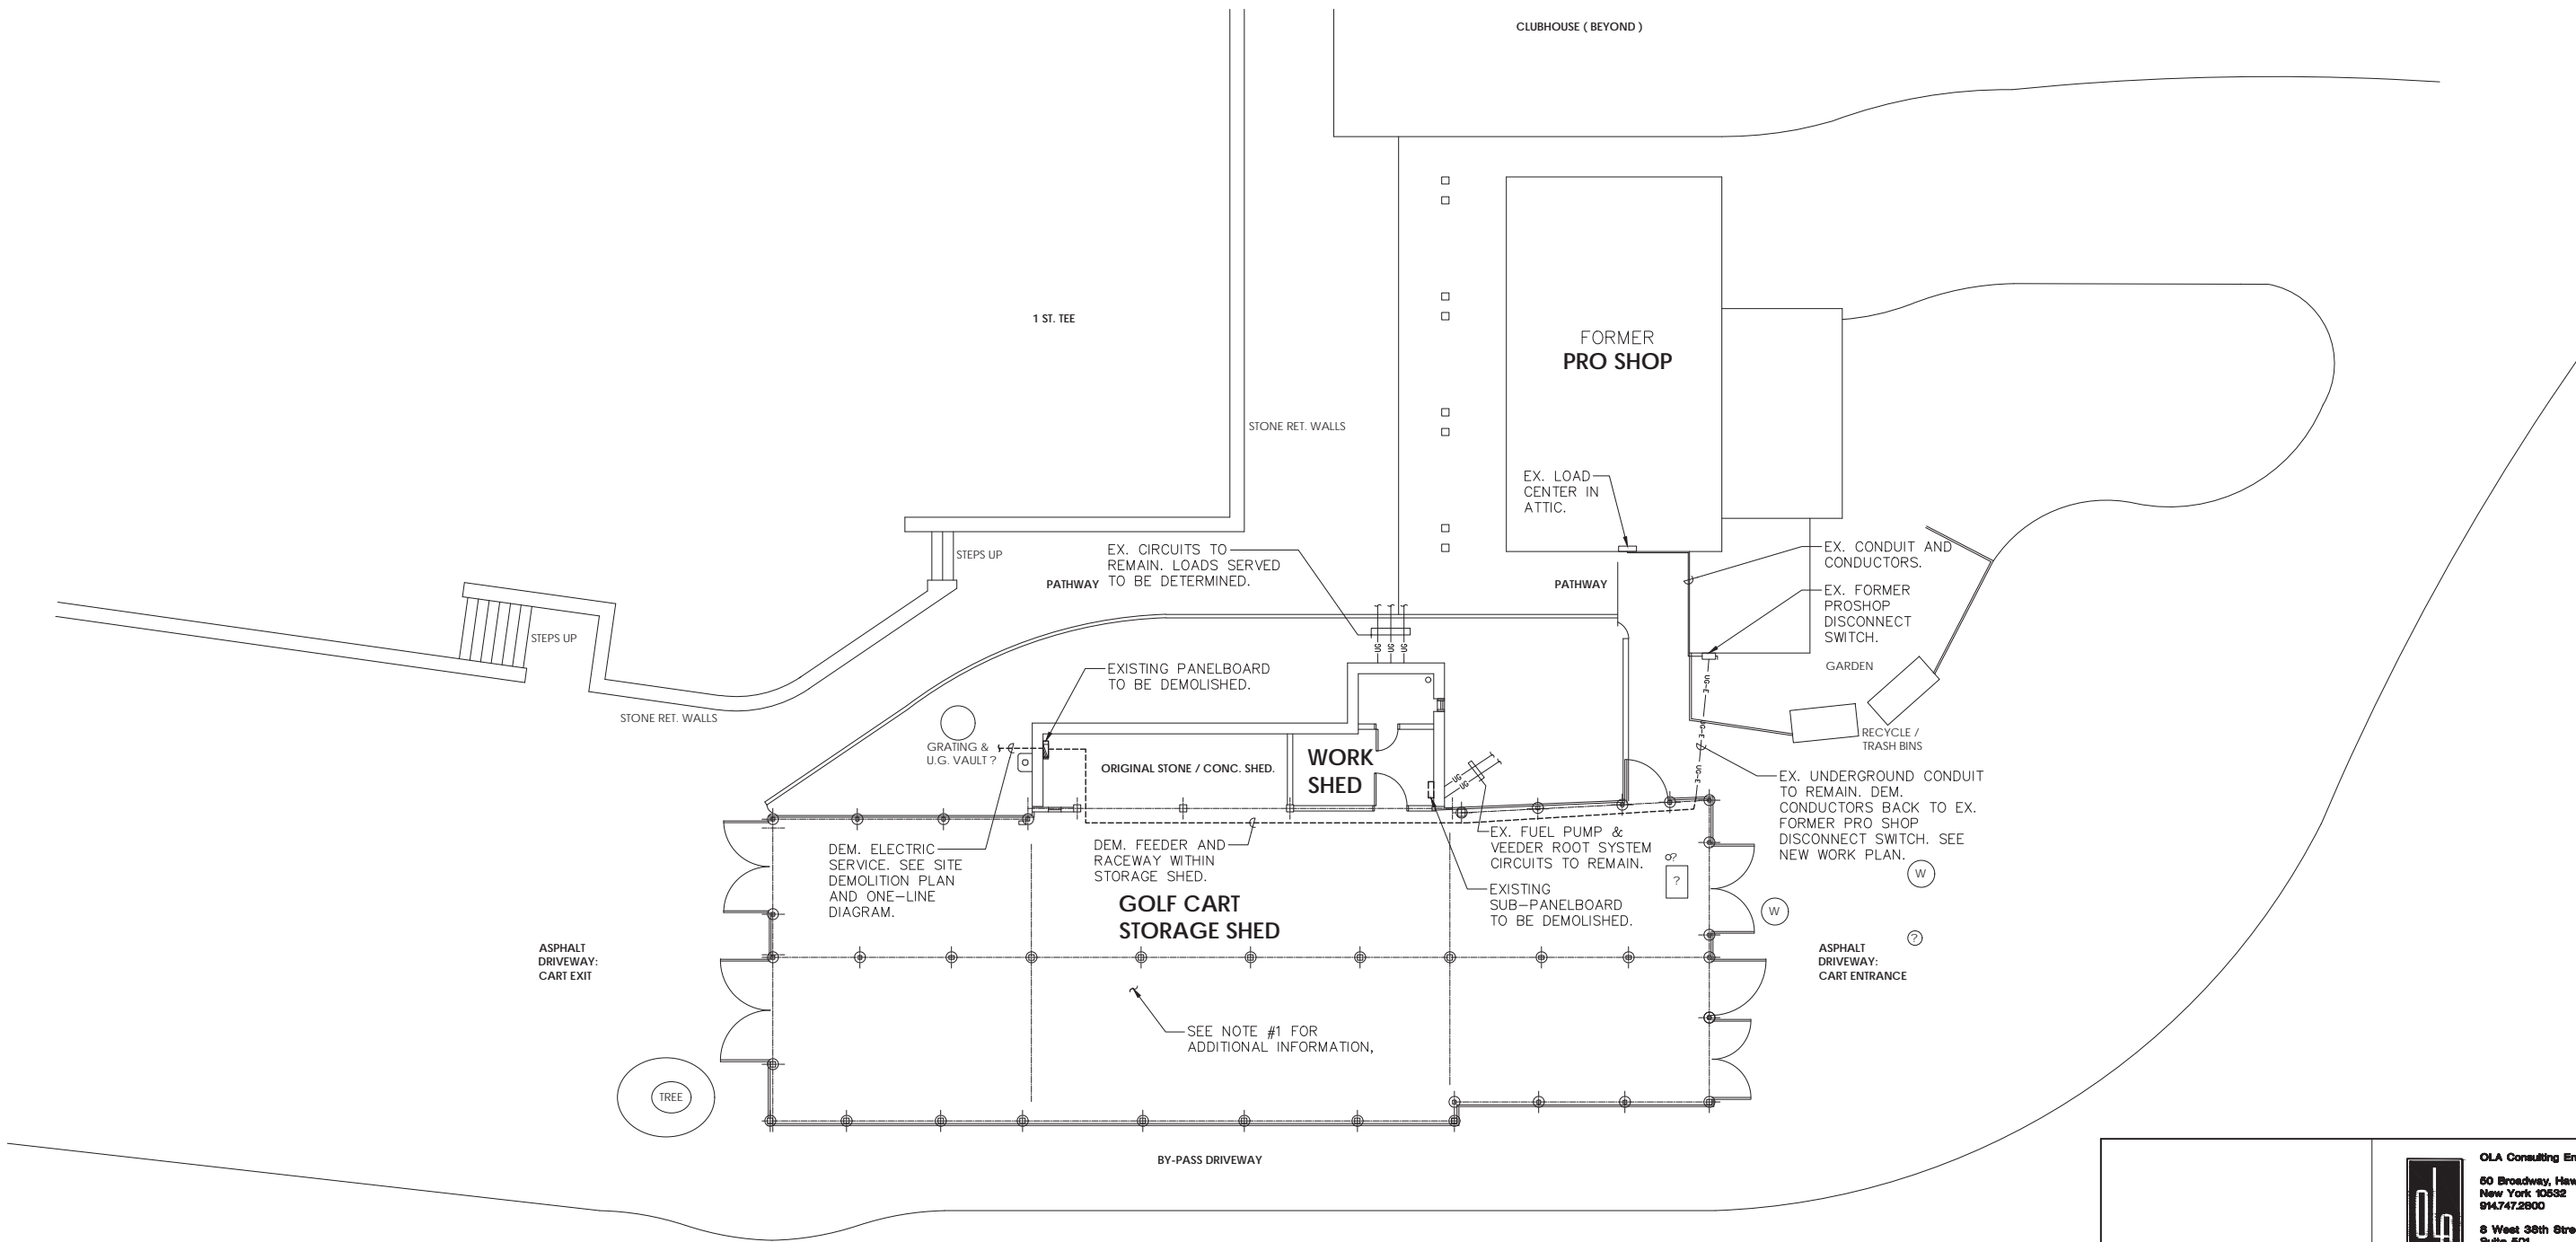
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CONTRACT NUMBER		SHEET NUMBER		REV. NO.
17-539		E-020		0
SHEET NO. 46 OF 59				
SCALE: NONE DATE: 6/4/21 DPW FILE NO. 10-02-E-79-0				



NOTES:  
1.) DEMOLISH ALL LIGHTING FIXTURES, LIGHT SWITCHES, SECURITY EQUIPMENT, RECEPTACLES AND CIRCUITRY BACK PANELBOARDS.




CART STORAGE SHED  
ELECTRICAL DEMOLITION PLAN  
SCALE: 1/8" = 1'-0"


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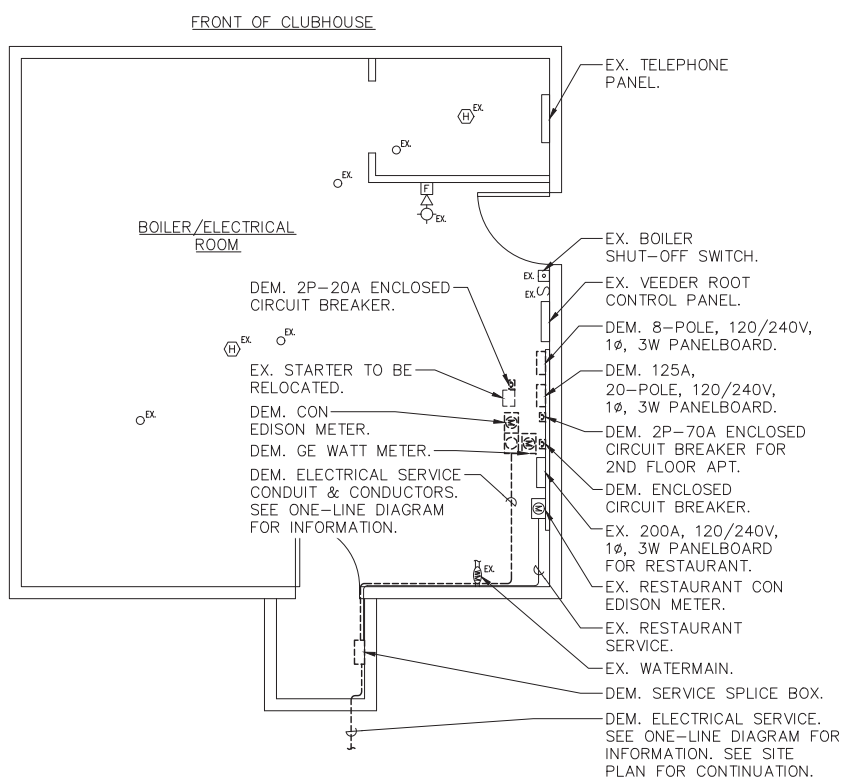
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CONTRACTOR			PROJECT COORDINATOR		
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TITLE	DATE		TITLE	DATE	
WESTCHESTER COUNTY, NEW YORK DEPARTMENT OF PUBLIC WORKS DIVISION OF ENGINEERING			CONTRACT NUMBER 17 - 539 SHEET NUMBER E-101 SHEET NO. 47 OF 59		
NEW GOLF CART STORAGE FACILITY AND CLUBHOUSE UPGRADES MOHANSIC GOLF COURSE, YORKYOWN, NEW YORK CART STORAGE SHED ELEC. DEMOLITION PLAN			SCALE: 1/8" = 1'-0" DATE: 6/4/21 DPW FILE NO. 10-02-E-80-0 REV. NO. 0		



- NOTES:
- 1.) DEMOLISH ALL LIGHTING FIXTURES, LIGHT SWITCHES, EXIT SIGNS, CEILING FANS, HAND DRYERS, EMERGENCY LIGHTS, AUTOMATIC FLUSH VALVES, SECURITY EQUIPMENT, RECEPTACLES AND CIRCUITRY BACK TO SOURCE.
  - 2.) DEMOLISH ALL FIRE ALARM DEVICES. EXISTING FIRE ALARM CIRCUITS TO BE RE-UTILIZED.
  - 3.) SEE DRAWING E-302 FOR DEMOLITION AND NEW WORK SITE PLAN FOR CLUBHOUSE UTILITY TRANSFORMER.

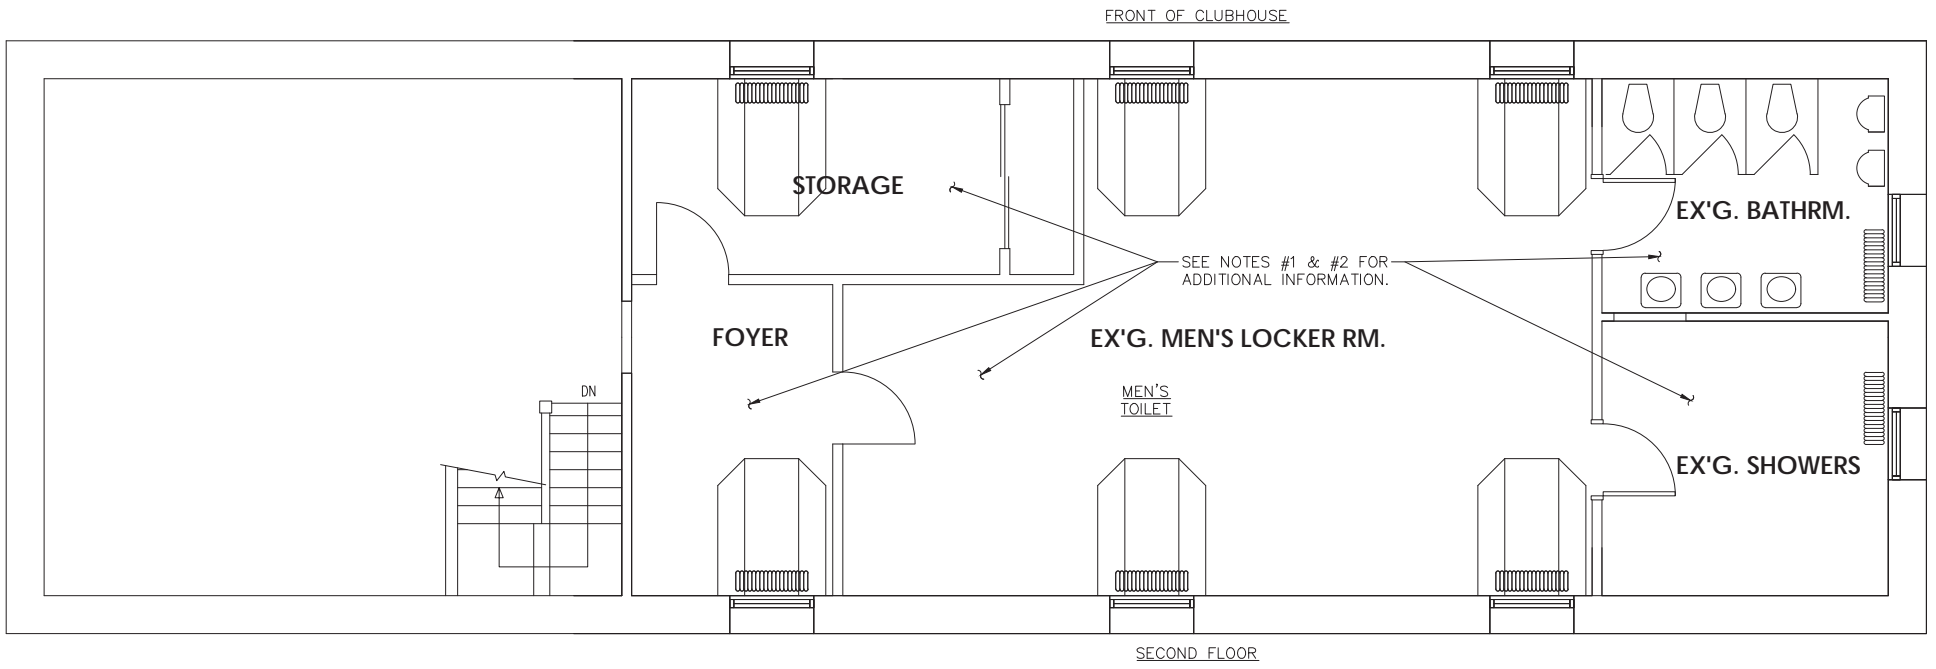

 2 CLUBHOUSE BATHROOMS & LOCKERS ELECTRICAL DEMOLITION PLAN  
SCALE: 1/4" = 1'-0"



 1 CLUBHOUSE BASEMENT ELECTRICAL ROOM DEMOLITION PLAN  
SCALE: 1/4" = 1'-0"

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DIVISION OF ENGINEERING			DIVISION OF ENGINEERING		
CONTRACT NUMBER 17-539			SHEET NUMBER E-102		
SHEET NO. 48 OF 59			SCALE: 1/4" = 1'-0"		
NEW GOLF CART STORAGE FACILITY AND CLUBHOUSE UPGRADES			DATE: 6/4/21		
MOHANSIC GOLF COURSE, YORKYOWN, NEW YORK			DPW FILE NO.		
CLUBHOUSE BATHRMS & LOCKERS ELEC. DEMOLITION PLAN			10-02-E-81-0		
			REV. NO. 0		

LIGHTING SYSTEM FUNCTIONAL TESTING/COMMISSIONING

I. FUNCTIONAL TESTING

PRIOR TO PASSING FINAL INSPECTION, THE CONTRACTOR SHALL PROVIDE EVIDENCE TO THE BUILDING OWNER AND THE ENGINEER THAT THE LIGHTING CONTROL SYSTEMS HAVE BEEN TESTED TO ENSURE THAT CONTROL HARDWARE AND SOFTWARE ARE CALIBRATED, ADJUSTED, PROGRAMMED AND IN PROPER WORKING CONDITION IN ACCORDANCE WITH THE CONSTRUCTION DOCUMENTS AND MANUFACTURER'S DOCUMENTS. FUNCTIONAL TESTING, FOR THE APPLICABLE CONTROL TYPE, SHALL BE IN ACCORDANCE WITH THE FOLLOWING:

1. OCCUPANT SENSOR CONTROLS

WHERE OCCUPANT SENSOR CONTROLS ARE PROVIDED, THE FOLLOWING PROCEDURES SHALL BE PERFORMED:

- CERTIFY THAT THE OCCUPANT SENSOR HAS BEEN LOCATED AND AIMED IN ACCORDANCE WITH MANUFACTURER RECOMMENDATIONS.
- FOR PROJECTS WITH SEVEN OR FEWER OCCUPANT SENSORS, EACH SENSOR SHALL BE TESTED.
- FOR PROJECTS WITH MORE THAN SEVEN OCCUPANT SENSORS, TESTING SHALL BE DONE FOR EACH UNIQUE COMBINATION OF SENSOR TYPE AND SPACE GEOMETRY. WHERE MULTIPLES OF EACH UNIQUE COMBINATION OF SENSOR TYPE AND SPACE GEOMETRY ARE PROVIDED, NOT LESS THAN 10 PERCENT, BUT IN NO CASE LESS THAN ONE, OF EACH COMBINATION SHALL BE TESTED UNLESS THE BUILDING OFFICIAL OR DESIGN PROFESSIONAL REQUIRES A HIGHER PERCENTAGE TO BE TESTED. WHERE 30 PERCENT OR MORE OF THE TESTED CONTROLS FAIL, ALL REMAINING IDENTICAL COMBINATIONS SHALL BE TESTED.

FOR OCCUPANT SENSOR CONTROLS TO BE TESTED, VERIFY THE FOLLOWING:

- WHERE OCCUPANT SENSOR CONTROLS INCLUDE STATUS INDICATORS, VERIFY CORRECT OPERATION.
- THE CONTROLLED LIGHTS TURN OFF OR DOWN TO THE PERMITTED LEVEL WITHIN THE REQUIRED TIME.
- FOR AUTO-ON OCCUPANT SENSOR CONTROLS, THE LIGHTS TURN ON TO THE PERMITTED LEVEL WHEN AN OCCUPANT ENTERS THE SPACE.
- FOR MANUAL-ON OCCUPANT SENSOR CONTROLS, THE LIGHTS TURN ON ONLY WHEN MANUALLY ACTIVATED.
- THE LIGHTS ARE NOT INCORRECTLY TURNED ON BY MOVEMENT IN ADJACENT AREAS OR BY HVAC OPERATION.

2. TIME-SWITCH CONTROLS

WHERE TIME-SWITCH CONTROLS ARE PROVIDED, THE FOLLOWING PROCEDURES SHALL BE PERFORMED:

- CONFIRM THAT THE TIME-SWITCH CONTROL IS PROGRAMMED WITH ACCURATE WEEKDAY, WEEKEND AND HOLIDAY SCHEDULES.
- PROVIDE DOCUMENTATION TO THE OWNER OF TIME-SWITCH CONTROLS PROGRAMMING INCLUDING WEEKDAY, WEEKEND, HOLIDAY SCHEDULES, AND SET-UP AND PREFERENCE PROGRAM SETTINGS.
- VERIFY THE CORRECT TIME AND DATE IN THE TIME SWITCH.
- VERIFY THAT ANY BATTERY BACK-UP IS INSTALLED AND ENERGIZED.
- VERIFY THAT THE OVERRIDE TIME LIMIT IS SET TO NOT MORE THAN 2 HOURS.
- SIMULATE OCCUPIED CONDITION. VERIFY AND DOCUMENT THE FOLLOWING:
  - ALL LIGHTS CAN BE TURNED ON AND OFF BY THEIR RESPECTIVE AREA CONTROL SWITCH.
  - THE SWITCH ONLY OPERATES LIGHTING IN THE ENCLOSED SPACE IN WHICH THE SWITCH IS LOCATED.
- SIMULATE UNOCCUPIED CONDITION. VERIFY AND DOCUMENT THE FOLLOWING:
  - NONEXEMPT LIGHTING TURNS OFF.
  - MANUAL OVERRIDE SWITCH ALLOWS ONLY THE LIGHTS IN THE ENCLOSED SPACE WHERE THE OVERRIDE SWITCH IS LOCATED TO TURN ON OR REMAIN ON UNTIL THE NEXT SCHEDULED SHUTOFF OCCURS.

3. DAYLIGHT RESPONSIVE CONTROLS

WHERE DAYLIGHT RESPONSIVE CONTROLS ARE PROVIDED, THE FOLLOWING SHALL BE VERIFIED:

- CONTROL DEVICES HAVE BEEN PROPERLY LOCATED, FIELD CALIBRATED AND SET FOR ACCURATE SET POINTS AND THRESHOLD LIGHT LEVELS.
- DAYLIGHT CONTROLLED LIGHTING LOADS ADJUST TO LIGHT LEVEL SET POINTS IN RESPONSE TO AVAILABLE DAYLIGHT.
- THE CALIBRATION ADJUSTMENT EQUIPMENT IS LOCATED FOR READILY ACCESS ONLY BY AUTHORIZED PERSONNEL.

II. DOCUMENTATION REQUIREMENTS

THE DOCUMENTS DESCRIBED IN THIS SECTION SHALL BE PROVIDED TO THE BUILDING OWNER OR OWNER'S AUTHORIZED AGENT WITHIN 60 DAYS OF THE DATE OF RECEIPT OF THE CERTIFICATE OF OCCUPANCY.


- DRAWINGS:
  - AS-BUILT CONSTRUCTION DOCUMENTS, SHOWING THE LOCATION AND CATALOG NUMBER OF EACH PIECE OF EQUIPMENT.
- MANUALS: AN OPERATING AND MAINTENANCE MANUAL SHALL BE PROVIDED AND INCLUDE THE FOLLOWING:
  - NAME AND ADDRESS OF NOT LESS THAN ONE SERVICE AGENCY FOR INSTALLED EQUIPMENT.
  - A NARRATIVE OF HOW EACH SYSTEM IS INTENDED TO OPERATE, INCLUDING RECOMMENDED SET POINTS.
  - SUBMITTAL DATA INDICATING ALL SELECTED OPTIONS FOR EACH PIECE OF LIGHTING EQUIPMENT AND LIGHTING CONTROLS.
  - OPERATION AND MAINTENANCE MANUALS FOR EACH PIECE OF LIGHTING EQUIPMENT. REQUIRED ROUTINE MAINTENANCE ACTIONS, CLEANING AND RECOMMENDED RELAMPING SHALL BE CLEARLY IDENTIFIED.
  - A SCHEDULE FOR INSPECTING AND RECALIBRATING ALL LIGHTING CONTROLS.
- REPORT: A REPORT OF TEST RESULTS SHALL BE PROVIDED AND INCLUDE THE FOLLOWING.
  - RESULTS OF FUNCTIONAL PERFORMANCE TESTS.
  - DISPOSITION OF DEFICIENCIES FOUND DURING TESTING, INCLUDING DETAILS OF CORRECTIVE MEASURES USED OR PROPOSED.

LIGHTING CONTROL LEGEND

- LOW VOLTAGE WALL VACANCY SWITCH WITH CEILING MOUNTED TEMPERATURE & HUMIDITY OCCUPANCY SENSOR RATED FOR 0° F TO 185° F.
- LOW VOLTAGE WALL SWITCH WITH CEILING MOUNTED OCCUPANCY SENSOR.

NOTES:

1.) EXTERIOR LIGHTING SHALL BE CONTROLLED VIA PHOTOCELL AND OVERRIDE SWITCH.

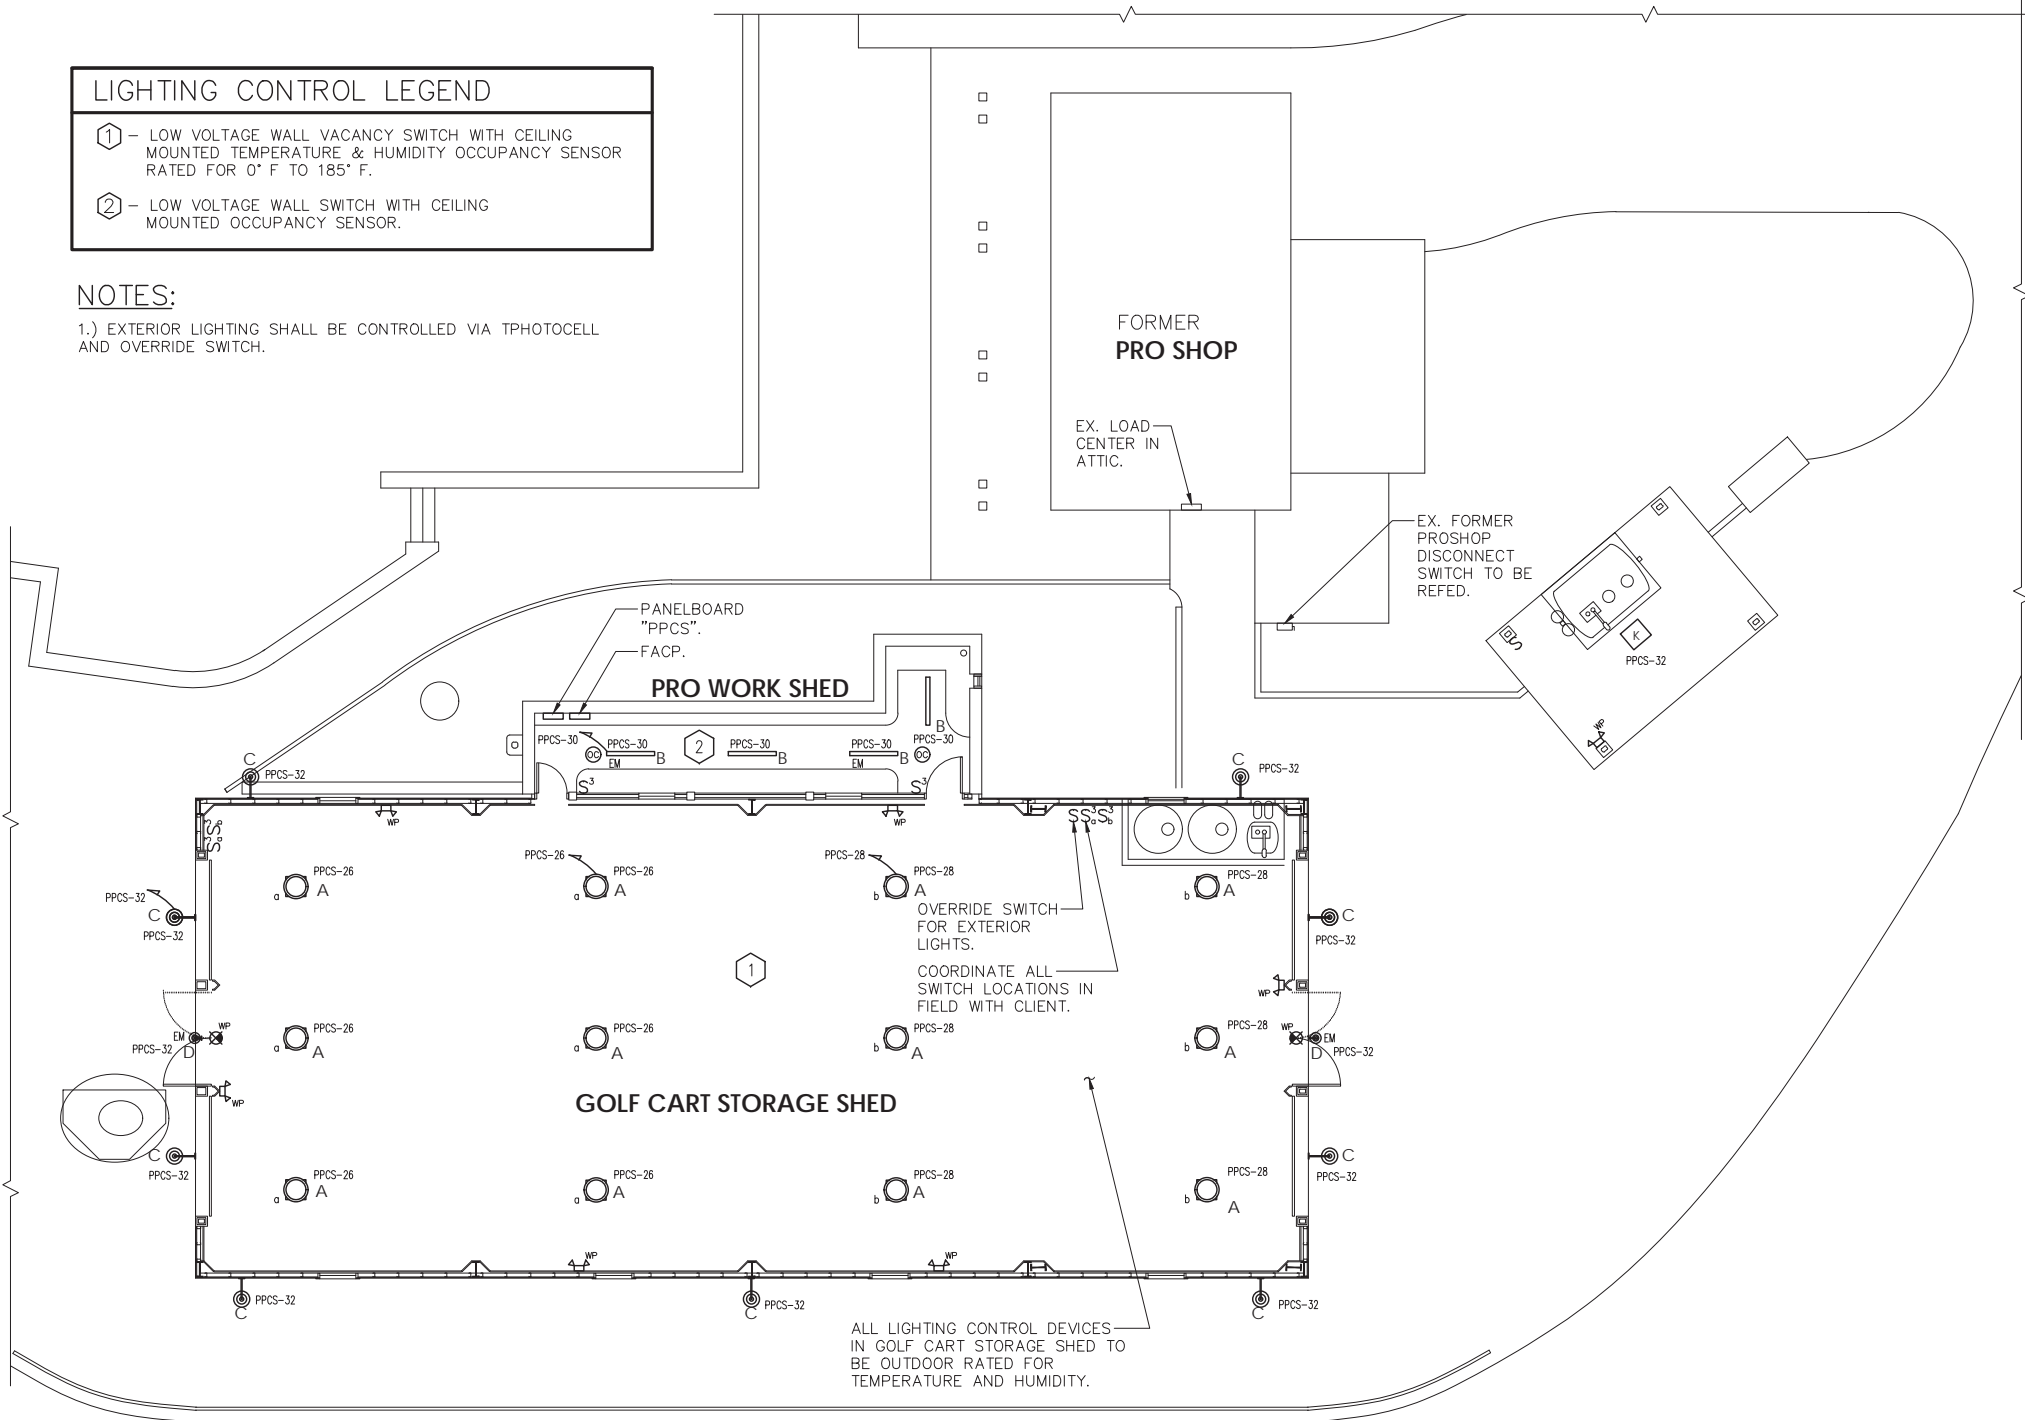

CART STORAGE SHED  
ELECTRICAL LIGHTING PLAN



SCALE: 1/8" = 1'-0"

DESIGN INTENT – LIGHTING CONTROL SYSTEM

- LIGHTING CONTROL SYSTEM IS BASED ON N-LIGHT BY SENSOR SWITCH (KAREN BLACKMAN (212) 462-0088 x5237) OR APPROVED EQUAL. (OTHER ACCEPTABLE MANUFACTURERS ARE LUTRON & COOPER LIGHTING.)
- LIGHTING CONTROL COMPONENTS SHOWN ARE FOR GENERAL DESIGN INTENT. ALL COMPONENTS AND WIRING ARE NOT SHOWN. CONTRACTOR SHALL BE RESPONSIBLE FOR ALL NECESSARY COMPONENTS, WIRING (LINE AND LOW VOLTAGE) AND PROGRAMMING FOR A FULLY OPERATIONAL SYSTEM.
- THE CONTRACTOR SHALL BE RESPONSIBLE TO COORDINATE LIGHTING CONTROLS WITH LIGHT FIXTURES.
- ALL LIGHT FIXTURE AND LIGHTING CONTROL SUBMITTALS SHALL BE SUBMITTED AT THE SAME TIME FOR APPROVAL.

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MADE BY CT


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DBA0006.00					
REVISION NUMBER	DATE	MADE BY	APP'D BY	REVISION	
RECORD DRAWING CERTIFICATION					
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CONTRACTOR			PROJECT COORDINATOR		
NAME SIGNATURE TITLE			NAME SIGNATURE TITLE		
DATE			DATE		
WESTCHESTER COUNTY, NEW YORK DEPARTMENT OF PUBLIC WORKS DIVISION OF ENGINEERING			CONTRACT NUMBER 17 - 539 SHEET NO. 49 OF 59		
NEW GOLF CART STORAGE FACILITY AND CLUBHOUSE UPGRADES MOHANSIC GOLF COURSE, YORKTOWN, NEW YORK CART STORAGE SHED ELEC. LIGHTING PLAN			SHEET NUMBER E-201 SCALE: 1/8" = 1'-0" DATE: 6/4/21 DPW FILE NO. 10-02-E-82-0 REV. NO. 0		



NOTES:

- 1.) ALL RECEPTACLES SHALL BE MOUNTED AT 3'-8" A.F.F. UON.  
2.) ALL SURFACE JUNCTION BOXES SHALL BE 1-1/2" DEEP.  
3.) REFER TO CARBTROL DRAWINGS FOR ADDITIONAL INFORMATION ON SYSTEM AND WIRING DIAGRAM.



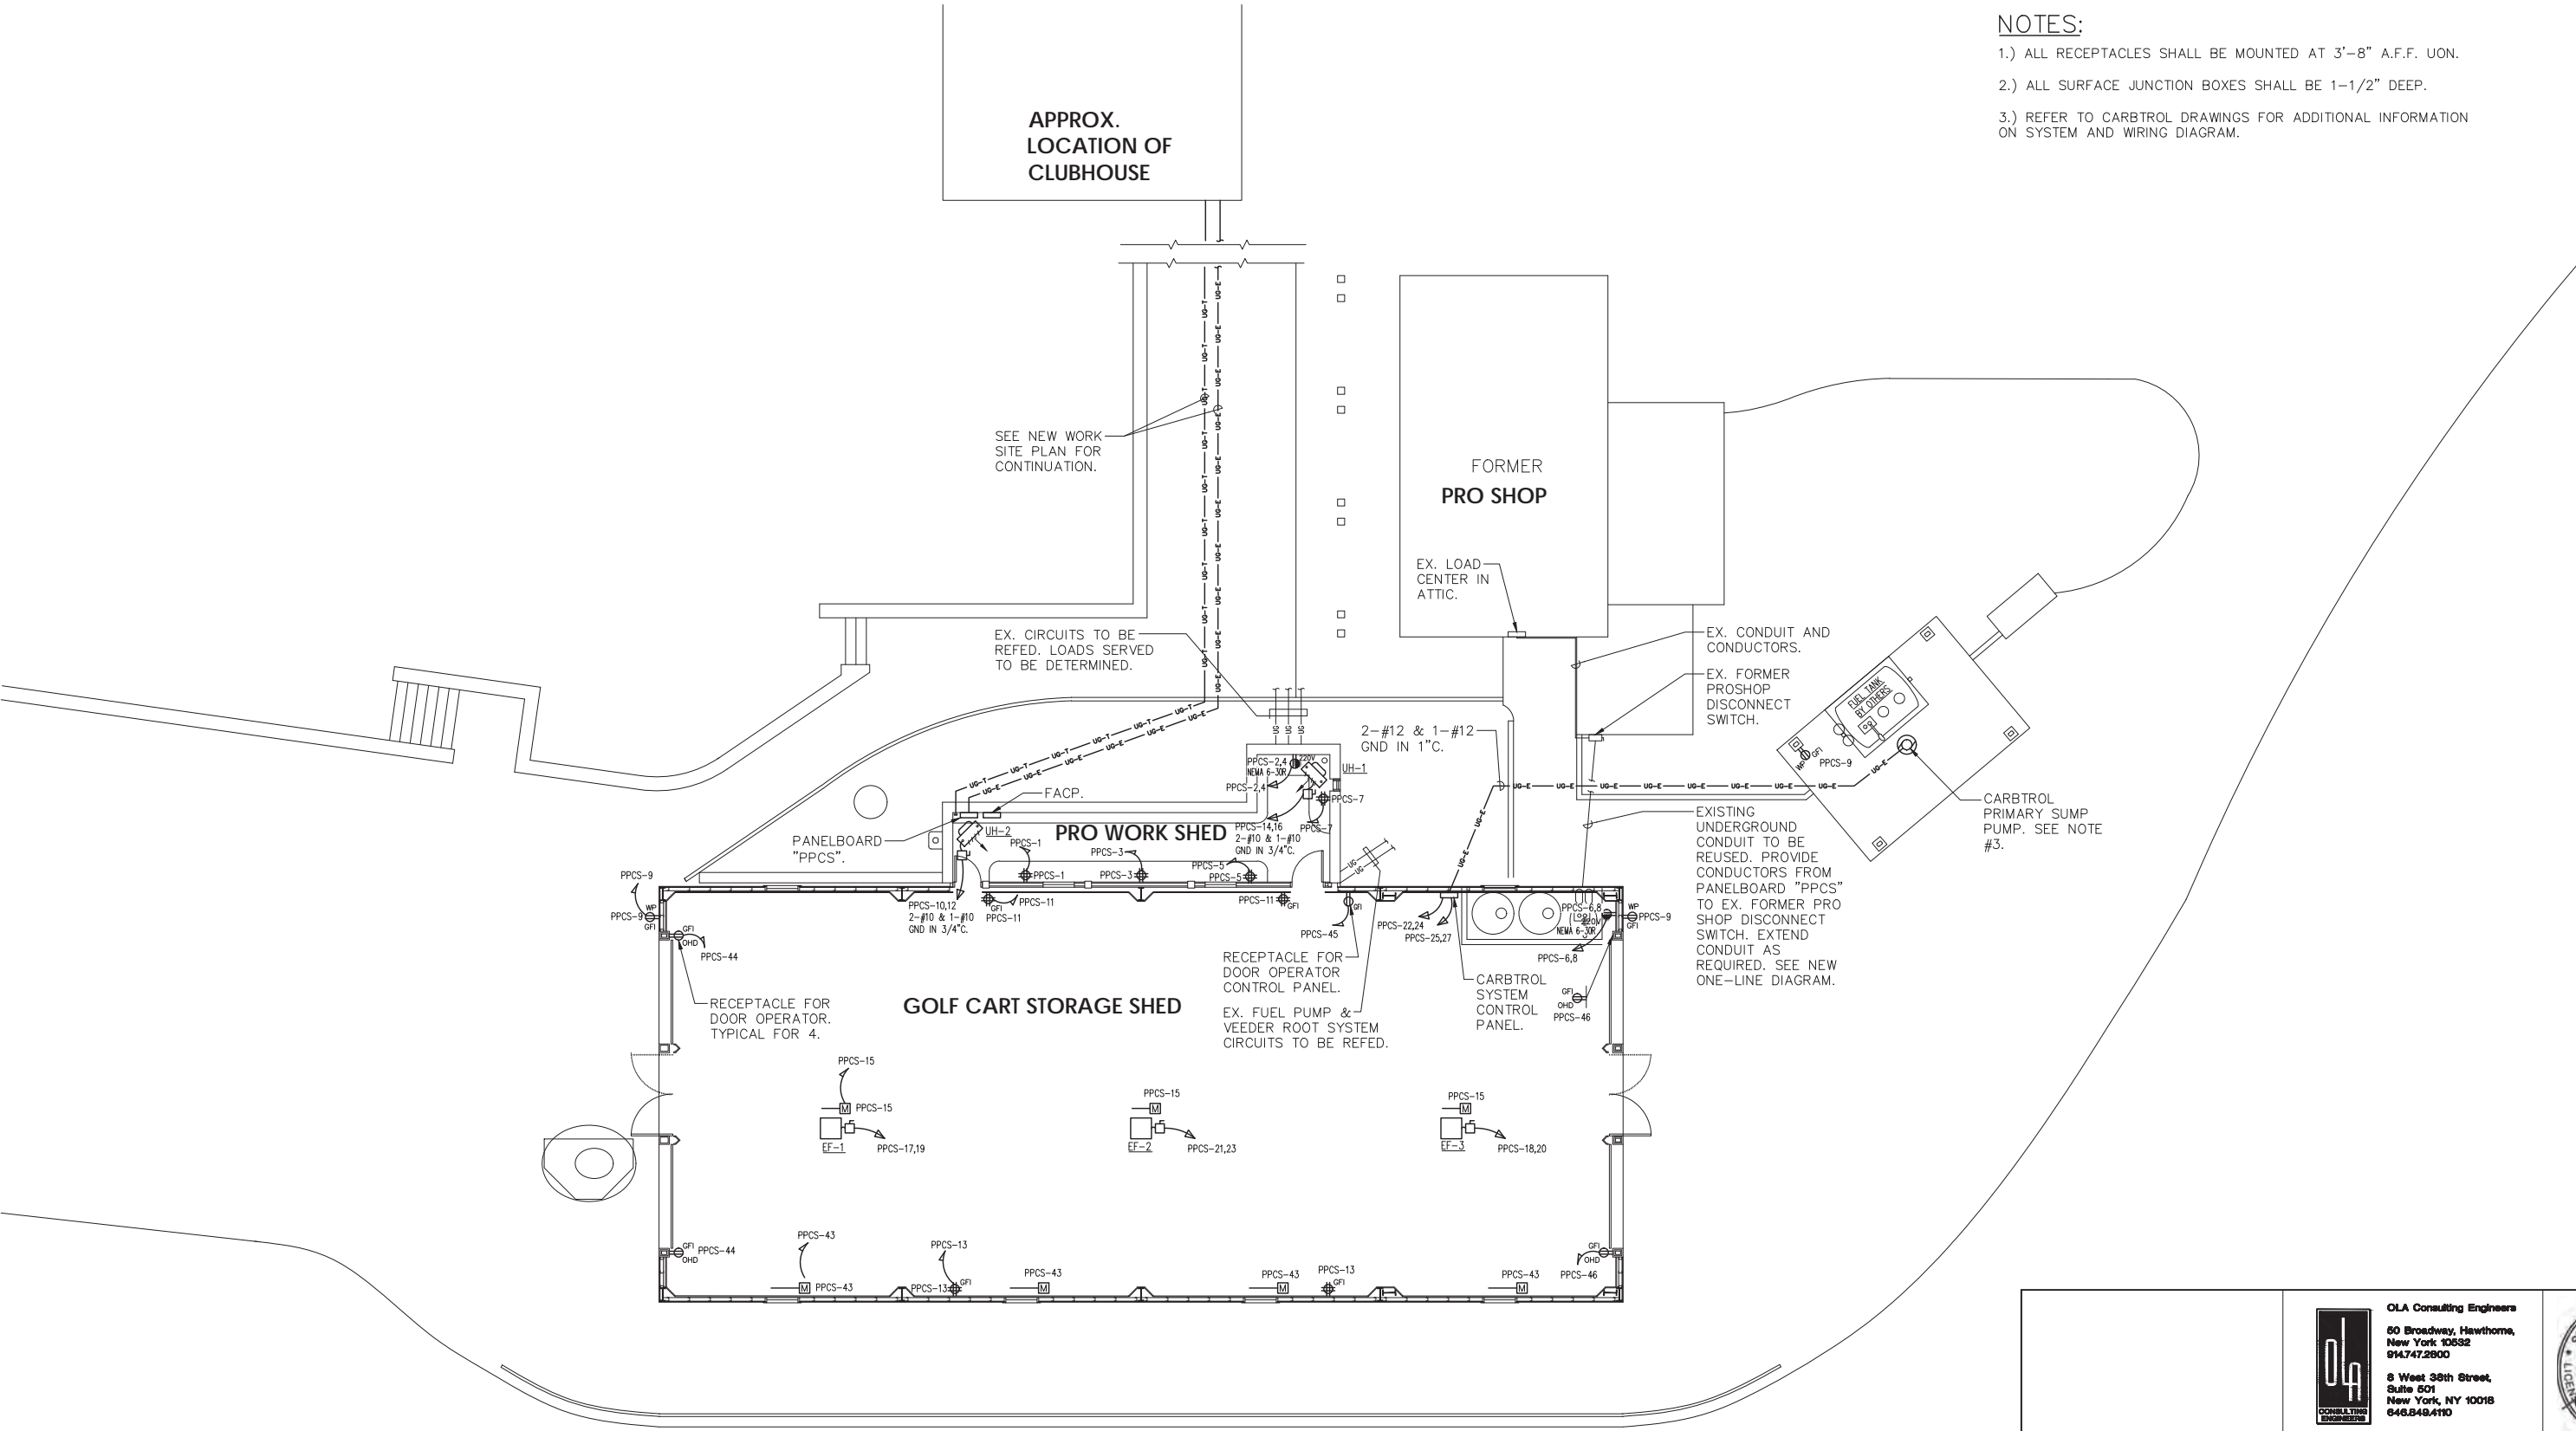


CART STORAGE SHED  
ELECTRICAL NEW WORK PLAN  
SCALE: 1/8" = 1'-0"



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CONTRACTOR		PROJECT COORDINATOR		
NAME SIGNATURE TITLE	DATE	NAME SIGNATURE TITLE	DATE	
WESTCHESTER COUNTY, NEW YORK DEPARTMENT OF PUBLIC WORKS DIVISION OF ENGINEERING		NEW GOLF CART STORAGE FACILITY AND CLUBHOUSE UPGRADES MOHANSIC GOLF COURSE, YORKYOWN, NEW YORK CART STORAGE SHED ELEC. NEW WORK PLAN		
CONTRACT NUMBER 17 - 539		SHEET NUMBER E-301		SCALE: 1/8" = 1'-0" DATE: 6/4/21
SHEET NO. 51 OF 59		DPW FILE NO. 10-02-E-84-0		REV. NO. 0




## CLUBHOUSE BATHROOMS & LOCKERS ELECTRICAL NEW WORK PLAN

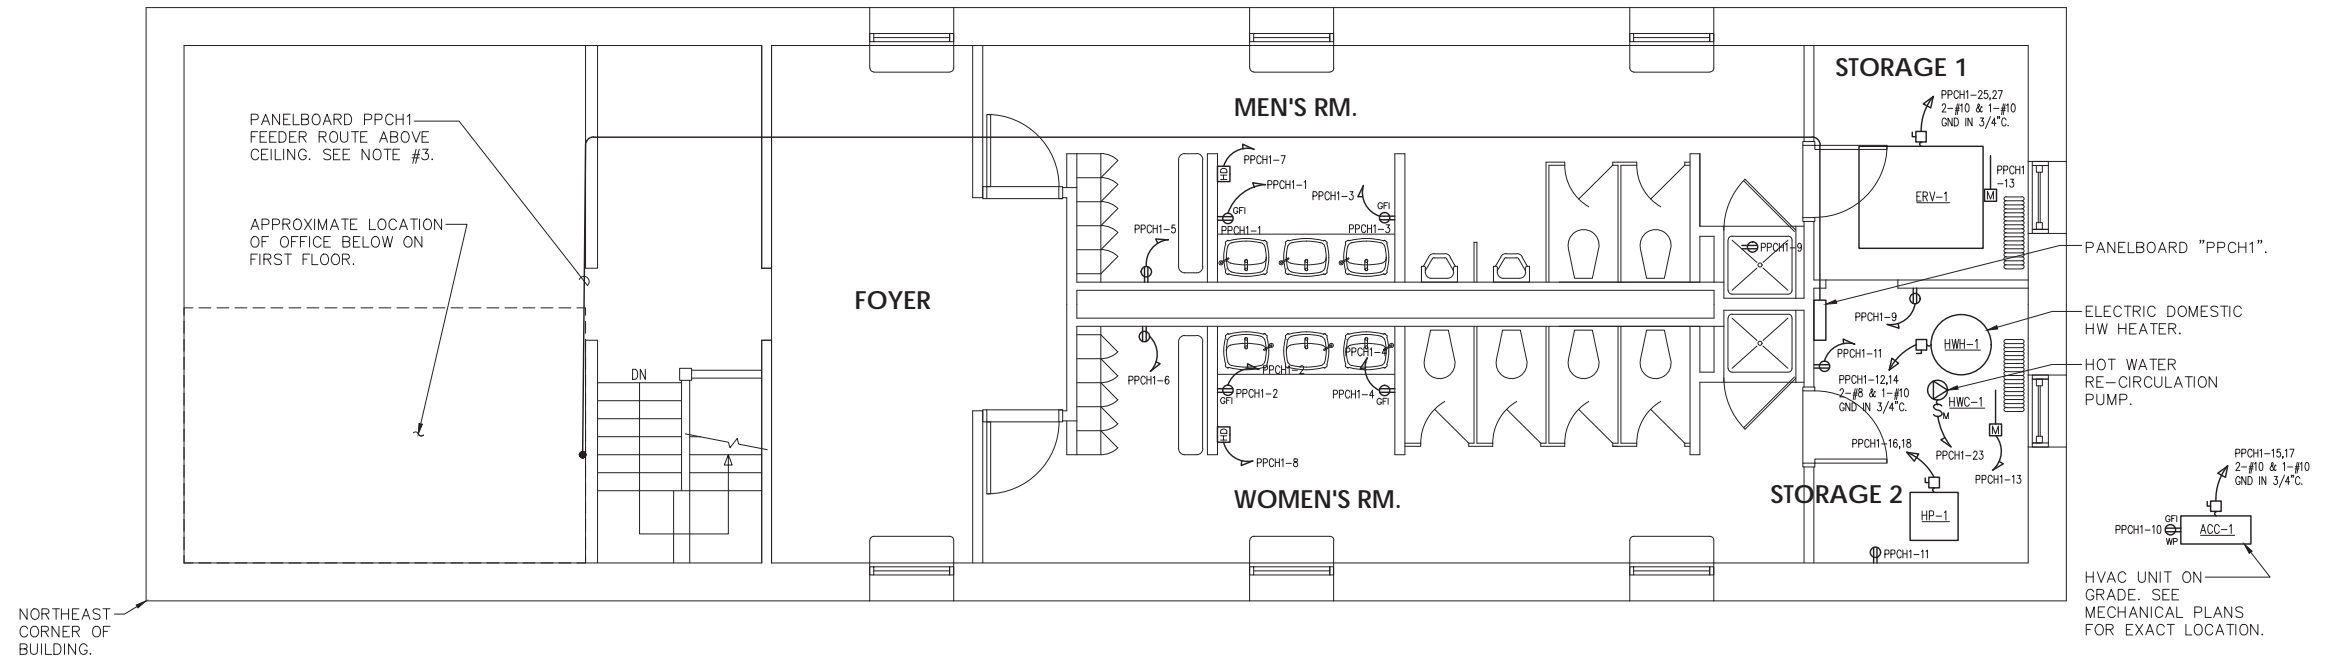SCALE: 1/4" = 1'-0"


### NOTES:

- 1.) ALL RECEPTACLES SHALL BE MOUNTED AT 3'-8" A.F.F.
- 2.) ALL SURFACE JUNCTION BOXES SHALL BE 1-1/2" DEEP.
- 3.) ROUTE FEEDER CONDUIT FOR PANELBOARD "PPCH1" UP FROM BASEMENT ALONG WALL OF OFFICE ABOVE TO SECOND FLOOR LEVEL. COORDINATE EXACT RISER LOCATION AND CONDUIT ROUTE IN THE FIELD WITH ARCHITECT.

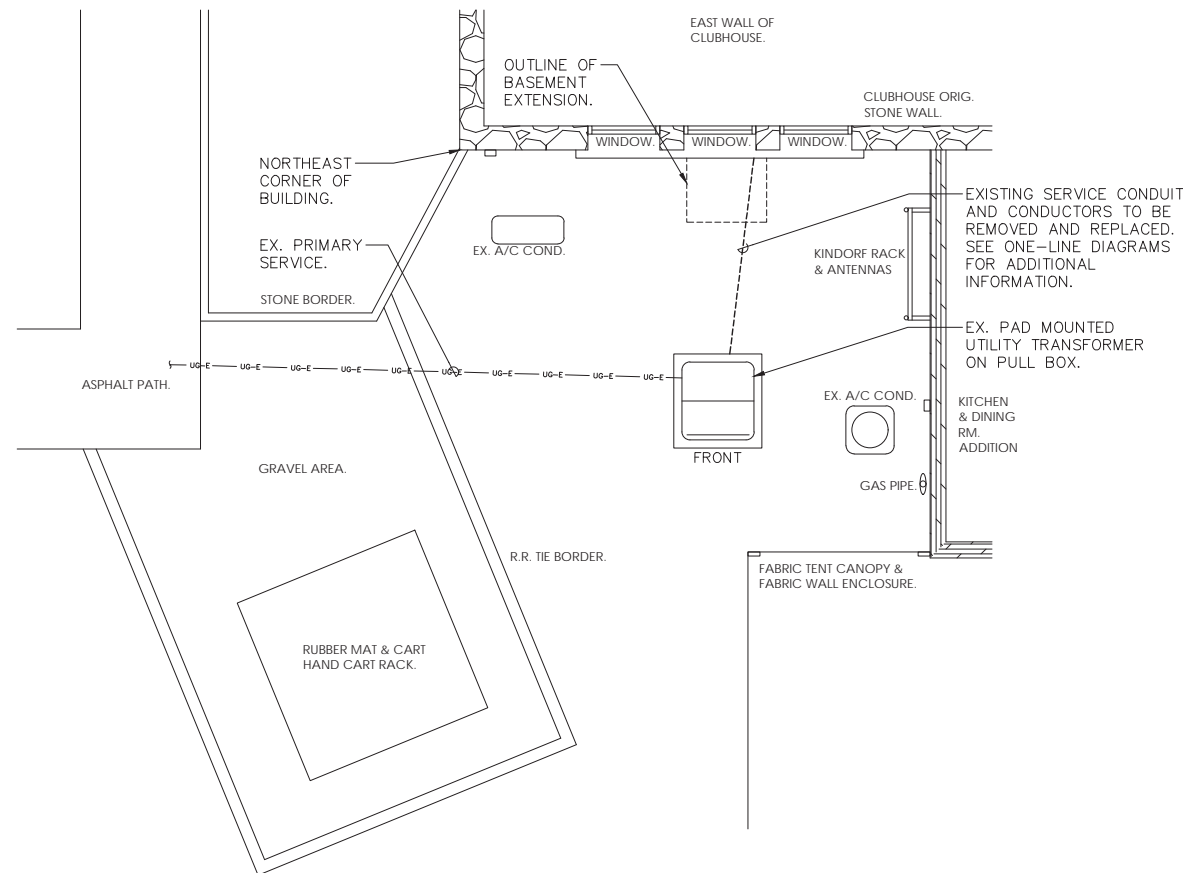

## ELECTRICAL SITE TRANSFORMER

PART PLAN  
SCALE: 1/4" = 1'-0"

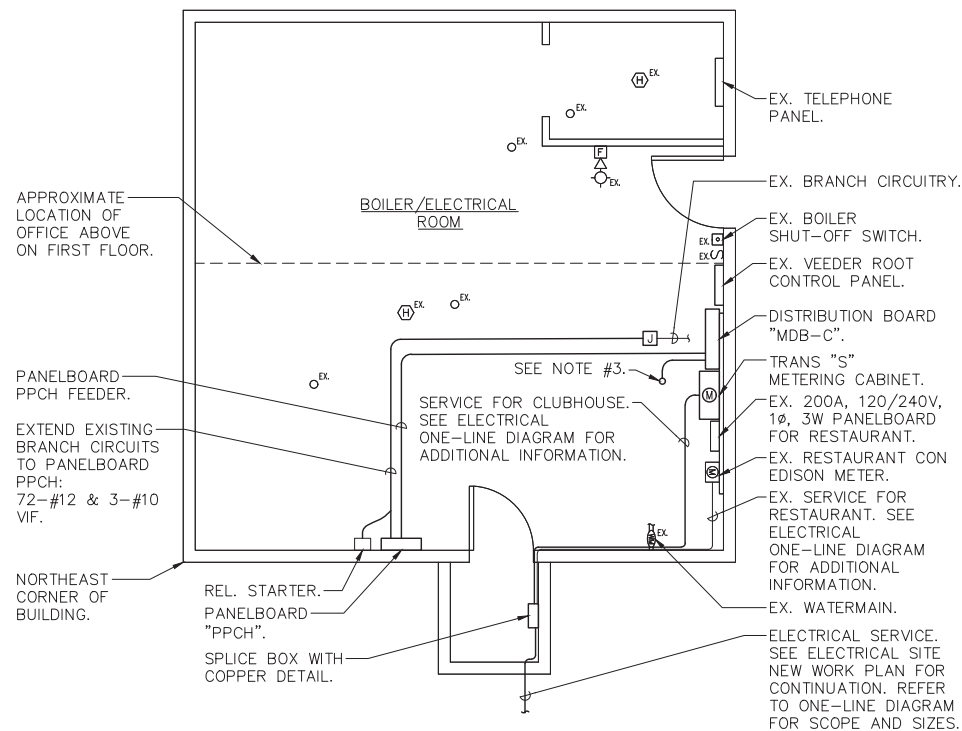

## CLUBHOUSE BASEMENT ELECTRICAL ROOM NEW WORK PLAN


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
FINAL ELECTRICAL SERVICE LAYOUT AND UTILITY TRANSFORMER SCOPE OF WORK IS PENDING CON EDISON APPROVAL.

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RECORD DRAWING CERTIFICATION					
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CONTRACTOR NAME SIGNATURE TITLE			PROJECT COORDINATOR NAME SIGNATURE TITLE		
WESTCHESTER COUNTY, NEW YORK DEPARTMENT OF PUBLIC WORKS DIVISION OF ENGINEERING			NEW GOLF CART STORAGE FACILITY AND CLUBHOUSE UPGRADES MOHANSIC GOLF COURSE, YORKTOWN, NEW YORK BATHRMS & LOCKERS ELEC. NEW WORK PLAN		
CONTRACT NUMBER 17-539		SHEET NUMBER E-302		SCALE: 1/4" = 1'-0" DATE: 6/4/21 DFW FILE NO. 10-02-E-85-0	
SHEET NO. 52 OF 59		REV. NO. 0			

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

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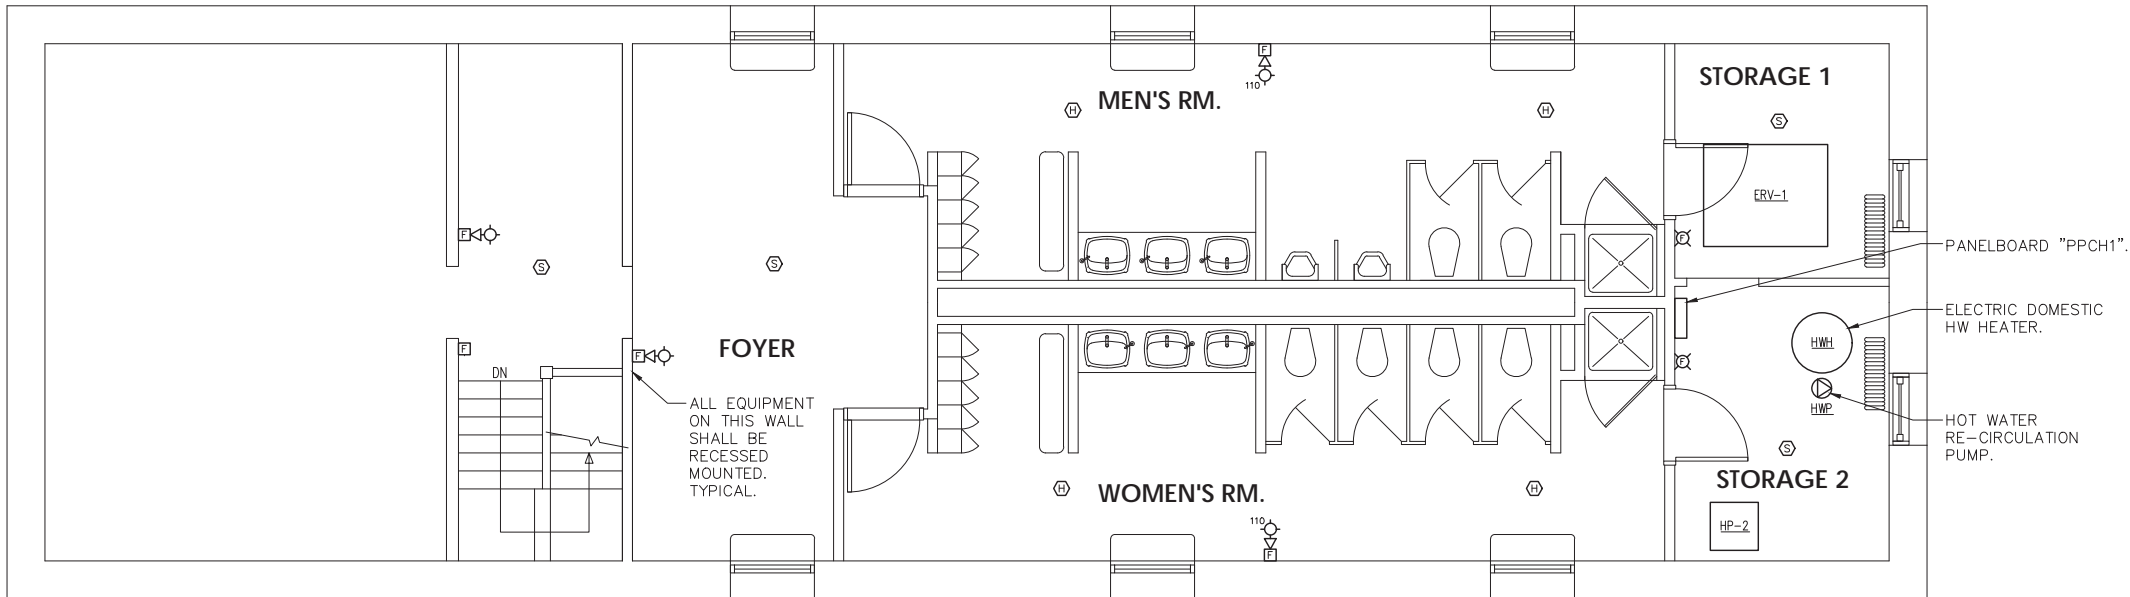


 **CART STORAGE SHED**  
**FIRE ALARM NEW WORK PLAN**  
SCALE: 1/8" = 1'-0"

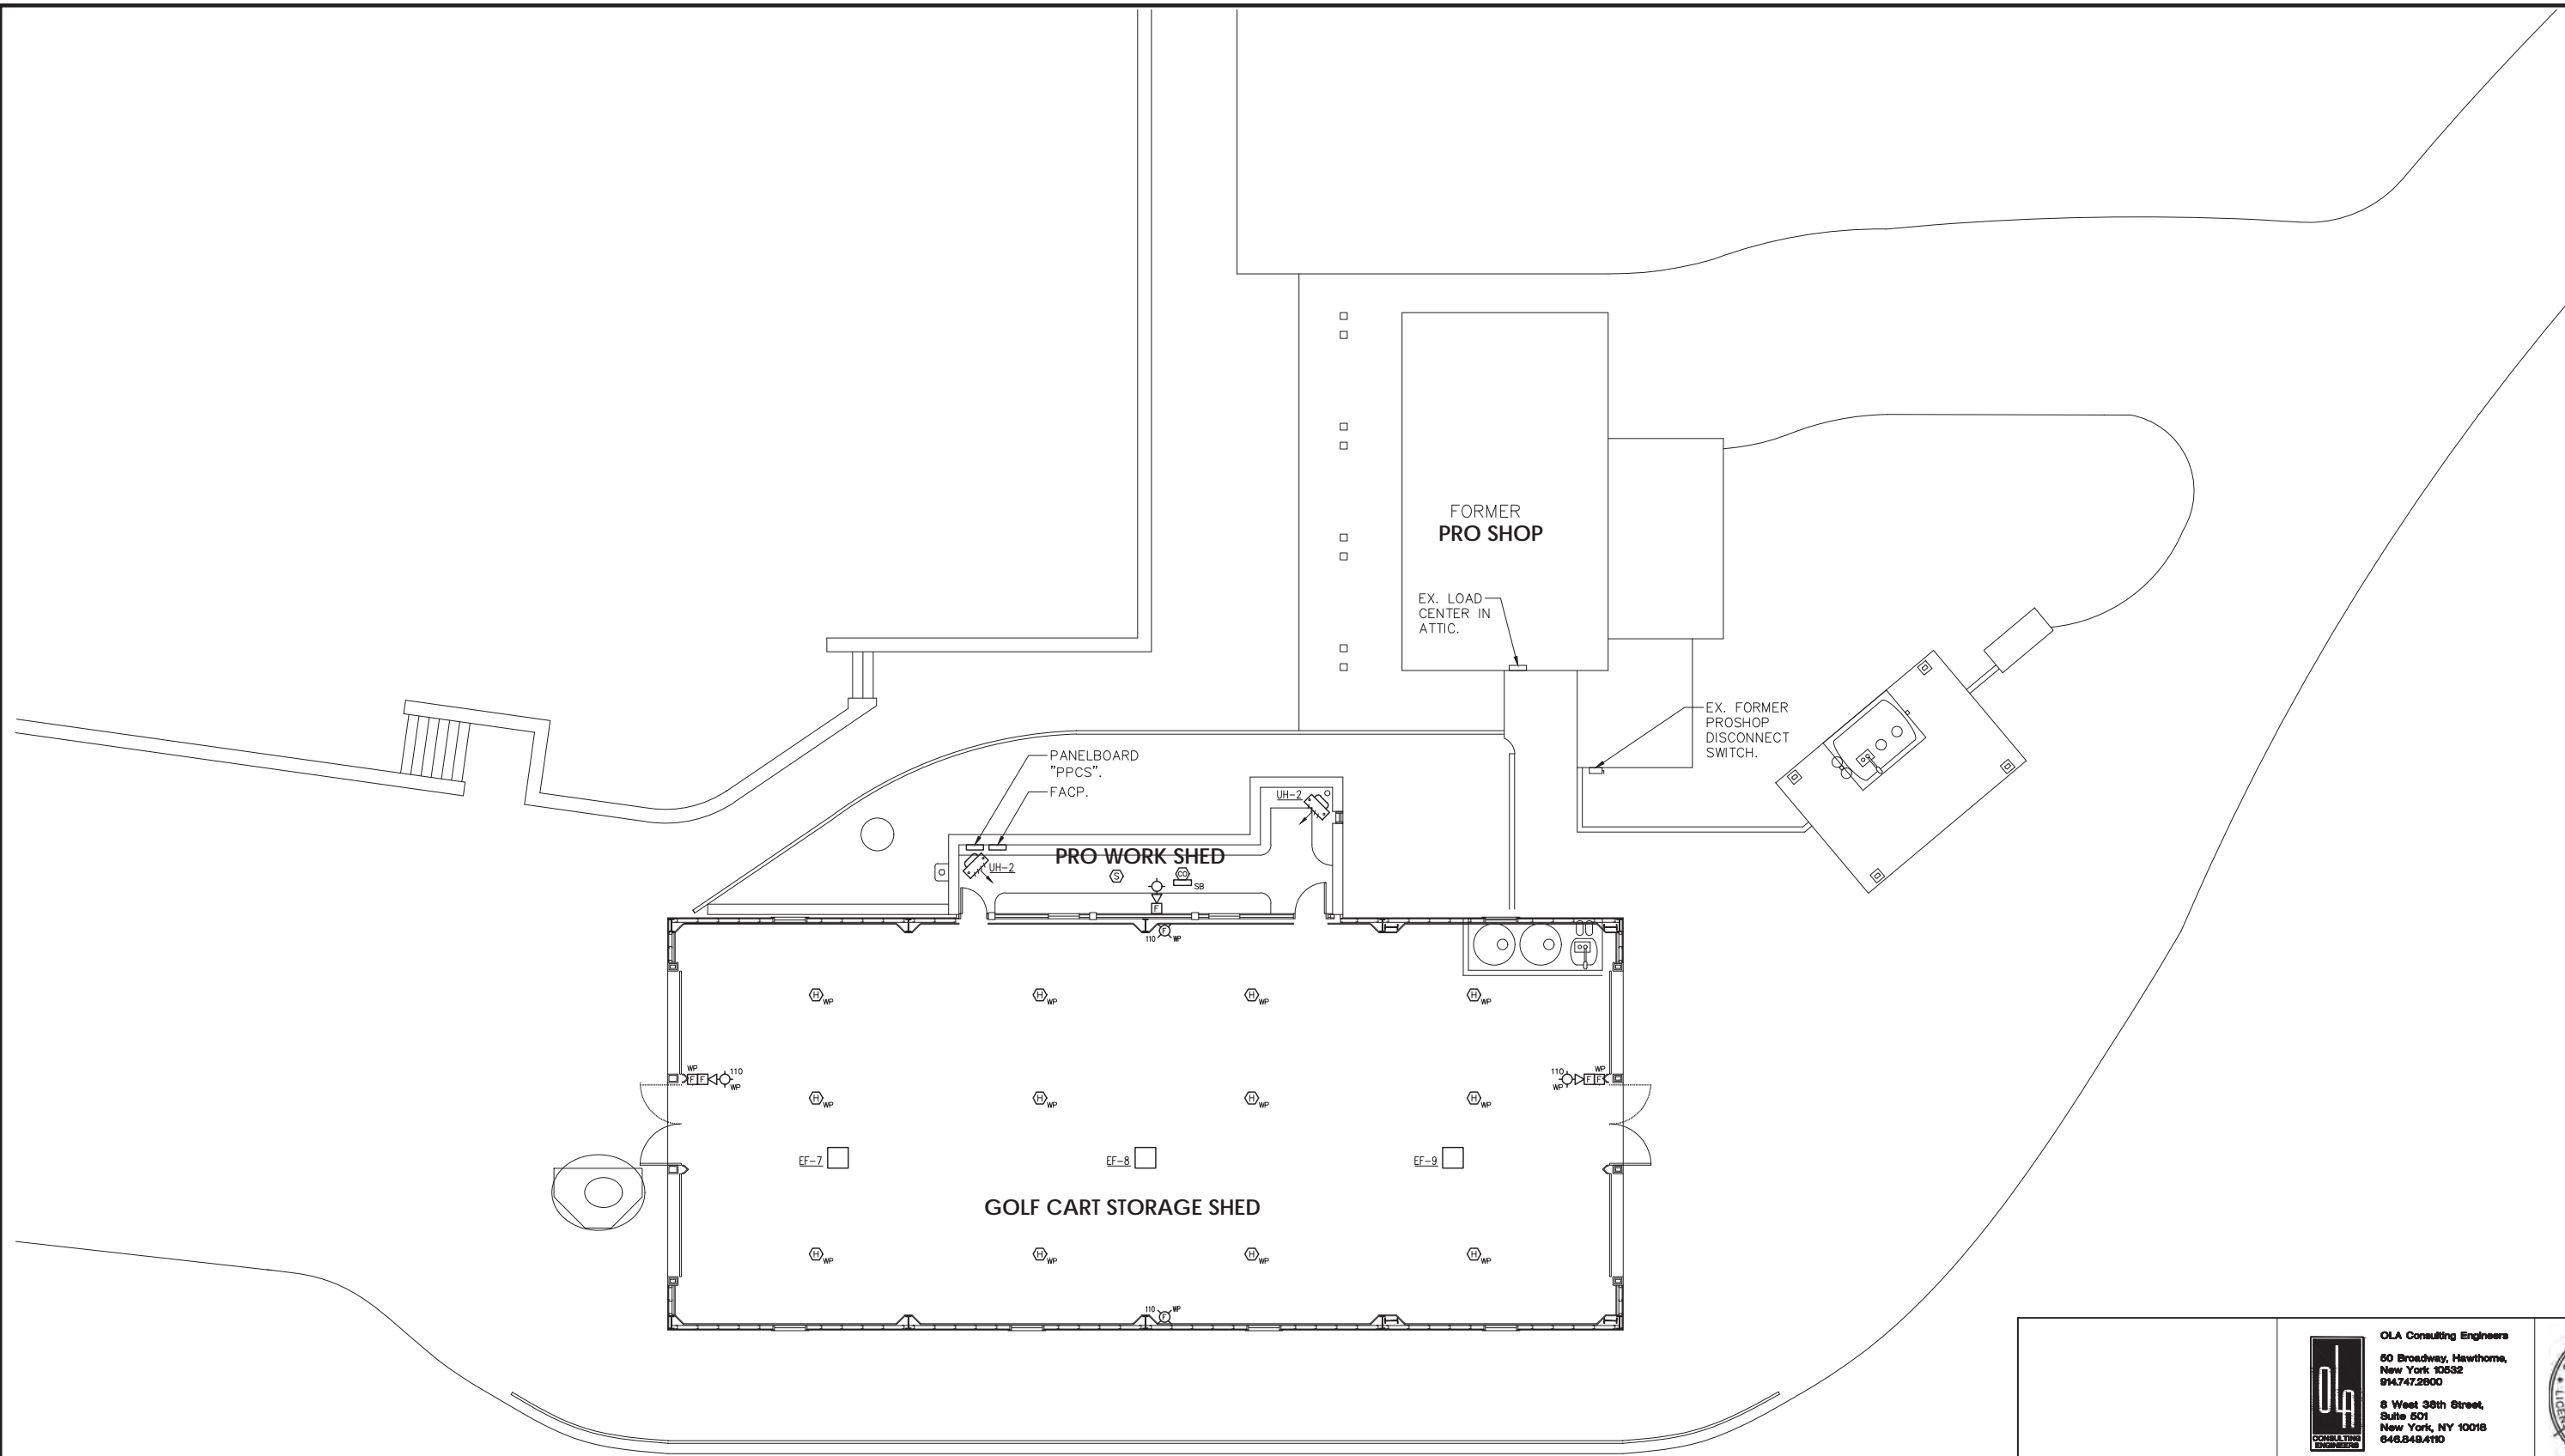
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MADE BY CT


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

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REVISION					
REVISION NUMBER	DATE	MADE BY	APP'D BY	REVISION	
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CONTRACTOR			PROJECT COORDINATOR		
NAME _____ SIGNATURE _____ TITLE _____			NAME _____ SIGNATURE _____ TITLE _____		
DATE _____			DATE _____		
WESTCHESTER COUNTY, NEW YORK			CONTRACT NUMBER 17 - 539		
DEPARTMENT OF PUBLIC WORKS			SHEET NUMBER E-401		
DIVISION OF ENGINEERING			SHEET NO. 53 OF 59		
NEW GOLF CART STORAGE FACILITY AND CLUBHOUSE UPGRADES			SCALE: 1/8" = 1'-0"		
MOHANSIC GOLF COURSE, YORKTOWN, NEW YORK			DATE: 6/4/21		
CART STORAGE SHED FIRE ALARM NEW WORK PLAN			DPW FILE NO. 10-02-E-86-0		
			REV. NO. 0		



 **2** CLUBHOUSE BATHROOMS & LOCKERS  
FIRE ALARM NEW WORK PLAN  
SCALE: 1/4" = 1'-0"

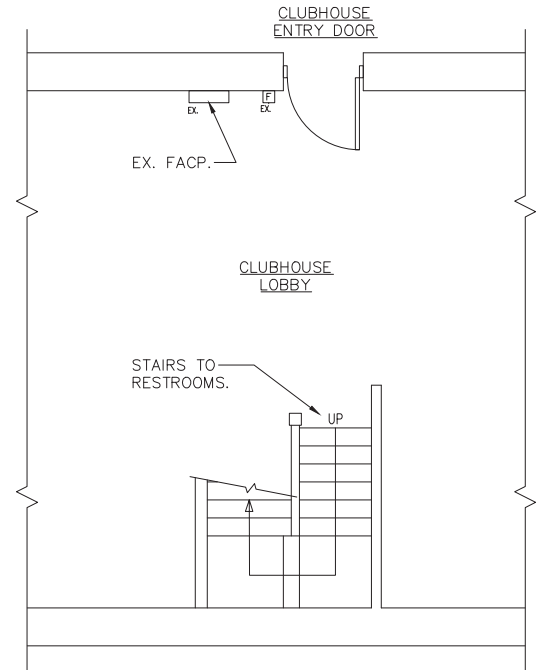


 **1** CLUBHOUSE GROUND FLOOR  
FIRE ALARM PART PLAN  
SCALE: 1/4" = 1'-0"

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REVISION					
REVISION NUMBER	DATE	MADE BY	APP'D BY	REVISION	
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DATE _____			DATE _____		
CONTRACT NUMBER			SHEET NUMBER		
17 - 539			E-402		
SHEET NO. 54 OF 59			SCALE: 1/4" = 1'-0" DATE: 6/4/21		
WESTCHESTER COUNTY, NEW YORK DEPARTMENT OF PUBLIC WORKS DIVISION OF ENGINEERING			NEW GOLF CART STORAGE FACILITY AND CLUBHOUSE UPGRADES MOHANSIC GOLF COURSE, YORKYOWN, NEW YORK BATHRMS & LOCKERS FIRE ALARM NEW WORK PLAN		
DPW FILE NO. 10-02-E-87-0			REV. NO. 0		

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## NOTES:

- 1.) ALL SWITCHES AND CIRCUIT BREAKERS ARE 2 POLE, U.O.N.
- 2.) ALL PRIMARY SERVICES ARE 2,400V, SINGLE PHASE.
- 3.) ALL SECONDARY SERVICES ARE 120/240V, SINGLE PHASE, 3 WIRE.
- 4.) PROVIDE DRAGLINES IN ALL SPARE CONDUITS.
- 5.) SEE CLUBHOUSE POWER PLAN FOR SCOPE OF WORK OF EXTENDING OF BRANCH CIRCUITRY.

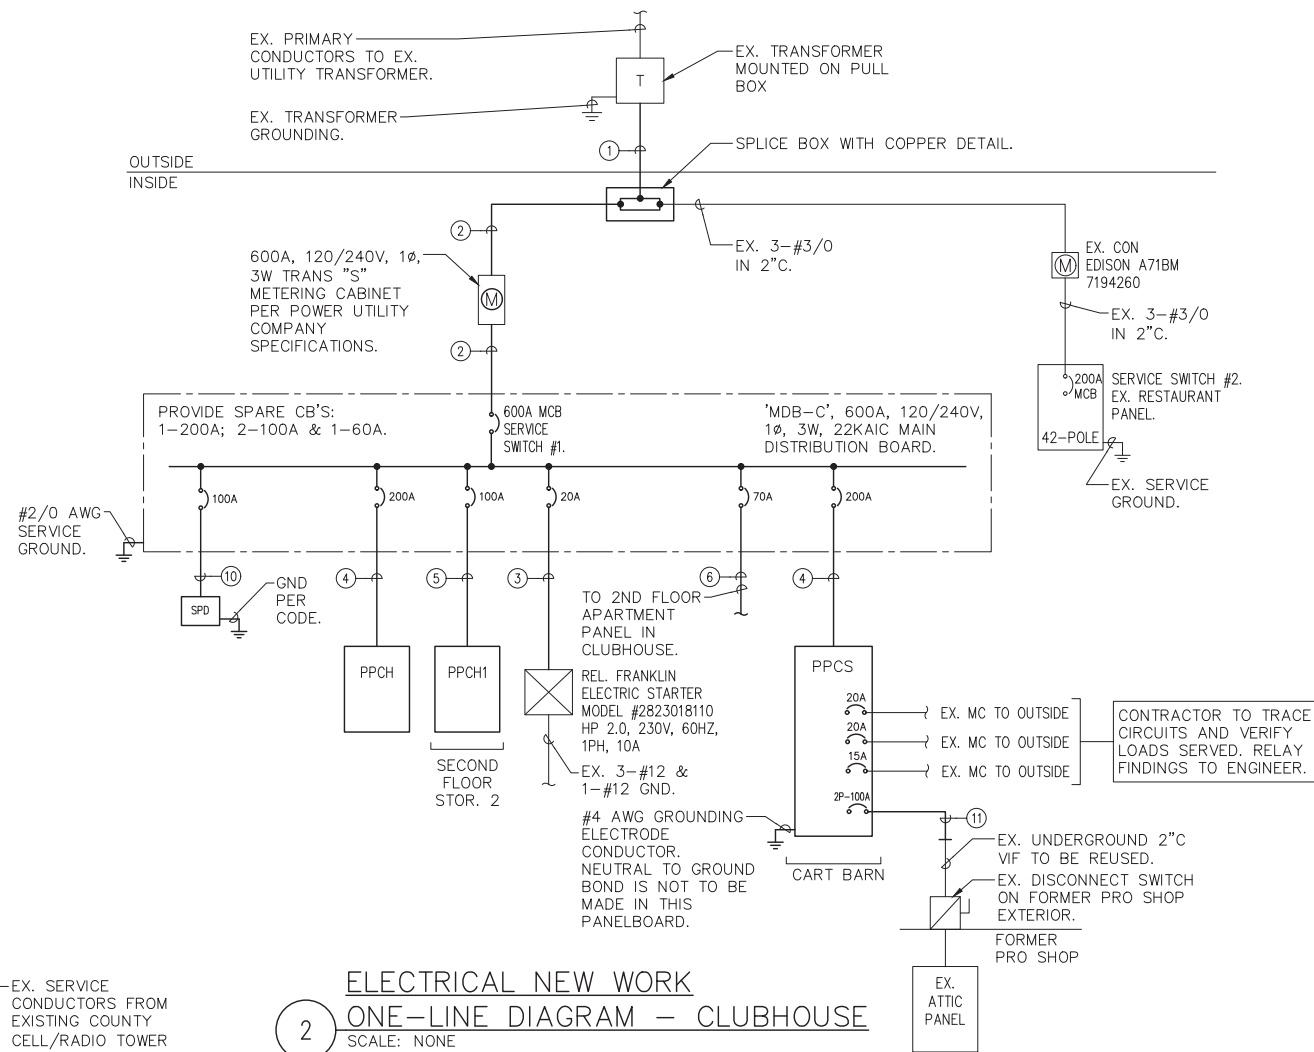
## WIRING/CONDUIT LEGEND:

- ① (2) SETS OF 3-#500MCM IN (2) 4" HDPE C (PLUS ONE SPARE).
- ② (2) SETS OF 3-#350MCM & 1-#2/0 GND IN (2) 3"C.
- ③ 3-#12 & 1-#12 GND IN 3/4"C.
- ④ 3-#3/0 & 1-#6 GND IN 2"C.
- ⑤ 3-#2 & 1-#8 GND IN 1-1/4"C.
- ⑥ 3-#4 & 1-#8 GND IN 1-1/4"C.
- ⑦ (2) SETS OF 3-#500MCM IN (3) 4" HDPE C (ONE SPARE CONDUIT CAPPED AT METER LOCATION).
- ⑧ (2) SETS OF 3-#500MCM & 1-#2/0 GND IN (2) 4" HDPE C.
- ⑨ 3-#4 & 1-#10 GND IN 2"C.
- ⑩ 5-#2 IN 1-1/4"C.
- ⑪ 3-#2 & 1-#8 GND IN 2"C.

FINAL ELECTRICAL SERVICE LAYOUT AND UTILITY TRANSFORMER SCOPE OF WORK IS PENDING CON EDISON APPROVAL.

## ELECTRICAL NEW WORK ONE-LINE DIAGRAM - CLUBHOUSE

SCALE: NONE

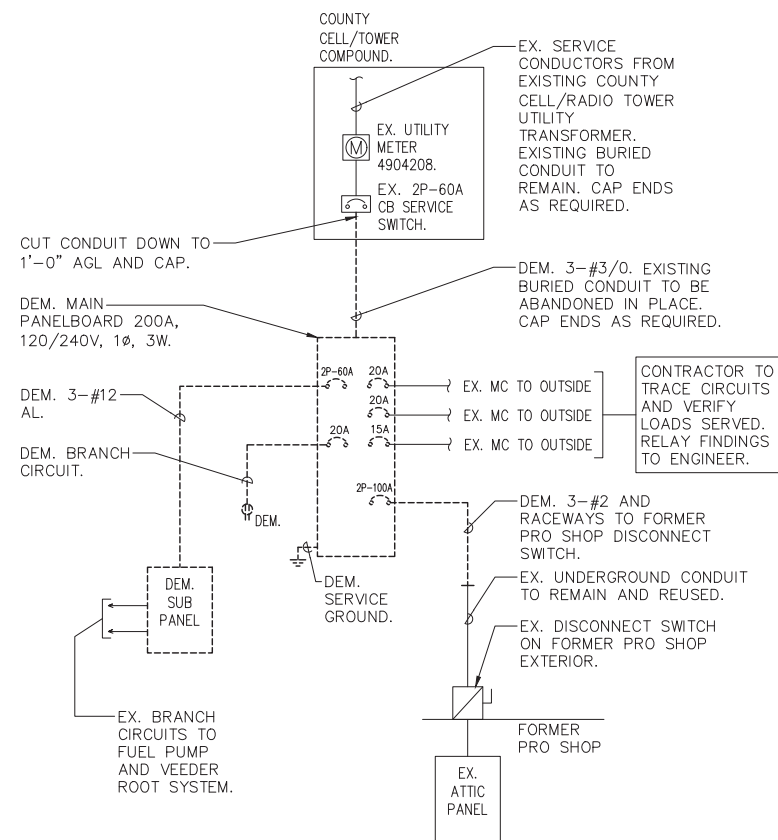


## ELECTRICAL DEMOLITION ONE-LINE DIAGRAM - CLUBHOUSE

SCALE: NONE

## NOTE:

- 1.) SEE CLUBHOUSE NEW WORK ONE-LINE DIAGRAM FOR RE-FEEDING OF PRO SHOP PANELBOARD AND EXTERIOR CIRCUITS.

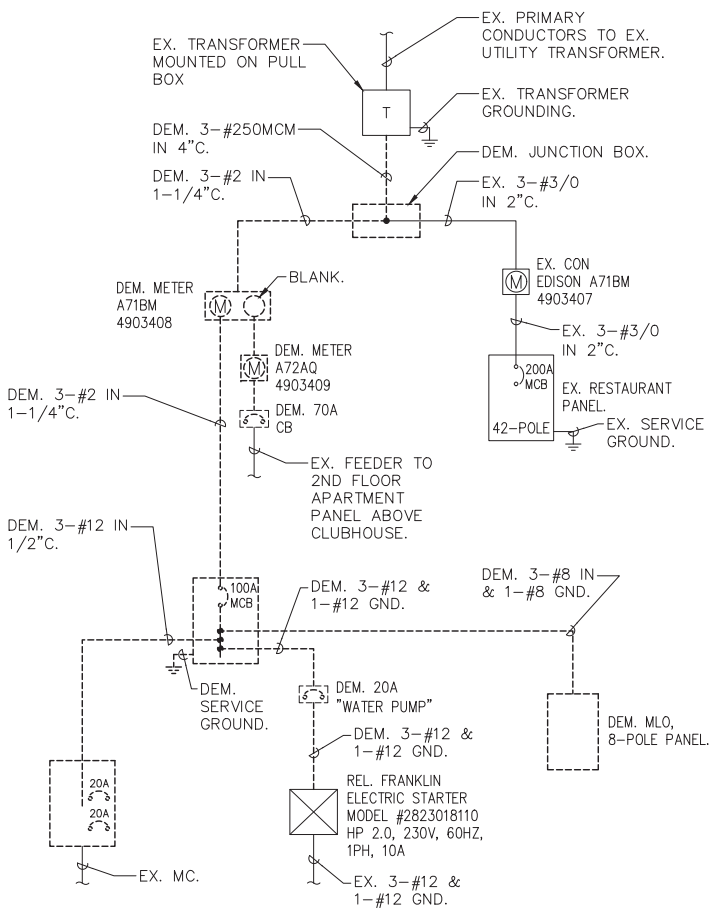


## ELECTRICAL DEMOLITION ONE-LINE DIAGRAM - CLUBHOUSE

SCALE: NONE

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REVISION NUMBER	DATE	MADE BY	APP'D BY	REVISION	
RECORD DRAWING CERTIFICATION					
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CONTRACTOR			PROJECT COORDINATOR		
NAME			NAME		
SIGNATURE			SIGNATURE		
TITLE	DATE		TITLE	DATE	
WESTCHESTER COUNTY, NEW YORK				CONTRACT NUMBER	SHEET NUMBER
DEPARTMENT OF PUBLIC WORKS				17-539	E-501
DIVISION OF ENGINEERING				SHEET NO. 55 OF 59	
NEW GOLF CART STORAGE FACILITY AND CLUBHOUSE UPGRADES				SCALE: NONE	
MOHANSIC GOLF COURSE, YORKYOWN, NEW YORK				DATE: 6/4/21	
ELECTRICAL ONE-LINE DIAGRAM				DPW FILE NO. 10-02-E-88-0	
				REV. NO. 0	

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1 FIRE ALARM RISER DIAGRAM  
SCALE: NONE



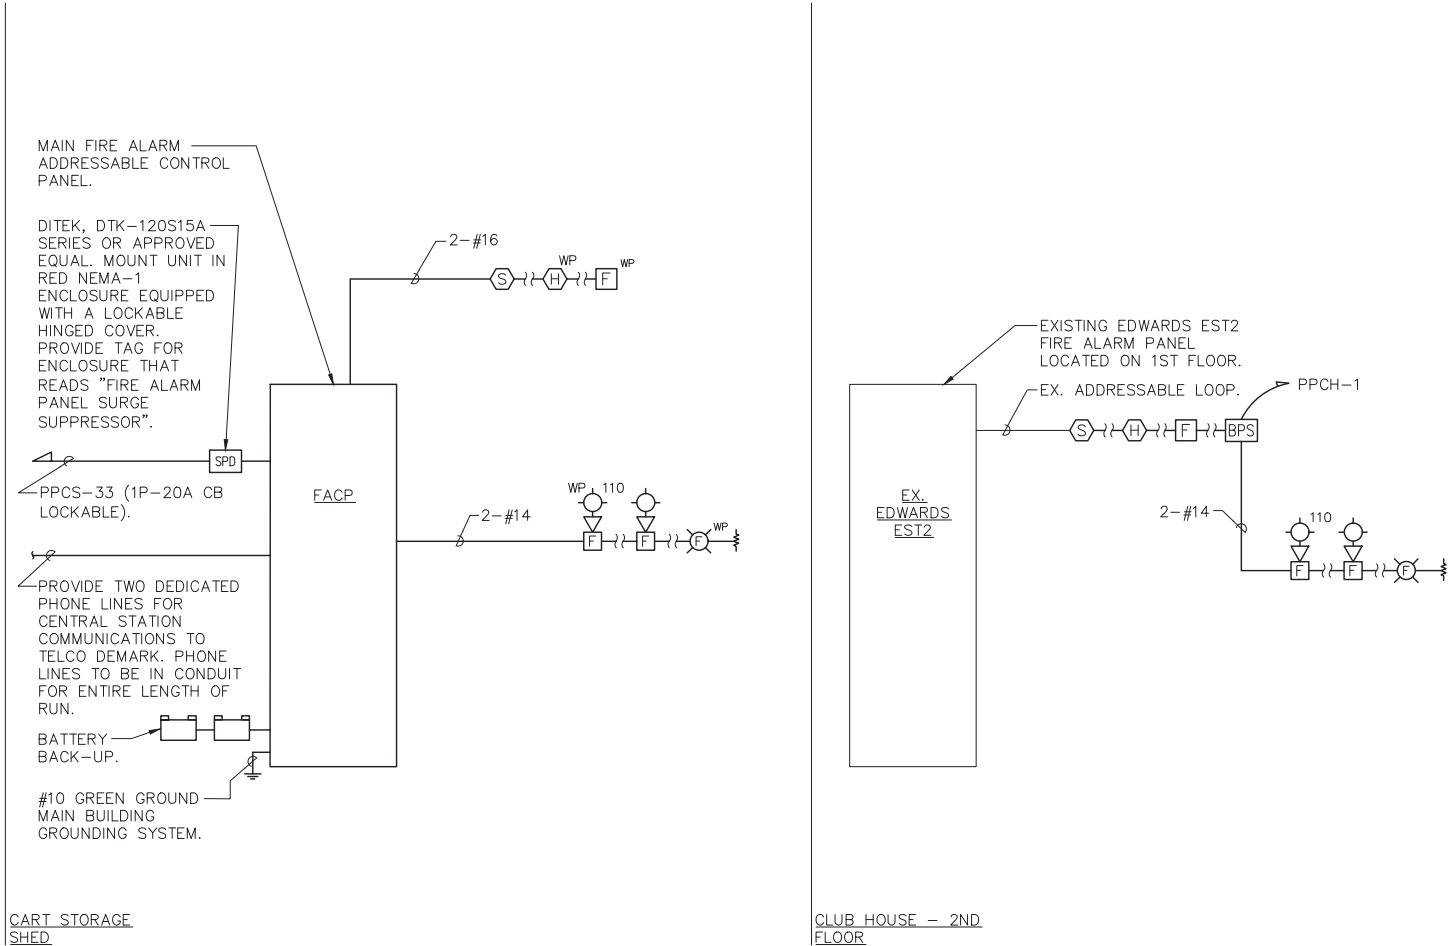









RISER NOTES:

- 1.) THIS IS NOT A POINT-TO-POINT WIRING DIAGRAM. PRIOR TO STARTING ANY WORK, A WORKING POINT-TO-POINT WIRING DIAGRAM SHALL BE OBTAINED FROM FIRE ALARM SYSTEM VENDOR AND PERFORM ALL WORK IN ACCORDANCE WITH THAT DIAGRAM.
- 2.) ELECTRICAL CONTRACTOR SHALL INCLUDE IN THE BASE BID ALL 120V CIRCUITS THAT ARE REQUIRED TO SUPPORT THE OPERATION OF THE FIRE ALARM SYSTEM. COORDINATE REQUIREMENTS WITH THE FIRE ALARM VENDOR.
- 3.) QUANTITY OF STROBE BOOSTER POWER SUPPLY PANELS AND ASSOCIATED 120V CIRCUITS SHALL BE COORDINATED WITH SELECTED FIRE ALARM SYSTEM MANUFACTURER AND/OR FIRE ALARM VENDOR.
- 4.) PROVIDE ALL NECESSARY WIRING, MODULES, COMPONENTS, EXTENDER CABINET, AND PROGRAMMING REQUIRED TO CONNECT NEW DEVICES TO EXISTING SYSTEM IN CLUBHOUSE.
- 5.) PROVIDE ALL NECESSARY HARDWARE AND PROGRAMMING TO PROVIDE THE CLIENT WITH 20% SPARE CAPACITY ON ALL INITIATING AND INDICATING CIRCUITS.
- 6.) PROVIDE AS PART OF THE BASE CONTRACT ALL LABOR AND MATERIALS TO INSTALL FIFTEEN (15) ADDITIONAL FIRE ALARM DEVICES DURING CONSTRUCTION. THE ADDITIONAL FIRE ALARM DEVICES CAN BE BUT NOT LIMITED TO SMOKE DETECTOR, HEAT DETECTOR, DOOR HOLDER, DUCT DETECTOR, FAN SHUTDOWN, TAMPER SWITCHES, FLOW SWITCHES, ETC. INCLUDE ALL LABOR AND MATERIALS INCLUDING WIRE, BOXES, CONDUIT, TERMINATIONS, HARDWARE, SOFTWARE, PROGRAMMING AND TESTING.
- 7.) ALL VISUAL ALARM DEVICES SHALL BE ADA COMPLIANT.
- 8.) PROVIDE REMOTE LED INDICATORS FOR ALL CONCEALED FIRE ALARM DEVICES SUCH AS DUCT SMOKE DETECTORS, ABOVE CEILING SMOKE DETECTORS, ELEVATOR SHAFT DETECTORS, MONITORING AND CONTROL MODULES, ETC. LED INDICATORS FOR DEVICES MOUNTED ABOVE DROP CEILINGS SHALL BE MOUNTED BELOW ASSOCIATED DEVICES. LABEL INDICATORS TO INDICATE DEVICE SERVED.
- 9.) CONTRACTOR TO PROVIDE SMOKE DETECTOR(S) IN ALL LOCATIONS CONTAINING FIRE ALARM CONTROL PANELS, DATA GATHERING PANELS, BOOSTER POWER SUPPLIES, OR ANY OTHER FIRE ALARM SYSTEM PANEL, WHETHER SHOWN ON PLANS OR NOT.
- 10.) BATTERY BACKUP FOR FACP SHALL PROVIDE A MINIMUM OF 24 HOURS OF STAND BY POWER FOLLOWED BY 45 MINUTES OF ALARM.

IN CHARGE OF JW  
CHECKED BY DS  
MADE BY CT

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				 OLA Consulting Engineers 60 Broadway, Hawthorne, New York 10632 914.747.2800 8 West 38th Street, Suite 501 New York, NY 10018 646.848.4190 ola.com	
DBA0006.00					
REVISION NUMBER	DATE	MADE BY	APP'D BY	REVISION	
RECORD DRAWING CERTIFICATION					
<input type="checkbox"/> AS BUILT - CHANGES AS NOTED <input type="checkbox"/> AS BUILT - NO CHANGES					
CONTRACTOR NAME _____ SIGNATURE _____ TITLE _____			PROJECT COORDINATOR NAME _____ SIGNATURE _____ TITLE _____		
CONTRACT NUMBER 17 - 539		DATE 6/4/21		SHEET NUMBER E-502	
WESTCHESTER COUNTY, NEW YORK DEPARTMENT OF PUBLIC WORKS DIVISION OF ENGINEERING		SHEET NO. 56 OF 59			
NEW GOLF CART STORAGE FACILITY AND CLUBHOUSE UPGRADES MOHANSIC GOLF COURSE, YORKYOWN, NEW YORK FIRE ALARM RISER DIAGRAM		SCALE: NONE DATE: 6/4/21 DPW FILE NO. 10-02-E-89-0		REV. NO. 0	

LIGHTING FIXTURE SCHEDULE						
FIXTURE DESIGNATION	MANUFACTURER	CATALOG NUMBER	LAMPS	VOLTS	MOUNTING	REMARKS
 A	HUBBELL LIGHTING	UTB-4K-OP16-MO-1-ND-GR-CDL	(1) 168W LED	120V	SURFACE	16" DIAMETER STEM MOUNTED HIGH-BAY LED FIXTURE WITH OPAL PRISMATIC ACRYLIC REFRACTOR, ENCLOSED WITH CONICAL DROPPED BOTTOM LENS.
 B	MERCURY LIGHTING	LW14-4-3800-30K-HTA-UNI-SR-EM10	(1) 32W LED	120V	SURFACE	4' SURFACE MOUNTED LED LINEAR STRIP. PROVIDE EM BATTERY PACK OPTION FOR 90 MINUTES OF BATTERY BACKUP AS REQUIRED.
 C	ANP LIGHTING	W516-MO21LD-N-W-30K-RTC-WM35-51	(1) 25W LED	120V	SURFACE	16" EXTERIOR WALL MOUNTED FIXTURE WITH ALUMINUM SHADE , BRONZE FINISH AND ALUMINUM WALL MOUNT.
 D	ANP LIGHTING	LA600-2-FR-M009LD-N-T5-30K-EMG-51	(1) 11W LED	120V	SURFACE	EXTERIOR WALL MOUNTED JELLY JAR WITH CAST ALUMINUM HOUSING, BRONZE FINISH AND CAGED FROSTED GLASS GLOBE LENS. PROVIDE EM BATTERY PACK OPTION FOR 90 MINUTES OF BATTERY BACKUP AS REQUIRED.
	OCL LIGHTING	SC1-P1AA-16-WG-PBR-LED1/30K-UNV-34-EMI	(1) 20W LED	120V	PENDANT	16" LED PENDANT/STEM MOUNTED SCHOOLHOUSE FIXTURE WITH OPAL/WHITE GLASS GLOBE. PROVIDE EM BATTERY PACK OPTION FOR 90 MINUTES OF BATTERY BACKUP AS REQUIRED.
 H	REJUVINATION LIGHTING	A2505 MELLOW	(1) 23W CFL GU24 BASE	120V	PENDANT	18" DIAMETER 3 HOOK/PENDANT MOUNTED SUSPENDED FIXTURE, SATIN BRASS FINISH WITH OPAL/WHITE GLASS GLOBE.
 I	REJUVINATION LIGHTING	A8805 TURNER	(1) 60W INC.	120V	SURFACE	WALL MOUNTED SCONCE WITH J HOOK ARM, SATIN BRASS FINISH WITH OPAL/WHITE GLASS GLOBE.
 K	RAB LIGHTING	VANLED10	(1) 13W LED	120V	SURFACE	SURFACE MOUNTED CANOPY LIGHT FIXTURE SUITABLE FOR WET LOCATIONS.
	DUAL LITE	LXURWE	LED	120V	SURFACE	EXIT SIGN WITH 90 MINUTES OF BATTERY BACKUP TIME, MIN., RED LETTERING ON WHITE BACKGROUND, WHITE THERMO PLASTIC HOUSING, SEALED NICKEL CADMIUM BATTERY. PROVIDE CHEVRONS AS INDICATED ON DRAWINGS.
 WP	SURE-LITES	UMX SERIES	(2) F6T5 (NORMAL) (2) 6W, DC (EMERGENCY)	120V	SURFACE	EXIT SIGN WITH 90 MINUTES OF BATTERY BACKUP TIME, MIN. RED LETTERING ON WHITE BACKGROUND, CORROSION RESISTANT FIBERGLASS HOUSING, WET LOCATION LABELED, 6 VOLT SEALED NICKEL CADMIUM BATTERIES. PROVIDE CHEVRONS AS INDICATED ON DRAWINGS.
 E	SURE-LITES	AA8	(2) 7.2W PAR36	120V	SURFACE	WALL MOUNTED EMERGENCY BATTERY LIGHT FIXTURE WITH 90 MINUTES OF BATTERY BACKUP TIME, MIN., STEEL HOUSING, WHITE FINISH, 6 VOLT SEALED NICKEL CADMIUM BATTERY.
 WP	LIGHTONIA LIGHTING	IND618-W-ULT	(2) 9W KRYPTON	120V	SURFACE	WALL MOUNTED EMERGENCY BATTERY LIGHT FIXTURE WITH 90 MINUTES OF BATTERY BACKUP TIME, MIN., INJECTION-MOLDED THERMOPLASTIC HOUSING, 6 VOLT LEAD ACID BATTERY, RATED FOR OUTDOOR USE -40°F TO 131°F.

NOTES:

- 1.) VERIFY ALL FIXTURE CATALOG NUMBERS FOR INTENDED APPLICATIONS WITH REQUIRED ACCESSORIES.  
2.) ALL FLUORESCENT FIXTURES SHALL CONTAIN HIGH EFFICIENCY ELECTRONIC BALLASTS AND SHALL HAVE A TOTAL HARMONIC DISTORTION (THD) OF 10% OR LESS.  
3.) ALL BALLASTS IN FIXTURES LOCATED OUTDOORS SHALL BE ZERO DEGREE RATED STARTING TEMPERATURE. REFER TO DRAWINGS FOR LOCATION OF FIXTURES.  
4.) LIGHT FIXTURES INDICATED AS EMERGENCY (EM) ON DRAWINGS SHALL CONTAIN AN EMERGENCY BATTERY BACK-UP BALLAST WHERE POSSIBLE THE BALLAST SHALL BE INTERNAL TO FIXTURE WITH A VISUAL INDICATING CHARGE LAMP AND TEST SWITCH. IF IT IS NOT POSSIBLE TO INSTALL THE EMERGENCY BATTERY BALLAST IN THE FIXTURE, THE CONTRACTOR SHALL FURNISH & INSTALL A REMOTE EMERGENCY BALLAST. EACH BATTERY PACK SHALL BE CONNECTED SO THAT THE FIXTURE CAN BE SWITCHED UNDER NORMAL CONDITIONS AND IN THE EVENT OF A POWER OUTAGE, THE BATTERY PACK AND FLUORESCENT LAMPS SHALL AUTOMATICALLY ILLUMINATE FOR 90 MINUTES WITH A 1200 LUMEN OUTPUT (TOTAL FROM FIXTURE), MINIMUM.  
5.) ALL EXIT AND EMERGENCY FIXTURES SHALL BE FED FROM UNSWITCHED LEG OF ASSOCIATED LOCAL LIGHTING CIRCUITS.  
6.) IN THE EVENT THE CONTRACTOR CHOOSES TO SUBSTITUTE LIGHT FIXTURES FOR THOSE THAT ARE SPECIFIED ON THE LIGHT FIXTURE SCHEDULE, THE CONTRACTOR SHALL SUBMIT POINT-TO-POINT PHOTOMETRIC CALCULATIONS FOR ALL AREAS WHERE THE SUBSTITUTED FIXTURES ARE INDICATED TO BE INSTALLED ON THE DRAWINGS. THESE CALCULATIONS SHALL BE SUBMITTED ALONG WITH THE LIGHT FIXTURE SHOP DRAWINGS.



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CHECKED BY DS  
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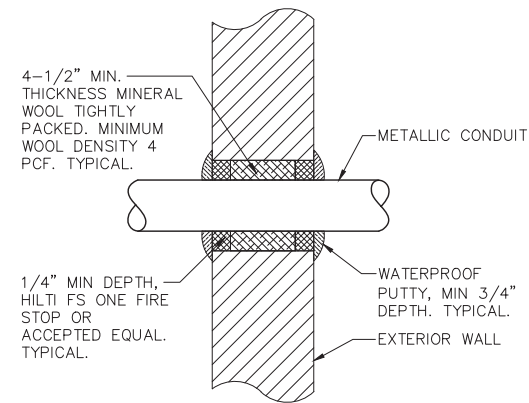
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PPCH PANEL SCHEDULE									
MAIN RATING: <u>225A</u>				MAIN C.B.: <u>MLO</u>		KAIC RATING: <u>10KAIC</u>			
VOLTAGE: <u>120/240V</u>				PHASE: <u>1</u>		WIRE: <u>3</u>		MOUNTING: <u>SURFACE</u>	
CIRC. NO.	LOAD DESCRIPTION	BKR. AMPS	NO. OF POLES	NO. OF POLES	BKR. AMPS	LOAD DESCRIPTION	CIRC. NO.		
1	FA BOOSTER POWER SUPPLY	20LK	1	1	20	EX. BURNER	2		
3	EX. CIRC/PUMP	30	2	2	20	EX. 1ST FL AC	4		
5							6		
7	EX.HANDICAP HAND DRYER	20	1	1	20	EX. LOAD	8		
9	EX. LOAD	20	2	1	15	EX. LOAD	10		
11				1	15	EX. LOAD	12		
13	EX. FURNACE	15	1	1	15	EX. LOAD	14		
15	EX. PRO SHOP	20	1	1	15	EX. HOT WATER	16		
17	EX. COOLER	15	1	1	15	EX. TLS-300 VEETER ROOT	18		
19	EX. LOAD	15	1	1	15	EX. OVERFILL ALARM TANK	20		
21	EX. LOAD	15	1	1	20	EX. LOAD	22		
23	EX. LOAD	15	1	1	20	EX. MC	24		
25	EX. LOAD	20	1	1	20	EX. MC	26		
27	EX. LOAD	20	1	2	20	EX. LOAD	28		
29	EX. LOAD	20	1				30		
31	EX. LOAD	15	1	-	-	-	32		
33	EX. LOAD	15	1	-	-	-	34		
35	SPARE	20	1	1	20	SPARE	36		
37	SPARE	20	1	1	20	SPARE	38		
39	SPARE	20	1	1	20	SPARE	40		
41	SPARE	20	1	1	20	SPARE	42		
LK - PROVIDE LOCKING TABS ON C.B.; GF - GFI TYPE C.B.; AF - ARC FAULT TYPE C.B.; ST - SHUNT TRIP C.B.									
NOTES:									


PPCH1 PANEL SCHEDULE									
MAIN RATING: <u>125A</u>				MAIN C.B.: <u>100A</u>		KAIC RATING: <u>10KAIC</u>			
VOLTAGE: <u>120/240V</u>				PHASE: <u>1</u>		WIRE: <u>3</u>		MOUNTING: <u>SURFACE</u>	
CIRC. NO.	LOAD DESCRIPTION	BKR. AMPS	NO. OF POLES	NO. OF POLES	BKR. AMPS	LOAD DESCRIPTION	CIRC. NO.		
1	RECP MEN'S RM	20	1	1	20	RECP WOMEN'S RM	2		
3	RECP MEN'S RM	20	1	1	20	RECP WOMEN'S RM	4		
5	RECP MEN'S RM	20	1	1	20	RECP WOMEN'S RM	6		
7	HAND DRYER	20	1	1	20	HAND DRYER	8		
9	RECP STORAGE 1 & 2	20	1	1	20	RECP WP/GFI EXTR NR ACC-2	10		
11	RECP STORAGE 2	20	1	2	35	HWH-1	12		
13	MOTORIZED DAMPERS	15	1				14		
15	ACC-1	30	2	2	15	HP-1	16		
17							18		
19	HVAC CONTROL PANEL	20	1	1	20	LTS FOYER RESTROOMS	20		
21	HVAC CONTROL PANEL	20	1	1	20	LTS RESTROOMS/STORAGE	22		
23	HWH-2	15	1	-	-	-	24		
25	ERV-1	25	2	-	-	-	26		
27				-	-	-	28		
29	-	-	-	-	-	-	30		
31	-	-	-	-	-	-	32		
33	-	-	-	-	-	-	34		
35	SPARE	20	1	1	20	SPARE	36		
37	SPARE	20	1	1	20	SPARE	38		
39	SPARE	20	1	1	20	SPARE	40		
41	SPARE	20	1	1	20	SPARE	42		
LK - PROVIDE LOCKING TABS ON C.B.; GF - GFI TYPE C.B.; AF - ARC FAULT TYPE C.B.; ST - SHUNT TRIP C.B.									
NOTES:									

PPCS PANEL SCHEDULE									
MAIN RATING: <u>225A</u>				MAIN C.B.: <u>200A</u>		KAIC RATING: <u>10KAIC</u>			
VOLTAGE: <u>120/240V</u>				PHASE: <u>1</u>		WIRE: <u>3</u>		MOUNTING: <u>SURFACE</u>	
CIRC. NO.	LOAD DESCRIPTION	BKR. AMPS	NO. OF POLES	NO. OF POLES	BKR. AMPS	LOAD DESCRIPTION	CIRC. NO.		
1	RECP PRO WORK SHED	20	1	2	30	RECP 220V	2		
3	RECP PRO WORK SHED	20	1			4			
5	RECP PRO WORK SHED	20	1	2	30	RECP 220V	6		
7	RECP PRO WORK SHED	20	1			8			
9	RECP WP/GFI EXTR	20	1	2	30	UH-2	10		
11	RECP CART STORAGE	20	1			12			
13	RECP CART STORAGE	20	1	2	30	UH-1	14		
15	MOTORIZED DAMPERS	20	1			16			
17	EF-1	20	2	2	20	EF-3	18		
19						20			
21	EF-2	20	2	2	20	CARBTR0L SUMP PUMP	22		
23						24			
25	CARBTR0L EQPT	20	2	1	20	LTS	26		
27				1	20	LTS	28		
29	HVAC CRTL PNL	20	1	1	20	LTS	30		
31	HVAC CRTL PNL	20	1	1	20	LTS EXTR	32		
33	FACP	20LK	1	1	15	EX. MC TO OUTSIDE	34		
35	EX. MC TO OUTSIDE	20	1	1	15	EX. 300 TANK	36		
37	EX. MC TO OUTSIDE	20	1	1	20	EX. VEEDER ROOT ALARM	38		
39	EX. GAS PUMP	20	1	2	100	EX. PRO SHOP ATTIC PANEL	40		
41	EX. RANGE GFI	20	1			42			
43	MOTORIZED DAMPERS	20	1	1	20	DOOR OPERATORS	44		
45	DOOR OPERATOR CTRL PANEL	20	1	1	20	DOOR OPERATORS	46		
47	SPARE	20	1	1	20	SPARE	48		
49	SPARE	20	1	1	20	SPARE	50		
51	SPARE	20	1	1	20	SPARE	52		
53	SPARE	20	1	1	20	SPARE	54		
LK - PROVIDE LOCKING TABS ON C.B.; GF - GFI TYPE C.B.; AF - ARC FAULT TYPE C.B.; ST - SHUNT TRIP C.B.									
NOTES:									


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NAME				NAME									
SIGNATURE				SIGNATURE									
TITLE	DATE			TITLE	DATE								
WESTCHESTER COUNTY, NEW YORK				CONTRACT NUMBER	SHEET NUMBER								
DEPARTMENT OF PUBLIC WORKS				17 - 539	E-601								
DIVISION OF ENGINEERING				SHEET NO. 57 OF 59									
NEW GOLF CART STORAGE FACILITY AND CLUBHOUSE UPGRADES				SCALE: NONE									
MOHANSIC GOLF COURSE, YORKTOWN, NEW YORK				DATE: 6/4/21									
ELECTRICAL SCHEDULES				DPW FILE NO.		REV. NO.							
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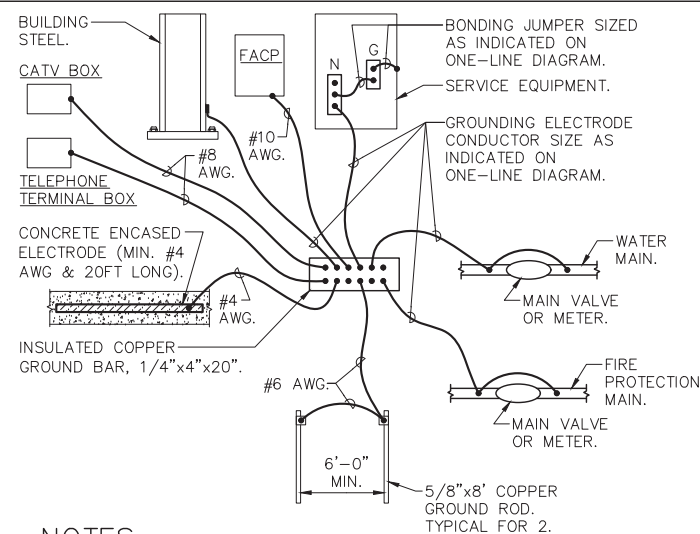
TYPICAL ABOVE GRADE CONDUIT  
EXTERIOR MASONRY WALL  
PENETRATION DETAIL  
SCALE: NONE



TYPICAL CONDUIT INTERIOR MASONRY  
WALL PENETRATION DETAIL  
SCALE: NONE

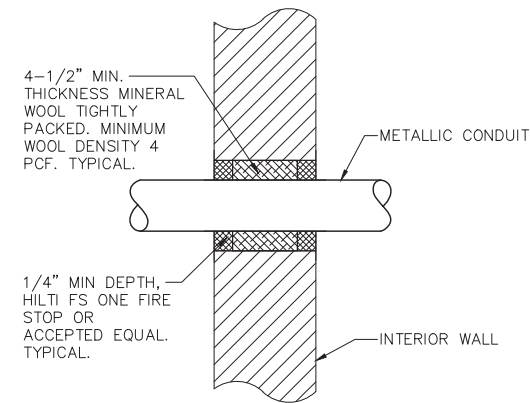


TYPICAL CONDUIT GYPSUM  
WALL PENETRATION DETAIL  
SCALE: NONE

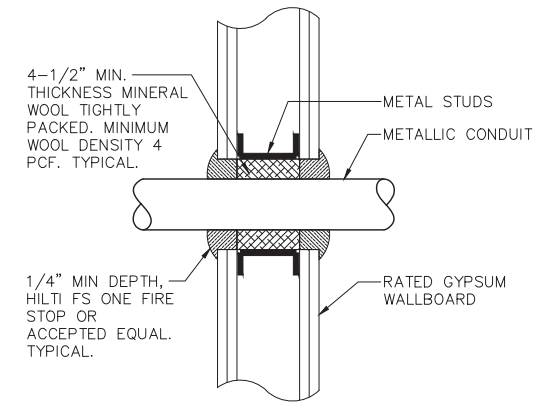

- NOTES:
- 1.) CONNECTION TO WATER MAIN AND FIRE PROTECTION MAIN SHALL BE A MAXIMUM OF 5'-0" FROM WHERE THE PIPE ENTERS THE BUILDING AND BE PRIOR TO ANY METER, VALVE JOINT, ETC.
  - 2.) ALL CONNECTIONS TO THE GROUND BAR SHALL BE MADE USING COMPRESSION LUGS SIZED TO ACCOMMODATE THE CONDUCTORS.


9 SERVICE GROUNDING DETAIL - CLUBHOUSE  
SCALE: NONE

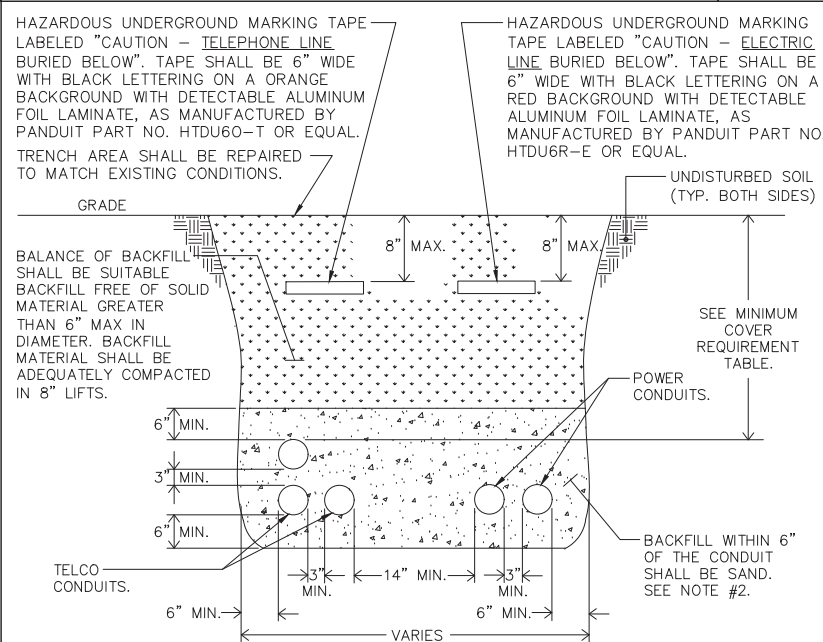

6 TRENCHING DETAIL FOR CONDUIT  
SCALE: NONE


LOCATION	NONMETALLIC RACEWAYS LISTED FOR DIRECT BURIAL WITHOUT CONCRETE ENCASEMENT OR OTHER APPROVED RACEWAYS
ALL LOCATION NOT SPECIFIED BELOW.	18"
IN TRENCH BELOW 2-IN. THICK CONCRETE OR EQUIVALENT.	12"
UNDER MINIMUM OF 4-IN. THICK CONCRETE EXTERIOR SLAB WITH NO VEHICULAR TRAFFIC AND THE SLAB EXTENDING NOT LESS THAN 6 IN. BEYOND THE UNDERGROUND INSTALLATION.	4" SEE NOTE #2.
UNDER STREETS, HIGHWAYS, ROADS, ALLEYS, DRIVEWAYS, AND PARKING LOTS.	24"

- NOTES:
- 1.) DETAIL SHOWN FOR INFORMATION PURPOSES. SAME CONCEPT SHALL ALSO APPLY FOR SINGLE CONDUITS.
  - 2.) SAND MAY BE OMITTED FOR INSTALLATIONS WHERE COVER REQUIREMENTS ARE 6" OR LESS.

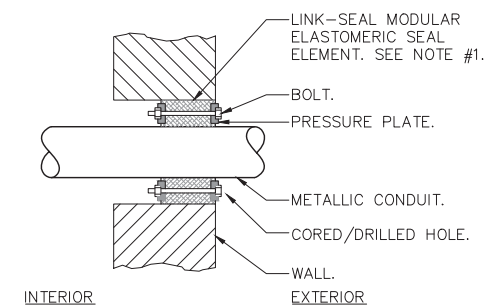


- NOTES:
- 1.) SEAL ASSEMBLY BASED ON THUNDERLINE MODEL "C" LINK-SEAL MODULAR SEAL, WITH EPDM SEAL ELEMENT, COMPOSITE PRESSURE PLATES, STEEL WITH 2-PART ZINC DICHROMATE & ORGANIC COATING NUTS AND BOLTS AND WITH A OPERATING TEMPERATURE RANGE OF -40°F TO +250°F.
  - 2.) PROVIDE AND INSTALL TWO SEALS WHEN PENETRATED WALL THICKNESS IS GREATER THAN 12".
  - 3.) PROVIDE SCHEDULE 80 WALL SLEEVE FOR NEW WALL CONSTRUCTION PER MANUFACTURER'S REQUIREMENTS.


TYPICAL BELOW GRADE CONDUIT  
EXTERIOR MASONRY WALL  
PENETRATION DETAIL  
SCALE: NONE

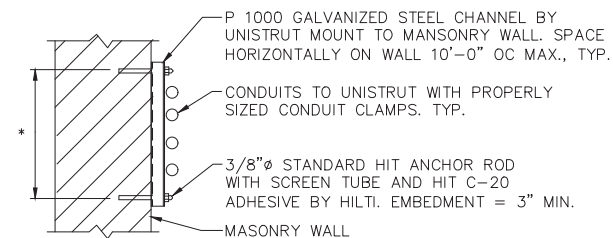

TYPICAL CONDUIT SUPPORT  
ON MASONRY  
SCALE: 1" = 1'-0"

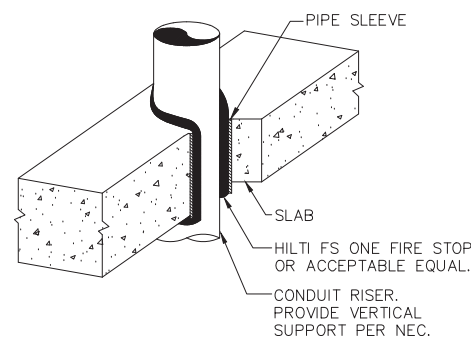

5 VERTICAL CONDUIT PENETRATION DETAIL  
SCALE: NONE

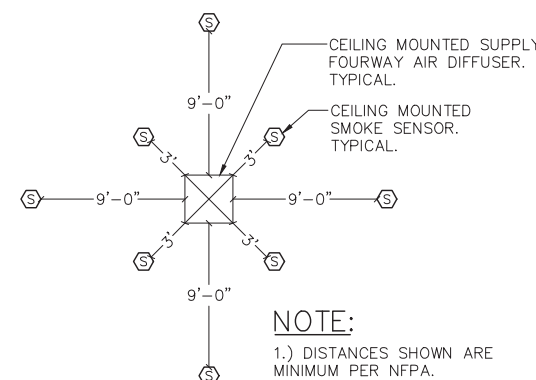


CEILING MOUNTED SMOKE DETECTOR  
LOCATION WITH RESPECT TO  
AIR DIFFUSER  
SCALE: NONE

IN CHARGE OF JW  
CHECKED BY DS  
MADE BY CT

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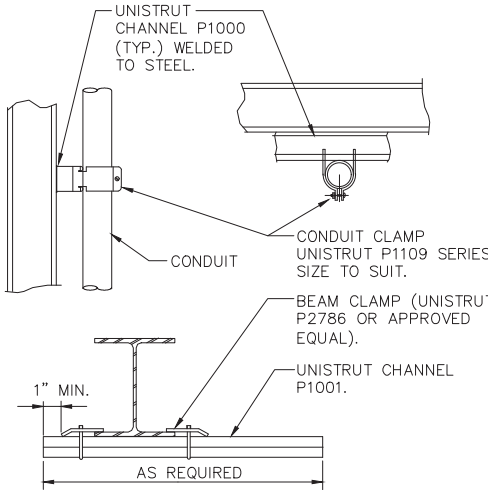
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REVISION NUMBER	DATE	MADE BY	APP'D BY	REVISION			
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CONTRACTOR NAME _____ SIGNATURE _____ TITLE _____ DATE _____				PROJECT COORDINATOR NAME _____ SIGNATURE _____ TITLE _____ DATE _____			
WESTCHESTER COUNTY, NEW YORK DEPARTMENT OF PUBLIC WORKS DIVISION OF ENGINEERING				CONTRACT NUMBER 17-539 SHEET NO. 58 OF 59			
NEW GOLF CART STORAGE FACILITY AND CLUBHOUSE UPGRADES MOHANSIC GOLF COURSE, YORKYOWN, NEW YORK ELECTRICAL DETAILS				SCALE: NONE DATE: 6/4/21 DPW FILE NO. 10-02-E-91-0 REV. NO. 0			

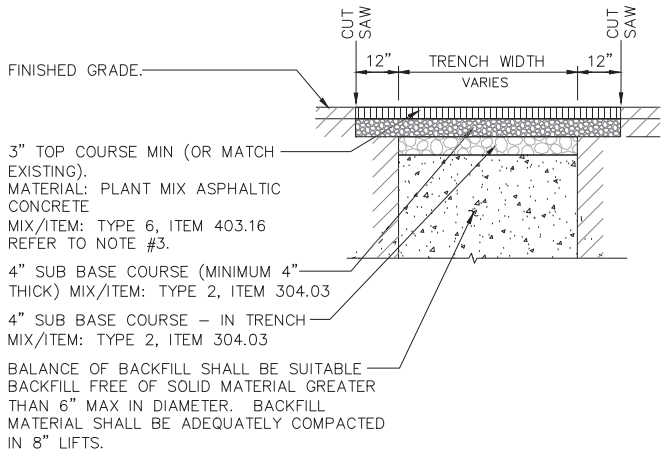


3" TOP COURSE MIN (OR MATCH EXISTING).  
MATERIAL: PLANT MIX ASPHALTIC CONCRETE  
MIX/ITEM: TYPE 6, ITEM 403.16  
REFER TO NOTE #3.  
4" SUB BASE COURSE (MINIMUM 4" THICK) MIX/ITEM: TYPE 2, ITEM 304.03  
4" SUB BASE COURSE - IN TRENCH MIX/ITEM: TYPE 2, ITEM 304.03  
BALANCE OF BACKFILL SHALL BE SUITABLE BACKFILL FREE OF SOLID MATERIAL GREATER THAN 6" MAX IN DIAMETER. BACKFILL MATERIAL SHALL BE ADEQUATELY COMPACTED IN 8" LIFTS.

NOTES:  
1.) THICKNESS INDICATED REFERS TO COMPACTED MEASURE.  
2.) ITEM NUMBERS REFER TO NEW YORK STATE DEPARTMENT OF TRANSPORTATION STANDARD SPECIFICATIONS.  
3.) REFER TO TRENCHING DETAIL FOR TRENCH INFORMATION.

5 BITUMINOUS PAVEMENT REPLACEMENT DETAIL  
SCALE: NONE




CONDUIT SUPPORTED FROM STRUCTURAL STEEL  
SCALE: NONE

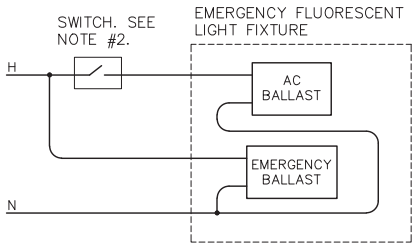


NOTES:  
1.) THE CONNECTION TO THE LAMPS IS NOT SHOWN - FOLLOW MANUFACTURER WIRING DIAGRAMS.  
2.) "SWITCH" REPRESENTS A SINGLE POLE SWITCH, A SET OF CONTACTS, A COMBINATION OF 3 WAY AND 4 WAY SWITCHES, ETC. SEE DRAWINGS FOR ACTUAL SWITCH CONFIGURATION.

4 SWITCHED EMERGENCY FIXTURE WIRING DIAGRAM  
SCALE: NONE

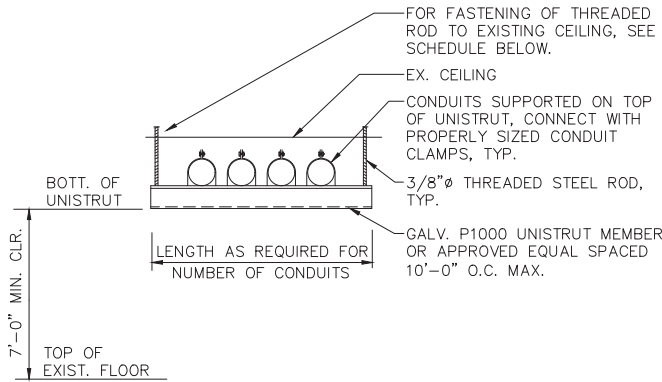


CEILING CONSTRUCTION	ANCHOR TYPE	EMBEDMENT
NORMAL WT. CONC	HILTI HDI DROP-IN ANCHOR	1" MIN.
CINDER CONCRETE	HILTI KWIK BOLT II	3" MIN.
HOLLOW CONSTRUCTION	TOGGLE BOLTS	NA

1 TRAPEZE SUPPORT DETAIL  
SCALE: NONE

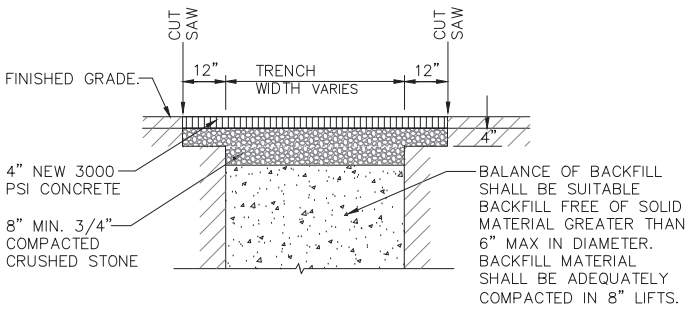

NOTE:  
1. REFER TO TRENCHING DETAIL FOR TRENCH INFORMATION.

6 CONCRETE PAVEMENT REPLACEMENT DETAIL  
SCALE: NONE

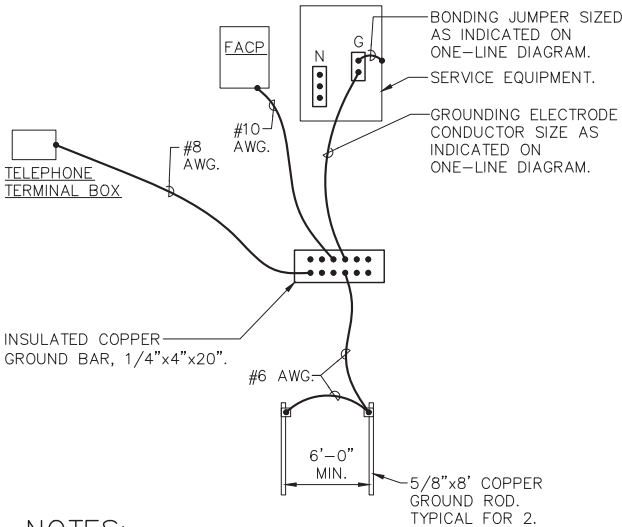

NOTES:  
1.) CONNECTION TO WATER MAIN AND FIRE PROTECTION MAIN SHALL BE A MAXIMUM OF 5'-0" FROM WHERE THE PIPE ENTERS THE BUILDING AND BE PRIOR TO ANY METER, VALVE JOINT, ETC.  
2.) ALL CONNECTIONS TO THE GROUND BAR SHALL BE MADE USING COMPRESSION LUGS SIZED TO ACCOMMODATE THE CONDUCTORS.

3 SERVICE GROUNDING DETAIL - CART STORAGE  
SCALE: NONE

				<b>OLA Consulting Engineers</b> 60 Broadway, Hawthorne, New York 10632 914.747.2800 8 West 38th Street, Suite 501 New York, NY 10018 646.848.4190 ola.co.com															
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WESTCHESTER COUNTY, NEW YORK DEPARTMENT OF PUBLIC WORKS DIVISION OF ENGINEERING								CONTRACT NUMBER 17-539 SHEET NO. 59 OF 59											
NEW GOLF CART STORAGE FACILITY AND CLUBHOUSE UPGRADES MOHANSIC GOLF COURSE, YORKTOWN, NEW YORK ELECTRICAL DETAILS								SCALE: NONE DATE: 6/4/21 DPW FILE NO. 10-02-E-92-0 REV. NO. 0											

IN CHARGE OF JW  
CHECKED BY DS  
MADE BY CT

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