






WESTCHESTER COUNTY, NEW YORK DEPARTMENT OF PUBLIC WORKS AND TRANSPORTATION DIVISION OF ENGINEERING

CONTRACT No. 15-531 SUPERSTORM SANDY REHABILITATION GLEN ISLAND PARK SEAWALLS AND PAVILIONS NEW ROCHELLE, NEW YORK

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LOCATION MAP
SCALE: N.T.S.
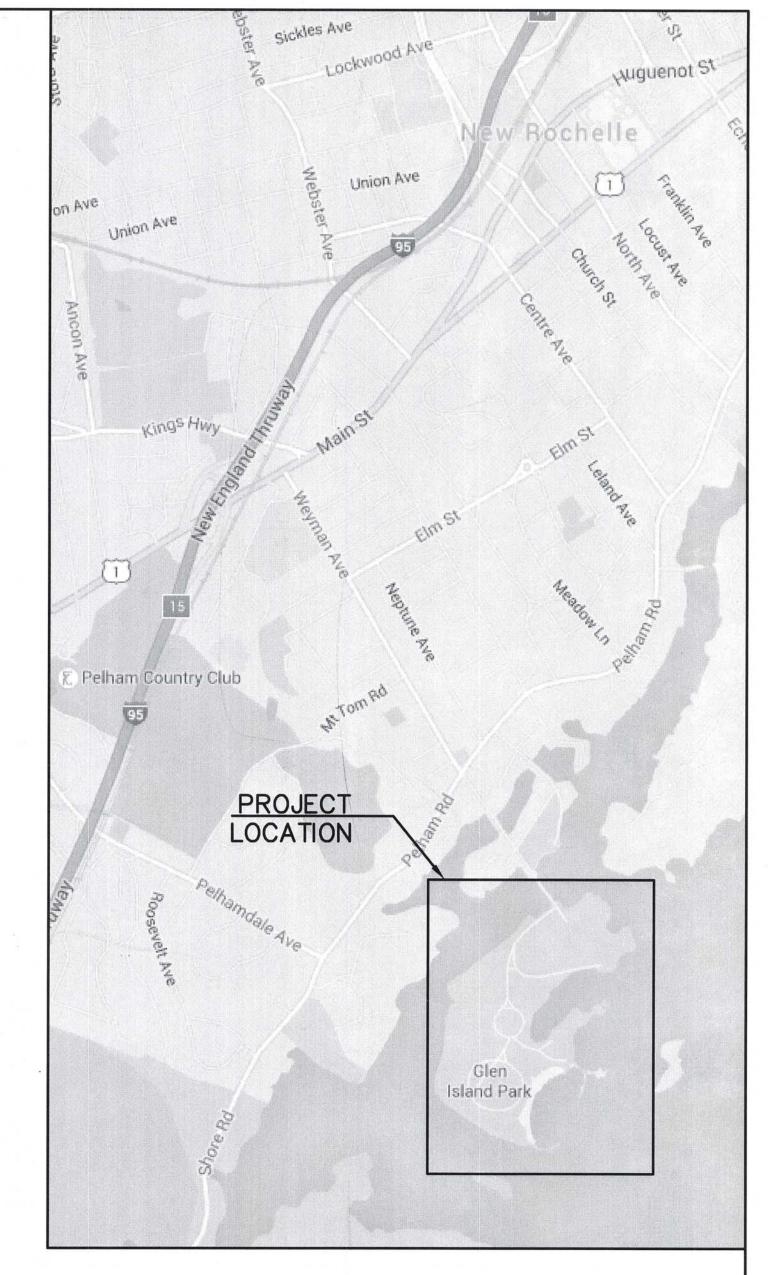
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DIVISION OF ENGINEERING SUPERSTORM SANDY REHABILIT						SHEET NO. 1	OF 34	

GLEN ISLAND PARK SEAWALLS AND PAVILIONS

NEW ROCHELLE, NEW YORK

TITLE SHEET AND LIST OF DRAWINGS

DATE: MAY, 2018

5-18-T-99

DPW FILE NO.

UNAUTHORIZED ALTERATION OF. OR ADDITION TO THIS PLAN IS A VIOLATION OF ARTICLE 145, SECTION 7209.2 OF THE NEW YORK STATE EDUCATION LAW.

IN CHARGE OF J. R. VALENTIN, P.E.

CHECKED BY J. R. VALENTIN, P.E.

MADE BY C. LINO

RECOMENDED FOR CONSTRUCTION DATE

KATHLEEN O'CONNOR
COMMISSIONER
DEPARTMENT OF PARKS, RECREATION
AND CONSERVATION

RECOMENDED FOR CONSTRUCTION DATE

JOSEPH J. NICOLETTI JR., P.E.
FIRST DEPUTY COMMISSIONER
DEPARTMENT OF PUBLIC WORKS
AND TRANSPORTATION

HUGH J. GREECHAN JR. P.F.

HUGH J. GREECHAN JR., P.E.
COMMISSIONER
DEPARTMENT OF PUBLIC WORKS
AND TRANSPORTATION

GENERAL NOTES:

- 1. DESIGN SPECIFICATIONS: US ARMY CORPS OF ENGINEERS DESIGN OF COASTAL REVETMENTS, SEAWALLS AND BULKHEADS.
- 2. CONSTRUCTION WORK SHALL BE IN ACCORDANCE WITH THE NEW YORK STATE DEPARTMENT OF TRANSPORTATION "STANDARD SPECIFICATIONS, CONSTRUCTION AND MATERIALS" DATED MAY 1, 2008 WITH CURRENT ADDITIONS AND MODIFICATIONS. PAY ITEMS SHALL BE IN ENGLISH UNITS.
- 3. DETAILS ON THE DRAWINGS LABELED AS 'NOT TO SCALE" ARE INTENTIONALLY DRAWN NOT TO SCALE FOR VISUAL CLARITY. ALL OTHER DETAILS FOR WHICH NO SCALE IS SHOWN ARE DRAWN PROPORTIONAL AND ARE FULLY DIMENSIONED.
- 4. ALL SHOP DRAWINGS SUBMITTED FOR THIS PROJECT SHALL BE IN U.S. CUSTOMARY UNITS.
- 5. THE COST OF WATER USED FOR COMPACTION OF SELECT FILL ITEMS SHALL BE INCLUDED IN THE UNIT PRICE BID FOR ITEM 203.07 -SELECT GRANULAR FILL.
- 6. THE COST OF ALL JOINT MATERIAL SHALL BE INCLUDED IN THE UNIT PRICES BID FOR THE VARIOUS ITEMS OF THE CONTRACT, UNLESS OTHERWISE SPECIFIED ON THE PLANS.
- 7. DIMENSIONS FOR THICKNESSES OF STEEL ROLLED ANGLE SHAPES AND STRUCTURAL TUBING ARE SHOWN ACCORDING TO THE AISC MANUAL.
- 8. UNLESS OTHERWISE INDICATED ON THE PLANS, WORK TO BE PERFORMED UNDER THIS CONTRACT DOES NOT REQUIRE THE DISTURBING, DESTRUCTION OR REMOVAL OF ANY KNOWN MATERIALS CONTAINING ASBESTOS. UNLESS OTHERWISE INDICATED ON THE PLANS, IT IS THE EXPRESS INTENT OF THIS CONTRACT THAT THESE MATERIALS NOT BE DISTURBED IN ANY WAY. SHOULD THE CONTRACTOR BE FORCED TO DISTURB IN ANY WAY ANY SUCH MATERIALS, THE CONTRACTOR SHALL FIRST BE FAMILIAR WITH INDUSTRIAL CODE RULE 56 OF THE N.Y.S. DEPARTMENT OF LABOR. THE CONTRACTOR SHALL ALSO OBTAIN WRITTEN PERMISSION OF THE REGIONAL DIRECTOR OF TRANSPORTATION BEFORE PROCEEDING.
- 9. PAVILION FOUNDATION DESIGN CRITERIA: GEOTECHNICAL PARAMETERS: BASED ON REPORT BY OWEIS ENGINEERING INC. DATED 11/11/15 $Q = 1,000 LB/FT^2$ ALLOWABLE BEARING PRESSURE: EFFECTIVE ANGLE OF INTERNAL FRICTION: $\phi = 32^{\circ}$ UNIT WEIGHT OF SOIL: $\gamma = 120 \text{ LB/FT}^3$

10. SEA WALL NOTES:

- A. CONTRACTOR IS TO REUSE EXISTING STONES WHEREVER POSSIBLE.
- B. STONE COLORING OF SEA WALL RECONSTRUCTION AREAS TO MATCH COLORING OF EXISTING WALL.
- ALL PLACEMENTS OF SELECT GRANULAR FILL, ITEM 203.07. SHALL BE COMPACTED TO 95 PERCENT OF STANDARD PROCTOR MAXIMUM DENSITY.

12. COFFERDAM NOTES:

- A. WHERE A COFFERDAM IS USED, THE COST OF DEWATERING THE ENTIRE EXCAVATION, REGARDLESS OF SOURCE OF WATER, SHALL BE INCLUDED IN THE UNIT PRICE BID FOR THE COFFERDAM ITEM.
- B. SHOULD FIELD CONDITIONS REQUIRE A CHANGE FROM THE TYPE OF COFFERDAM SYSTEM CALLED FOR ON THE PLANS, THE ENGINEER-IN-CHARGE SHALL CONTACT THE COUNTY FOR COORDINATION WITH APPROPRIATE AGENCIES TO APPROVE THE CHANGE.
- C. IF MULTIPLE COFFERDAMS ARE REPLACED BY A SINGLE SYSTEM. AS PERMITTED BY THE COUNTY ENGINEER, PAYMENT SHALL BE BASED ON ALL OF THE APPLICABLE COFFERDAM ITEMS INDICATED ON THE PLANS.
- D. DEWATERING OF THE COFFERDAM SHALL BE ACCOMPLISHED BY PUMPING THE WATER TO AN APPROVED UPLAND VEGETATED AREA OUTSIDE OF THE STREAMBED AS SHOWN ON THE PLANS AND/OR APPROVED BY THE E.I.C. TEMPORARY SOIL EROSION AND WATER POLLUTION CONTROL, SUCH AS STRAW BALES OR APPROVED EQUAL, MAY BE REQUIRED AS DETERMINED BY THE ENGINEER-IN-CHARGE, NO SETTLEMENT BASIN SHALL BE CONSTRUCTED.

13. DATUM

- VERTICAL DATUM: NORTH AMERICAN VERTICAL DATUM (NAVD) 1988 HORIZONTAL DATUM: NORTH AMERICAN DATUM (NAD) 1983
- 14. 100 YEAR FLOOD LEVEL RANGES FROM 14-17 FT NAVD 1988 DEPENDING ON LOCATION. THIS IS DEFINED AS THE WATER SURFACE ELEVATION FOR A FLOOD THAT HAS A RECURRENCE INTERVAL OF 100 YEARS.
- 15. MEAN HIGH WATER IS ESTIMATED TO BE 3.35 FT NAVD 1988. THIS IS DEFINED AS THE HIGHEST SURFACE WATER ELEVATION LIKELY TO BE ENCOUNTERED DURING ONE CONSTRUCTION SEASON (OTHER THAN MAJOR FLOODS). IT IS ALWAYS LESS THAN THE ORDINARY HIGH WATER ELEVATION AND IT IS USUALLY AN OBSERVED ELEVATION RATHER THAN A COMPUTED ONE.
- 16. MEAN LOW WATER IS ESTIMATED TO BE -3.93 FT NAVD 1988. THIS WATER ELEVATION IS THE NORMAL LOW WATER ELEVATION PREVALENT DURING ONE CONSTRUCTION SEASON FOR MORE THAN 25% OF THE TIME. IT IS AN OBSERVED ELEVATION RATHER THAN A COMPUTED ONE.

UNAUTHORIZED ALTERATION OF, OR ADDITION TO THIS PLAN IS A VIOLATION OF ARTICLE 145, SECTION 7209.2 OF THE NEW YORK STATE EDUCATION LAW.

J. R. VALENTIN, P.E. J. R. VALENTIN, P.E. CHECKED BY C. LINO

17. CONCRETE

- A. ALL CONCRETE WORK SHALL COMPLY WITH THE REQUIREMENTS OF ACI 318, LATEST EDITION.
- B. ALL CONCRETE SHALL HAVE MINIMUM 28-DAY COMPRESSIVE STRENGTH OF 4,000 PSI, UNLESS OTHERWISE NOTED. CONCRETE SHALL BE AIR-ENTRAINED IN ACCORDANCE WITH ACI STANDARDS. MAXIMUM SLUMP SHALL BE 4 INCHES. ALL CONCRETE SHALL BE NORMAL WEIGHT, UNLESS OTHERWISE NOTED.

18. REINFORCEMENT STEEL:

- A. ALL STRUCTURAL STEEL SHALL CONFORM TO ASTM A615M (GRADE 60).
- B. ALL REINFORCING STEEL LAP LENGTHS SHALL BE 40 BAR DIAMETERS UNLESS OTHERWISE NOTED.
- C. ALL REINFORCING STEEL CLEAR COVER SHALL BE AS FOLLOWS UNLESS OTHERWISE NOTED:
- CONCRETE CAST AGAINST EARTH
 3"
- ALL OTHER CAST—IN—PLACE CONCRETE 2"
- 19. SHOP DRAWING SUBMITTALS ARE REQUIRED FOR THE PEDESTRIAN RAILING ITEMS W607.60 AND W607.61.
- 20. EXTERIOR SURFACES OF NEW CONCRETE WALLS AND SLABS SHALL BE SEALED.

21. REMOVAL NOTES:

- A. EXISTING SUBSTRUCTURE SHALL BE REMOVED WITHIN THE LIMITS SHOWN ON THE PLANS UNDER ITEM 202.19.
- B. DEMOLITION AND REMOVAL WORK SHALL PROCEED IN A MANNER WHICH PREVENTS DAMAGE TO THE EXISTING STRUCTURES. ANY DAMAGE TO THE EXISTING STRUCTURES TO REMAIN SHALL BE REPAIRED BY THE CONTRACTOR AT NO COST TO THE OWNER.
- C. THE CONTRACTOR'S ATTENTION IS DIRECTED TO THE REQUIREMENTS OF SUBSECTION 202-3.01 GENERAL AND SAFETY REQUIREMENTS. A REMOVAL PLAN, SIGNED BY A REGISTERED PROFESSIONAL ENGINEER IN THE STATE OF NEW YORK, SHALL BE SUBMITTED TO THE ENGINEER THIRTY (30) DAYS PRIOR TO BEGINNING THE DEMOLITION.
- D. ANY-DEBRIS OR EXCESS MATERIALS FROM CONSTRUCTION OF THIS PROJECT SHALL BE IMMEDIATELY AND COMPLETELY REMOVED FROM ALL TIDAL WETLAND AREAS TO AN APPROPRIATE UPLAND AREA FOR DISPOSAL.
- E. ALL EXCAVATION BELOW MEAN HIGH WATER SHALL BE PERFORMED DURING LOW TIDE UNLESS THE WORK AREA IS ISOLATED FROM WATER.
- 22. RECORD PLANS FOR THESE STRUCTURES ARE NOT AVAILABLE.
- 23. ALL CONSTRUCTION WORK SHALL BE PERFORMED IN ACCORDANCE WITH ALL APPLICABLE SAFETY CODES. APPLICABLE SAFETY CODES SHALL MEAN THE LATEST EDITION INCLUDING ANY AND ALL AMENDMENTS, REVISIONS AND ADDITIONS THERETO TO THE FEDERAL DEPARTMENT OF LABOR, OCCUPATIONAL SAFETY AND HEALTH ADMINISTRATION'S "OCCUPATIONAL SAFETY AND HEALTH STANDARDS" (OSHA): AND APPLICABLE SAFETY, HEALTH REGULATIONS AND BUILDING CODES FOR CONSTRUCTION IN THE STATE OF NEW YORK.

24. RECONSTRUCTION NOTES:

- A. THE CONTRACTOR'S ATTENTION IS DIRECTED TO THE FACT THAT, DUE TO THE NATURE OF RECONSTRUCTION PROJECTS, THE EXACT EXTENT OF RECONSTRUCTION WORK CANNOT ALWAYS BE ACCURATELY DETERMINED PRIOR TO THE COMMENCEMENT OF WORK. THESE CONTRACT DOCUMENTS HAVE BEEN PREPARED BASED ON FIELD INSPECTION AND OTHER INFORMATION AVAILABLE AT THE TIME. ACTUAL FIELD CONDITIONS MAY REQUIRE MODIFICATIONS TO CONSTRUCTION DETAILS AND WORK QUANTITIES. SHOULD CONDITIONS DIFFER FROM THOSE DETAILED IN THESE DOCUMENTS. THE CONTRACTOR IS TO OBTAIN THE ENGINEERS APPROVAL FOR ANY PROPOSED MODIFICATION OF WORK BEFORE PROCEEDING.
- B. THE CONTRACTOR SHALL VERIFY DIMENSIONS NECESSARY FOR THE PROPER FIT OF STEEL RAILING PRICR TO THE FABRICATION OF THE STEEL. THE COST OF FIELD VERIFYING DIMENSIONS SHALL BE INCLUDED IN THE PRICE BID FOR RAILING ITEMS.
- C. THE CONTRACTOR SHALL PERFORM ALL WORK WITH CARE SO THAT ANY MATERIALS WHICH ARE TO REMAIN IN PLACE, OR WHICH ARE TO REMAIN THE PROPERTY OF THE COUNTY, WILL NOT BE DAMAGED. IF THE CONTRACTOR DAMAGES ANY MATERIALS WHICH ARE TO REMAIN IN PLACE OR WHICH ARE TO REMAIN THE PROPERTY OF THE COUNTY. THE DAMAGED MATERIALS SHALL BE REPAIRED OR REPLACED IN A MANNER SATISFACTORY TO THE ENGINEER AT THE EXPENSE OF THE CONTRACTOR.
- D. WHENEVER ITEMS IN THE CONTRACT REQUIRE MATERIALS TO BE REMOVED AND DISPOSED OF, THE COST OF SUPPLYING A DISPOSAL AREA AND TRANSPORTATION TO THAT AREA SHALL BE INCLUDED IN THE UNIT PRICES BID FOR THOSE ITEMS.
- E. DURING REMOVAL OPERATIONS, THE CONTRACTOR SHALL NOT BE ALLOWED TO DROP WASTE CONCRETE, DEBRIS AND OTHER MATERIAL TO THE WATER SURROUNDING SEA WALLS OR PAVILIONS EXCEPT WHERE THE PLANS SPECIFICALLY PERMIT THE DROPPING OF MATERIAL. PLATFORMS, NETS, SCREENS OR OTHER

- PROTECTIVE DEVICES SHALL BE USED TO CATCH THE MATERIAL. IF THE ENGINEER DETERMINES THAT ADEQUATE PROTECTIVE DEVICES ARE NOT BEING EMPLOYED, THE WORK SHALL BE SUSPENDED UNTIL ADEQUATE PROTECTION IS PROVIDED.
- F. ALL MATERIAL FALLING ON THE AREA BELOW AND ADJACENT TO THE SEA WALLS AND PAVILIONS SHALL BE REMOVED AND DISPOSED OF BY THE CONTRACTOR AT NO COST TO THE COUNTY.
- G. THE COST OF FURNISHING, INSTALLING, MAINTAINING, REMOVING AND DISPOSING OF ALL PLATFORMS, NETS, SCREENS OR OTHER PROTECTIVE DEVICES SHALL BE INCLUDED IN THE UNIT PRICES BID FOR THE APPROPRIATE ITEMS OF THE CONTRACT.
- H. FOR THE DURATION OF THE PROJECT, THE CONTRACTOR SHALL GIVE THE ENGINEER AT LEAST 24 HOURS NOTICE PRIOR TO PERFORMING WORK ON SITE. THE CONTRACTOR WILL NOT BE ALLOWED TO PERFORM WORK ON SITE AT ANY TIME NOT INDICTED ON THE APPROVED SCHEDULE, UNLESS OTHERWISE APPROVED BY THEN ENGINEER.

25. CONDUIT CAUTION NOTE:

THE CONTRACTOR'S ATTENTION IS DIRECTED TO THE FACT THAT CONDUITS MAY BE PRESENT IN THE SIDEWALKS. THEIR EXISTENCE AND LOCATIONS SHALL BE FIELD VERIFIED. IF CONDUITS ARE PRESENT AND ARE ENCOUNTERED DURING CONSTRUCTION OPERATIONS, CARE SHALL BE EXERCISED NOT TO DAMAGE CONDUITS, EXPANSION COUPLINGS, OR CONTENTS OF CONDUITS. ANY DAMAGE SHALL BE REPAIRED TO THE SATISFACTION OF THE ENGINEER, AT NO COST TO THE COUNTY.

- A. ALL EXISTING LIGHT FIXTURES ARE TO REMAIN UNLESS OTHERWISE
- B. WHERE SEA WALL IS TO BE RECONSTRUCTED, CONTRACTOR SHALL REUSE EXISTING LIGHT FIXTURES.
- C. CONTRACTOR SHALL REPLACE EXISTING WIRING AS NECESSARY.

27. WATERWAY PROTECTION NOTE:

DURING THE COURSE OF CONSTRUCTION, THE CONTRACTOR SHALL CONDUCT OPERATIONS IN SUCH A MANNER AS TO PREVENT OR REDUCE TO A MINIMUM ANY DAMAGE TO THE LONG ISLAND SOUND FROM POLLUTION BY DEBRIS, SEDIMENT, OR OTHER FOREIGN MATERIAL, OR FROM MANIPULATION OF EQUIPMENT AND/OR MATERIALS IN OR NEAR SUCH WATERWAYS. THE CONTRACTOR SHALL NOT RETURN DIRECTLY TO THE WATERWAY ANY WATER WHICH HAS BEEN USED FOR WASH PURPOSES OR OTHER SIMILAR OPERATIONS WHICH CAUSE THIS WATER TO BECOME POLLUTED WITH SAND, SILT CEMENT, OIL, OR OTHER IMPURITIES. IF THE CONTRACTOR USES WATER FROM THE LONG ISLAND SOUND, THE CONTRACTOR SHALL CONSTRUCT AN INTAKE OR TEMPORARY DAM REQUIRED TO PROTECT AND MAINTAIN WATER RIGHTS AND TO SUSTAIN FISH LIFE DOWNSTREAM.

28. STONE MASONRY:

- A. JOINTS FOR STONE MASONRY MAY VARY FROM 1/2 INCH TO 1 INCH THICKNESS.
- B. FINISH OF STONE MASONRY SHALL BE A ROUGH OR NATURAL FINISH.

29. DIMENSION MASONRY:

- A. RINGSTONE, QUOINS, COPINGS AND OTHER STONES, IF SO DESIGNATED, SHALL BE DIMENSION MASONRY.
- B. ALL JOINTS FOR DIMENSION MASONRY SHALL BE 1/2 INCH THICKNESS.
- C. FINISH OF STONE MASONRY SHALL BE A ROUGH OR NATURAL

30. SIDEWALK PLACEMENT NOTES:

- A. IN THE EVENT THE CONTRACTOR'S SIDEWALK PLACEMENT OPERATION IS STOPPED PRIOR TO COMPLETION, WHETHER BY THE CONTRACTOR'S OWN DECISION OR BY ORDER OF THE ENGINEER, THE CONTRACTOR SHALL BE RESPONSIBLE FOR PROVIDING A FINISHED SIDEWALK GRADE WHICH MATCHES THE PLANNED PROFILE. ANY SUBSEQUENT REVISIONS MADE NECESSARY BY SUCH ACTION SHALL BE AT THE CONTRACTOR'S EXPENSE.
- 31. GENERAL CONTRACTOR SHALL VERIFY ALL CONDITIONS AND CHECK ALL MEASUREMENTS ON THE JOB AND SHALL BE RESPONSIBLE FOR SAME.

32. DEWATERING:

- WATER MAY BE PRESENT IN AREAS DURING CONSTRUCTION. THE CONTRACTOR IS RESPONSIBLE FOR ALL DEWATERING OPERATIONS TO RELIEVE ALL AREAS FOR THE PURPOSE OF ALLOWING WORK TO PROCEED. THE PRICE FOR THIS DEWATERING WORK WILL BE INCLUDED IN THE PRICE BID FOR ASSOCIATED INDIVIDUAL ITEMS.
- 33. NO ACTIVITY MAY USE UNSUITABALE MATERIAL (E.G. TRASH, DEBRIS, ASPHALT, ETC.), MATERIAL USED FOR CONSTRUCTION MUST BE FREE FROM TOXIC POLLUTANTS IN TOXIC AMOUNTS.
- 34. THERE SHALL BE NO UNREASONABLE INTERFERENCE WITH NAVIGATION AS A RESULT OF THE WORK SHOWN ON PLANS.

- 35. MORTAR REPAIR CRITERIA AND REPOINTING: THE REPOINTING PROCEDURE NOTES ARE VALID FOR REPOINTING DETERIORATED AND LOOSE MORTAR AND/OR REPAIRING AREAS WITH MISSING STONE WITH NEW STONES OR RESETTING EXISTING LOOSE
 - REPAIR MORTAR SHALL BE APPLIED IN AREAS WHERE DETERIORATION IS PRESENT SUCH AS: DISINTEGRATING MORTAR, CRACKS IN MORTAR JOINTS, GAPS IN THE MORTAR/STONE INTERFACE, LOOSE STONES AND MORTAR JOINTS OR DAMP WALLS.
 - SOUND MORTAR THAT IS WELL BONDED SHOULD NOT BE REMOVED AND SHOULD BE PROTECTED AND TREATED WITH CAUTION DURING REHABILITATION OPERATIONS.
 - MORTAR SHALL BE STIFF, ALLOWING THE STONE TO SET UP WITHOUT SQUEEZING THE MORTAR OUT. MORTAR MIXTURE SHALL BE SQUEEZED BY HAND TO DEVELOP THE REQUIRED STIFFNESS AND CONSISTENCY.
 - MORTAR SHALL NOT BE ALLOWED TO DRY OUT DURING USE AND SHALL BE PREPARED AT INTERVALS BEFORE BEING PLACED IN JOINTS. RETEMPERING, OR ADDING MORE WATER SHALL NOT BE PERMITTED.
- A. REPOINT ONLY WHEN THE AMBIENT TEMPERATURE WILL REMAIN BETWEEN 41' AND 86' FAHRENHEIT FOR SEVERAL DAYS FOLLOWING THE PROCEDURE.
- B. BUILD UP AREAS THAT REQUIRE LARGE REPAIRS AT 18 TO 24 INCH INCREMENTS.
- C. MEASURE AND MIX MORTAR COMPONENTS CAREFULLY TO INSURE UNIFORMITY OF VISUAL AND PHYSICAL CHARACTERISTICS. MEASURE DRY INGREDIENTS BY VOLUME AND THOROUGHLY MIX THEM BEFORE ADDING WATER. AFTER DRY MIXING, ADD HALF THE WATER NEEDED AND MIX FOR APPROXIMATELY FIVE MINUTES. THEN ADD THE REMAINING WATER IN SMALL INCREMENTS UNTIL DESIRED CONSISTENCY AND STIFFNESS IS OBTAINED.
- D. REPOINT USING A MORTAR THAT IS COMPATIBLE WITH THE EXISTING MORTAR AND MATCHES IT IN COLOR, TEXTURE AND
- E. REMOVE ALL DETERIORATED AND LOOSE MORTAR TO A MINIMUM DEPTH OF 2 TO 2.5 TIMES THE WIDTH TO REACH SOUND MORTAR.
- F. CLEAN MORTAR JOINTS USING HAND TOOLS SUCH AS A TROWEL, HAND CHISEL AND HAMMER OR SMALL PNEUMATIC CHISEL. THE USE OF POWER SAWS AND GRINDERS IS NOT PERMITTED. REMOVE MORTAR CLEANLY, LEAVING SQUARE SHAPED CUTS AT THE REAR OF THE JOINT.
- G. RAKE OUT LOOSE MATERIAL USING A NATURAL BRISTLE, NYLON BRUSH, OR LOW-PRESSURE COMPRESSED AIR (40 TO 60 PSI). LOW PRESSURE WATER (MAXIMUM PRESSURE 400 PSI) MAY ALSO BE USED. CARE AND CAUTIOUS ATTENTION SHALL BE TAKEN NOT TO SCOUR ADDITIONAL BEDDING MORTAR OR MATERIAL OUT OF
- H. DAMPEN MASONRY SURFACES AND JOINTS WITH A SPRAY BOTTLE BEFORE PLACING THE REPOINTING MORTAR TO CONTROL SUCTION AND EVAPORATION. THE JOINTS SHALL BE DAMP BUT NO STANDING WATER PRESENT.
- . PLACE NEW MORTAR TO 11/2 INCHES FROM THE FACE OF THE STONE. COMPACT MORTAR IN SUCCESSIVE LAYERS AND ALLOW EACH LAYER TO REACH THUMBPRINT HARDNESS BEFORE THE NEXT LAYER IS APPLIED. HAND POINTING IS PREFERRED BUT A PRESSURE GUN MAY BE USED BY EXPERIENCED OPERATORS.
- J. FINISH POINT THE REMAINING 11/2 INCHES. FINISH POINT BY HAND USING A POINTING TOOL. INSTALL THE MORTAR IN THE OUTER 3/4 INCHES IN 1/4 INCH LIFTS. COMPACT EACH LAYER AND ALLOW TO DRY TO THUMBPRINT HARDNESS BEFORE APPLYING THE NEXT LAYER. THE KEY POINTING MUST MATCH THE EXISTING FINISH AND TOOLING. THE FINISH MUST MATCH THE STONE FACE OR BE SLIGHTLY CONCAVE.
- K. DO NOT FINISH POINT UNTIL ALL CONSTRUCTION IS COMPLETED.
- L. MATCH THE WIDTH OF THE REPOINTED JOINTS TO THE WIDTH OF THE EXISTING JOINTS.
- M. CLEAN EXCESS MORTAR FROM THE ADJACENT MASONRY IMMEDIATELY AFTER REPOINTING. USE A NATURAL BRISTLE OR NYLON BRUSH AND WOOD OR PLASTIC TOOLS, EXERCISE CARE NOT TO DAMAGE NEWLY POINTED JOINTS.
- N. COMPACT JOINTS BY TAMPING BACK WITH A STIFF NYLON BRUSH AFTER MORTAR HAS BEGUN HARDENING (AFTER APPROXIMATELY 12 HOURS).

- O. PROTECT THE FINISHED WORK FROM DIRECT SUN AND RAIN FOR APPROXIMATELY 48 HOURS.
- P. CLEAN EXPOSED SURFACES USING A NATURAL BRISTLE OR STIFF NYLON BRUSH AND CLEAN, LOW-PRESSURE WATER (MAXIMUM 400 PSI) AFTER MORTAR HAS CURED FOR 7 TO 14 DAYS.
- Q. DO NOT USE METAL SCRAPERS, METAL BRUSHES OR ACID OR

ALKALI CLEANING AGENTS.

- R. DO NOT ALLOW MORTAR TO DRY OUT DURING USE. MORTAR SHALL BE REWORKED AT INTERVALS BEFORE PLACING IN JOINTS. RETEMPERING SHALL NOT BE PERMITTED.
- 36. STONE REPLACEMENT PROCEDURE NOTES-MISSING/LOOSE STONES: THIS PROCEDURE IS VALID TO FILL IN VOIDED AREAS (AREAS WITH MISSING STONES) WITH NEW STONES AND/OR TO REMOVE AND RESET MISSING LOOSE STONES.
- A. REPLACE MISSING STONES WITH THE ORIGINAL STONES IF
- REPLACEMENT STONES MUST MATCH THE EXISTING STONES IN TYPE, SIZE, TEXTURE/FINISH AND COLOR.
- REPLACEMENT STONES MUST BE CLEAN, DURABLE, PROPERLY QUARRIED, AND FREE FROM STRUCTURAL DEFECTS.
- B. THOROUGHLY CLEAN ALL STONES AND RECEIVING SURFACES WITH LOW PRESSURE WATER (MAXIMUM 400 PSI).
- C. THOROUGHLY SATURATE ALL STONES WITH CLEAN WATER PRIOR TO BEGINNING OF WORK. NO STANDING WATER SHALL BE
- D. IF MORTAR IS INDICATED, APPLY A LINING OF BEDDING MORTAR TO THE SURFACE OF THE HOLE TO BE FILLED.
- E. LAY STONES SO THAT THEY WOULD STAY IN PLACE WITHOUT THE USE OF MORTAR, LAY STONES WITH THE NATURAL STRATIFICATION PARALLEL TO THE BEDDING PLANE. STONES SHALL BE WELL BEDDED AND PLACED WITHOUT HAMMERING OR JARRING ANY MASONRY ALREADY IN PLACE.
- F. IF MORTAR IS INDICATED, REPOINT USING THE PROCEDURE OUTLINED IN "MORTAR REPAIR CRITERIA AND REPOINTING NOTES" AFTER THE BEDDING MORTAR HAS CURED.
- G. DO NOT USE CONCRETE, SHOTCRETE/GUNITE OR OTHER STRUCTURALLY OR HISTORICALLY INAPPROPRIATE MATERIAL TO FILL IN MISSING STONES.
- 37. RESETTING OF LOOSE STONES-PROCEDURE NOTES: A. CAREFULLY REMOVE AND CLEAN LOOSE STONES THAT WILL BE RESET, AND ENSURE THAT NO DAMAGE IS DONE TO ADJOINING MASONRY WHEN REMOVING LOOSE STONES.
- B. CLEAN OFF THE RECEIVING SURFACES, AND LOOSE MORTAR (IF APPLICABLE) USING LOW PRESSURE WATER (MAXIMUM PRESSURE OF 400 PSI).
- C. TO COMPLETE THE PLACEMENT OPERATION OF LOOSE STONES, FOLLOW INSTRUCTION AS SPECIFIED IN "STONE REPLACEMENT PROCEDURE NOTES - MISSING/LOOSE STONES".


38. CONSTRUCTION ACCESS:

THE CONTRACTOR SHALL PERFORM ALL WORK WITH HEAVY MACHINERY AND EQUIPMENT FOR THE RESTORATION OF THE SEAWALLS AT LOCATIONS 2 & 3 FROM THE WATER SIDE. THE CONTRACTOR SHALL BE RESPONSIBLE FOR DETERMINING ACCESS REQUIREMENTS FOR ANY WORK TO BE PERFORMED FROM BARGES.

- 39. THE CONTRACTOR SHALL TAKE MEASURES TO PROTECT ALL GARDENS, FOUNTAINS, LIGHTING, PAVING, AND OTHER LANDSCAPING ELEMENTS LOCATED AT THE HARBOR CLUB DURING CONSTRUCTION. ANY DAMAGE SHALL BE REPAIRED TO THE SATISFACTION OF THE ENGINEER. AT NO COST TO THE COUNTY.
- 40. THE CONTRACTOR SHALL KEEP THE WORK AREA AROUND THE HARBOR CLUB CLEAN, NEAT, AND FREE FROM DEBRIS, WHEN WORK IS NOT BEING PERFORMED, THE WORK AREA MUST BE SAFE AND PRESENTABLE.
- 41. AN AREA IN ONE OF THE LOTS ON THE ISLAND WILL BE DESIGNATED FOR USE AS A CONSTRUCTION STAGING AREA.

42. UTILITY NOTES

- A. THE CONTRACTOR SHALL VERIFY THE LOCATIONS OF ALL EXISTING UTILITIES WITHIN THE LIMITS OF THE CONTRACT. ANY DAMAGE DONE TO EXISTING UTILITIES AS A RESULT OF THE CONTRACTOR'S OPERATIONS SHALL BE REPAIRED BY HIM AT NO COST TO THE OWNER.
- B. THE CONTRACTOR SHALL COORDINATE HIS WORK WITH THE UTILITY COMPANIES TO PROTECT AND MAINTAIN THEIR FACILITIES.

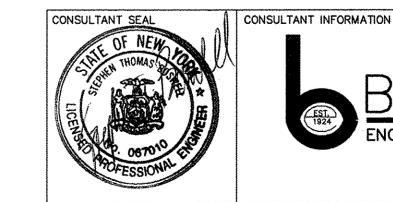

OSWELL ENGINEERING

ENGINEERS - SURVEYORS - PLANNERS - SCIENTISTS 330 PHILLIPS AVENUE, SOUTH HACKENSACK, N.J. 07606 TEL: (201) 641-0770 • FAX: (201) 641-1831 N.J. CERTIFICATE OF AUTHORIZATION NO. 24GA27958000

SHEET NUMBER

02

15 - 531

DPW FILE NO.

SHEET NO. 2 OF 34

5-18-G-100

SCALE: AS NOTED

DATE: MAY, 2018

WESTCHESTER COUNTY, NEW YORK RECORD DRAWING CERTIFICATION DEPARTMENT OF PUBLIC WORKS AND TRANSPORTATION AS BUILT - CHANGES AS NOTED AS BUILT - NO CHANGES DIVISION OF ENGINEERING CONTRACTOR PROJECT COORDINATOR SUPERSTORM SANDY REHABILITATION NAME GLEN ISLAND PARK SEAWALLS AND PAVILIONS NAME NEW ROCHELLE, NEW YORK SIGNATURE SIGNATURE MADE APP'D DATE REVISION GENERAL NOTES TITLE DATE DATE

ITEM NUMBER	ITEM DESCRIPTION	QUANTITY	UNIT
699.040001	MOBILIZATION	1	L.S.
	MISCELLANEOUS ADDITIONAL WORK	1	F.L.S.
	TESTING OF MATERIALS AND FIELD TESTING EQUIPMENT	1	F.L.S.
	LOCATION 1		
203.02	UNCLASSIFIED EXCAVATION AND DISPOSAL	40	C.Y.
209.13	SILT FENCE-TEMPORARY	150	L.F.
304.11	SUBBASE COURSE, TYPE 1	14	C.Y.
553.030001	TEMPORARY WATER DIVERSION STRUCTURE	1 1	EACH
556.0203	GALVANIZED BAR REINFORCEMENT FOR CONCRETE STRUCTURES	5	LBS
W559.16960025	PROTECTIVE SEALING OF STRUCTURAL CONCRETE	1,300	S.F.
W560.04030011	INSTALL NEW 4" THICK STONE COPING	21	L.F.
W560.04030013	RESET 8" THICK STONE COPING	7	L.F.
W560.04030016 560.05	REMOVE AND STORE MORTARED FIELD STONE PILASTER	18	C.Y. C.F.
560.08	RUBBLE STONE MASONRY TUCK POINTING	480	L.F.
582.07	REMOVAL OF STRUCTURAL CONCRETE-REPLACEMENT WITH VERTICAL		······································
	AND OVERHEAD PATCHING MATERIAL	300	S.F.
620.04	STONE FILLING (MEDIUM)	106	C.Y.
000.10	WEST PAVILION	_	~ · · ·
202.19	REMOVAL OF SUBSTRUCTURES	90	C.Y.
203.02	UNCLASSIFIED EXCAVATION AND DISPOSAL	210 150	L.F.
304.11	SILT FENCE-TEMPORARY SUBBASE COURSE, TYPE 1	130	C.Y.
553.030001	TEMPORARY WATER DIVERSION STRUCTURE	1	EACH
555.0104	FOOTING CONCRETE, CLASS A	25	C.Y.
555.0105	CONCRETE FOR STRUCTURES, CLASS A	55	C.Y.
W555.01050001	CONCRETE FOR STRUCTURES, CLASS A, PILASTER CORE	17	C.Y.
556.0203	GALVANIZED BAR REINFORCEMENT FOR CONCRETE STRUCTURES	12,000	LBS
W559.16960025	PROTECTIVE SEALING OF STRUCTURAL CONCRETE	2,300	S.F.
W560.04030010 W560.04030011	REMOVE, STORE AND RESET 4" THICK STONE COPING INSTALL NEW 4" THICK STONE COPING	28 50	L.F.
W560.04030011	REMOVE, DISPOSE AND INSTALL NEW 8" THICK CAP	17	L.F.
W560.04030016	REMOVE AND STORE MORTARED FIELD STONE PILASTER	17	C.Y.
W560.04030017	INSTALL MORTARED FIELD STONE VENEER	490	S.F.
620.04	STONE FILLING (MEDIUM)	100	C.Y.
	LOCATION 2		
203.02	UNCLASSIFIED EXCAVATION AND DISPOSAL	501	
203.07	SELECT GRANULAR FILL	501	C.Y.
209.13	SILT FENCE-TEMPORARY COFFERDAMS (TYPE 1)	200	L.F.
553.020001 560.05	RUBBLE STONE MASONRY	1 10	EACH
560.05	RUBBLE STONE MASONRY LAID DRY	200	C.F.
W560.04030010	REMOVE AND RESET 4" THICK STONE COPING	152	L.F.
W560.05010014	REMOVE AND RESET MORTARED FIELD STONE WALL	28	C.Y.
W560.06010015	REMOVE AND RESET DRY-LAID STONE WALL	15	C.Y.
W 560.07020018	REMOVE, DISPOSE AND REPLACE PRECAST CONCRETE COPING	225	L.F.
W568.94	REMOVE AND REPLACE PEDESTRIAN RAILING ON SEAWALL	130	L.F.
W568.95 576.10	REMOVE AND REPLACE PEDESTRIAN RAILING DRAINAGE TROUGH	152 350	L.F.
583.03	REMOVAL OF STRUCTURAL CONCRETE - REPLACEMENT WITH	7,000	L.F. S.F
303.03	SHOTCRETE, WITH REINFORCEMENT BAR ENCASEMENT	7,000	5.1
W604.51100010	FLEXIBLE CHECK VALVE	13	EACH
W608.103	REMOVE AND REPLACE CONCRETE SIDEWALK	84	C.Y.
W620.0601	EXTRA HEAVY STONE FILLING	2,100	C.Y.
W620.0502	REMOVE AND RESET EXISTING STONE FILLING (HEAVY)	2,900	C.Y.
620.08 W670.200201	BEDDING MATERIAL	350	C.Y.
W670.200201 W670.50110101	REMOVE AND INSTALL NEW CONDUIT AND JUNCTION BOXES REMOVE AND REINSTALL EXISTING LUMINAIRES	40	EACH
, 0.00110101	LOCATION 3	10	LACIT
201.06	CLEARING AND GRUBBING	1	L.S.
203.02	UNCLASSIFIED EXCAVATION AND DISPOSAL	80	C.Y.
203.07	SELECT GRANULAR FILL	13	C.Y.
209.13	SILT FENCE-TEMPORARY	200	L.F.
553.020001	COFFERDAMS (TYPE 1)	1 1	EACH
560.05 560.06	RUBBLE STONE MASONRY	50 350	C.F.
W560.04030010	RUBBLE STONE MASONRY LAID DRY REMOVE AND RESET 4" THICK STONE COPING	190	L.F.
W560.04030010	INSTALL 4" THICK STONE COPING	40	L.F.
W560.06010015	REMOVE AND RESET DRY-LAID STONE WALL	11	C.Y.
W 560.07020018	REMOVE, DISPOSE, AND REPLACE CONCRETE COPING	4	L.F.
W568.95	REMOVE AND REPLACE PEDESTRIAN RAILING	180	L.F.
583.03	REMOVAL OF STRUCTURAL CONCRETE - REPLACEMENT WITH	1,100	S.F
W604.51100010	SHOTCRETE, WITH REINFORCEMENT BAR ENCASEMENT	3 1	EACH
W608.103	REMOVE AND REPLACE CONCRETE SIDEWALK	1 13	C.Y.
610.1403	TOPSOIL-LAWNS	120	C.Y.
610.16025	TURF ESTABLISHMENT-LAWNS	60	S.Y.
W620.0601	EXTRA HEAVY STONE FILLING	460	C.Y.
W620.0502	REMOVE AND RESET EXISTING STONE FILLING (HEAVY)	1,200	C.Y.
W670.200201	REMOVE AND REINSTALL NEW CONDUIT AND JUNCTION BOXES	1 1	L.S.
	REMOVE AND REINSTALL EXISTING LUMINAIRES	18	EACH

COMPLIANCE WITH ENVIRONMENTAL PERMITS:

- 1. THE PERMIT CONDITIONS OUTLINED IN THESE NOTES ARE FOR INFORMATION PURPOSES ONLY. THE CONTRACTOR IS RESPONSIBLE FOR READING AND COMPLYING WITH ALL CONDITIONS STIPULATED IN THE PERMITS ISSUED BY THE REGULATORY AGENCIES. PERMITS OBTAINED INCLUDE: USACE NAN-2017-00464 NYSDEC 3-5510-00258/00010
 - 3-5510-00258/00011 3-5510-00258/00012 NYSDOS F-2017-0763
- 2. THE PLANS CONTAINED HEREIN WERE PREPARED IN ACCORDANCE WITH THE ENVIRONMENTAL PERMIT(S). THE CONTRACTOR SHALL NOTIFY THE ENGINEER IMMEDIATELY OF ANY DISCREPANCIES BETWEEN THE PLANS AND PERMIT(S). WORK PERFORMED BY CONTRACTOR WHICH IS FOUND NONCOMPLIANT WITH PERMIT CONDITIONS SHALL BE REMOVED BY THE CONTRACTOR AT NO ADDITIONAL COST.
- 3. CONTRACTOR IS RESPONSIBLE FOR CONSPICUOUSLY POSTING THE PERMIT SIGN ENCLOSED WITH THE PERMIT(S) IN A PUBLICLY ACCESSIBLE LOCATION AND MAINTAINING A COPY OF THE ENVIRONMENTAL PERMIT(S) ON SITE AT ALL TIMES.
- 4. NOTICE TO COMMENCE WORK: THE OWNER IS RESPONSIBLE FOR NOTIFYING THE REGULATORY AGENCIES AT LEAST 48 HOURS PRIOR TO START OF WORK. CONTRACTOR SHALL PROVIDE OWNER WITH AN INTENDED WORK COMMENCEMENT SCHEDULE PER CONTRACT REQUIREMENTS.
- 6. ALL NECESSARY PRECAUTIONS SHALL BE TAKEN TO PRECLUDE CONTAMINATION OF ANY WETLAND OR WATERWAY BY SUSPENDED SOLIDS, SEDIMENTS, FUEL, SOLVENTS, LUBRICANTS, EPOXY COATINGS, PAINTS, CONCRETE, LEACHATE OR ANY OTHER ENVIRONMENTALLY DELETERIOUS MATERIALS ASSOCIATED WITH THE PROJECT.
- 7. NO SITE PREPARATION WORK SHALL BE UNDERTAKEN UNTIL ALL REQUIRED EROSION CONTROL MEASURES HAVE BEEN INSTALLED.
- 8. NOTICE OF PROJECT COMPLETION: THE CONTRACTOR SHALL NOTIFY THE REGULATORY AGENCIES UPON COMPLETION OF WORK.

RECORD DRAWING CERTIFICATION

SIGNATURE

PROJECT COORDINATOR

AS BUILT - CHANGES AS NOTED

CONTRACTOR

AS BUILT - NO CHANGES

ENGINEERS - SURVEYORS - PLANNERS - SCIENTISTS

330 PHILLIPS AVENUE, SOUTH HACKENSACK, N.J. 07606
TEL: (201) 641-0770 • FAX: (201) 641-1831
N.J. CERTIFICATE OF AUTHORIZATION NO. 24GA27958000

WESTCHESTER COUNTY, NEW YORK CONTRACT SHEET NUMBER DEPARTMENT OF PUBLIC WORKS AND TRANSPORTATION DIVISION OF ENGINEERING

15-531 03 SHEET NO. 3 OF 34

SUPERSTORM SANDY REHABILITATION GLEN ISLAND PARK SEAWALLS AND PAVILIONS NEW ROCHELLE, NEW YORK DISTRIBUTION OF QUANTITIES

SCALE: AS NOTED DATE: MAY 2018 DPW FILE NO. 5-18-G-101


UNAUTHORIZED ALTERATION OF. OR ADDITION TO THIS
PLAN IS A VIOLATION OF ARTICLE 145, SECTION 7209.2
OF THE NEW YORK STATE EDUCATION LAW.


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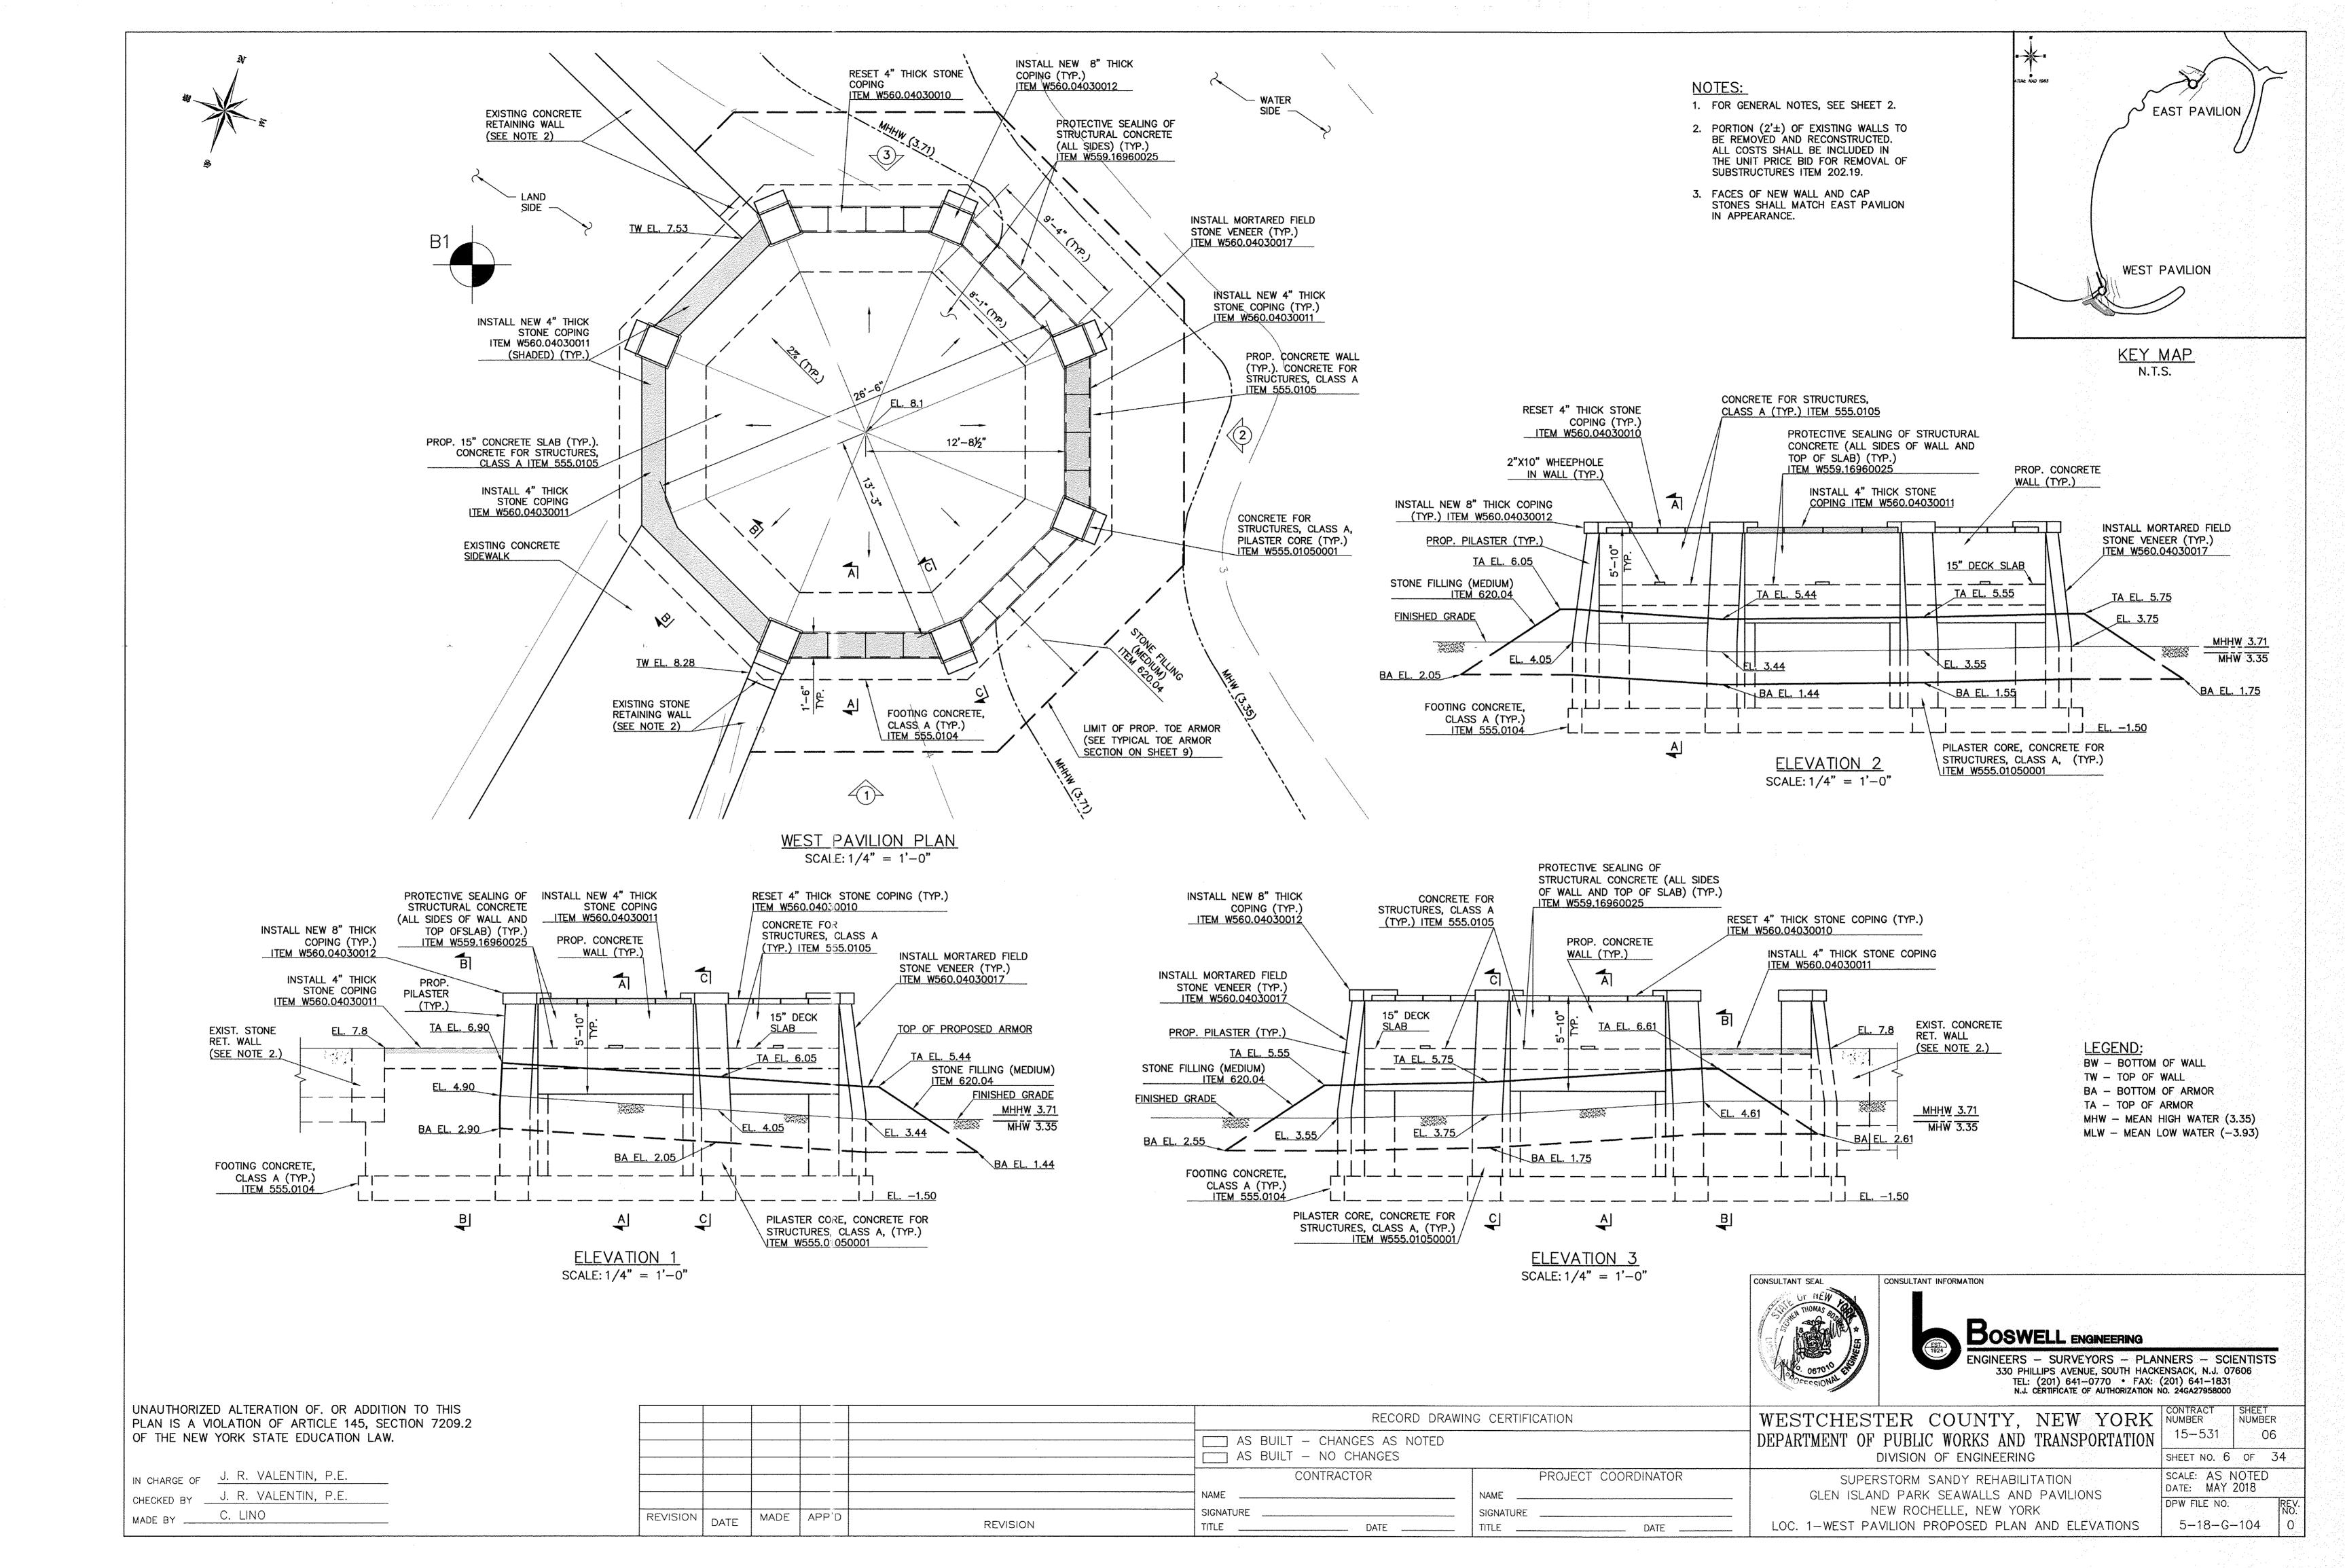
REVISION


REVISION


IN CHARGE OF	J.	R.	VALENTIN,	P.E.
CHECKED BY	J.	R.	VALENTIN,	P.E.
MADE DV	_			




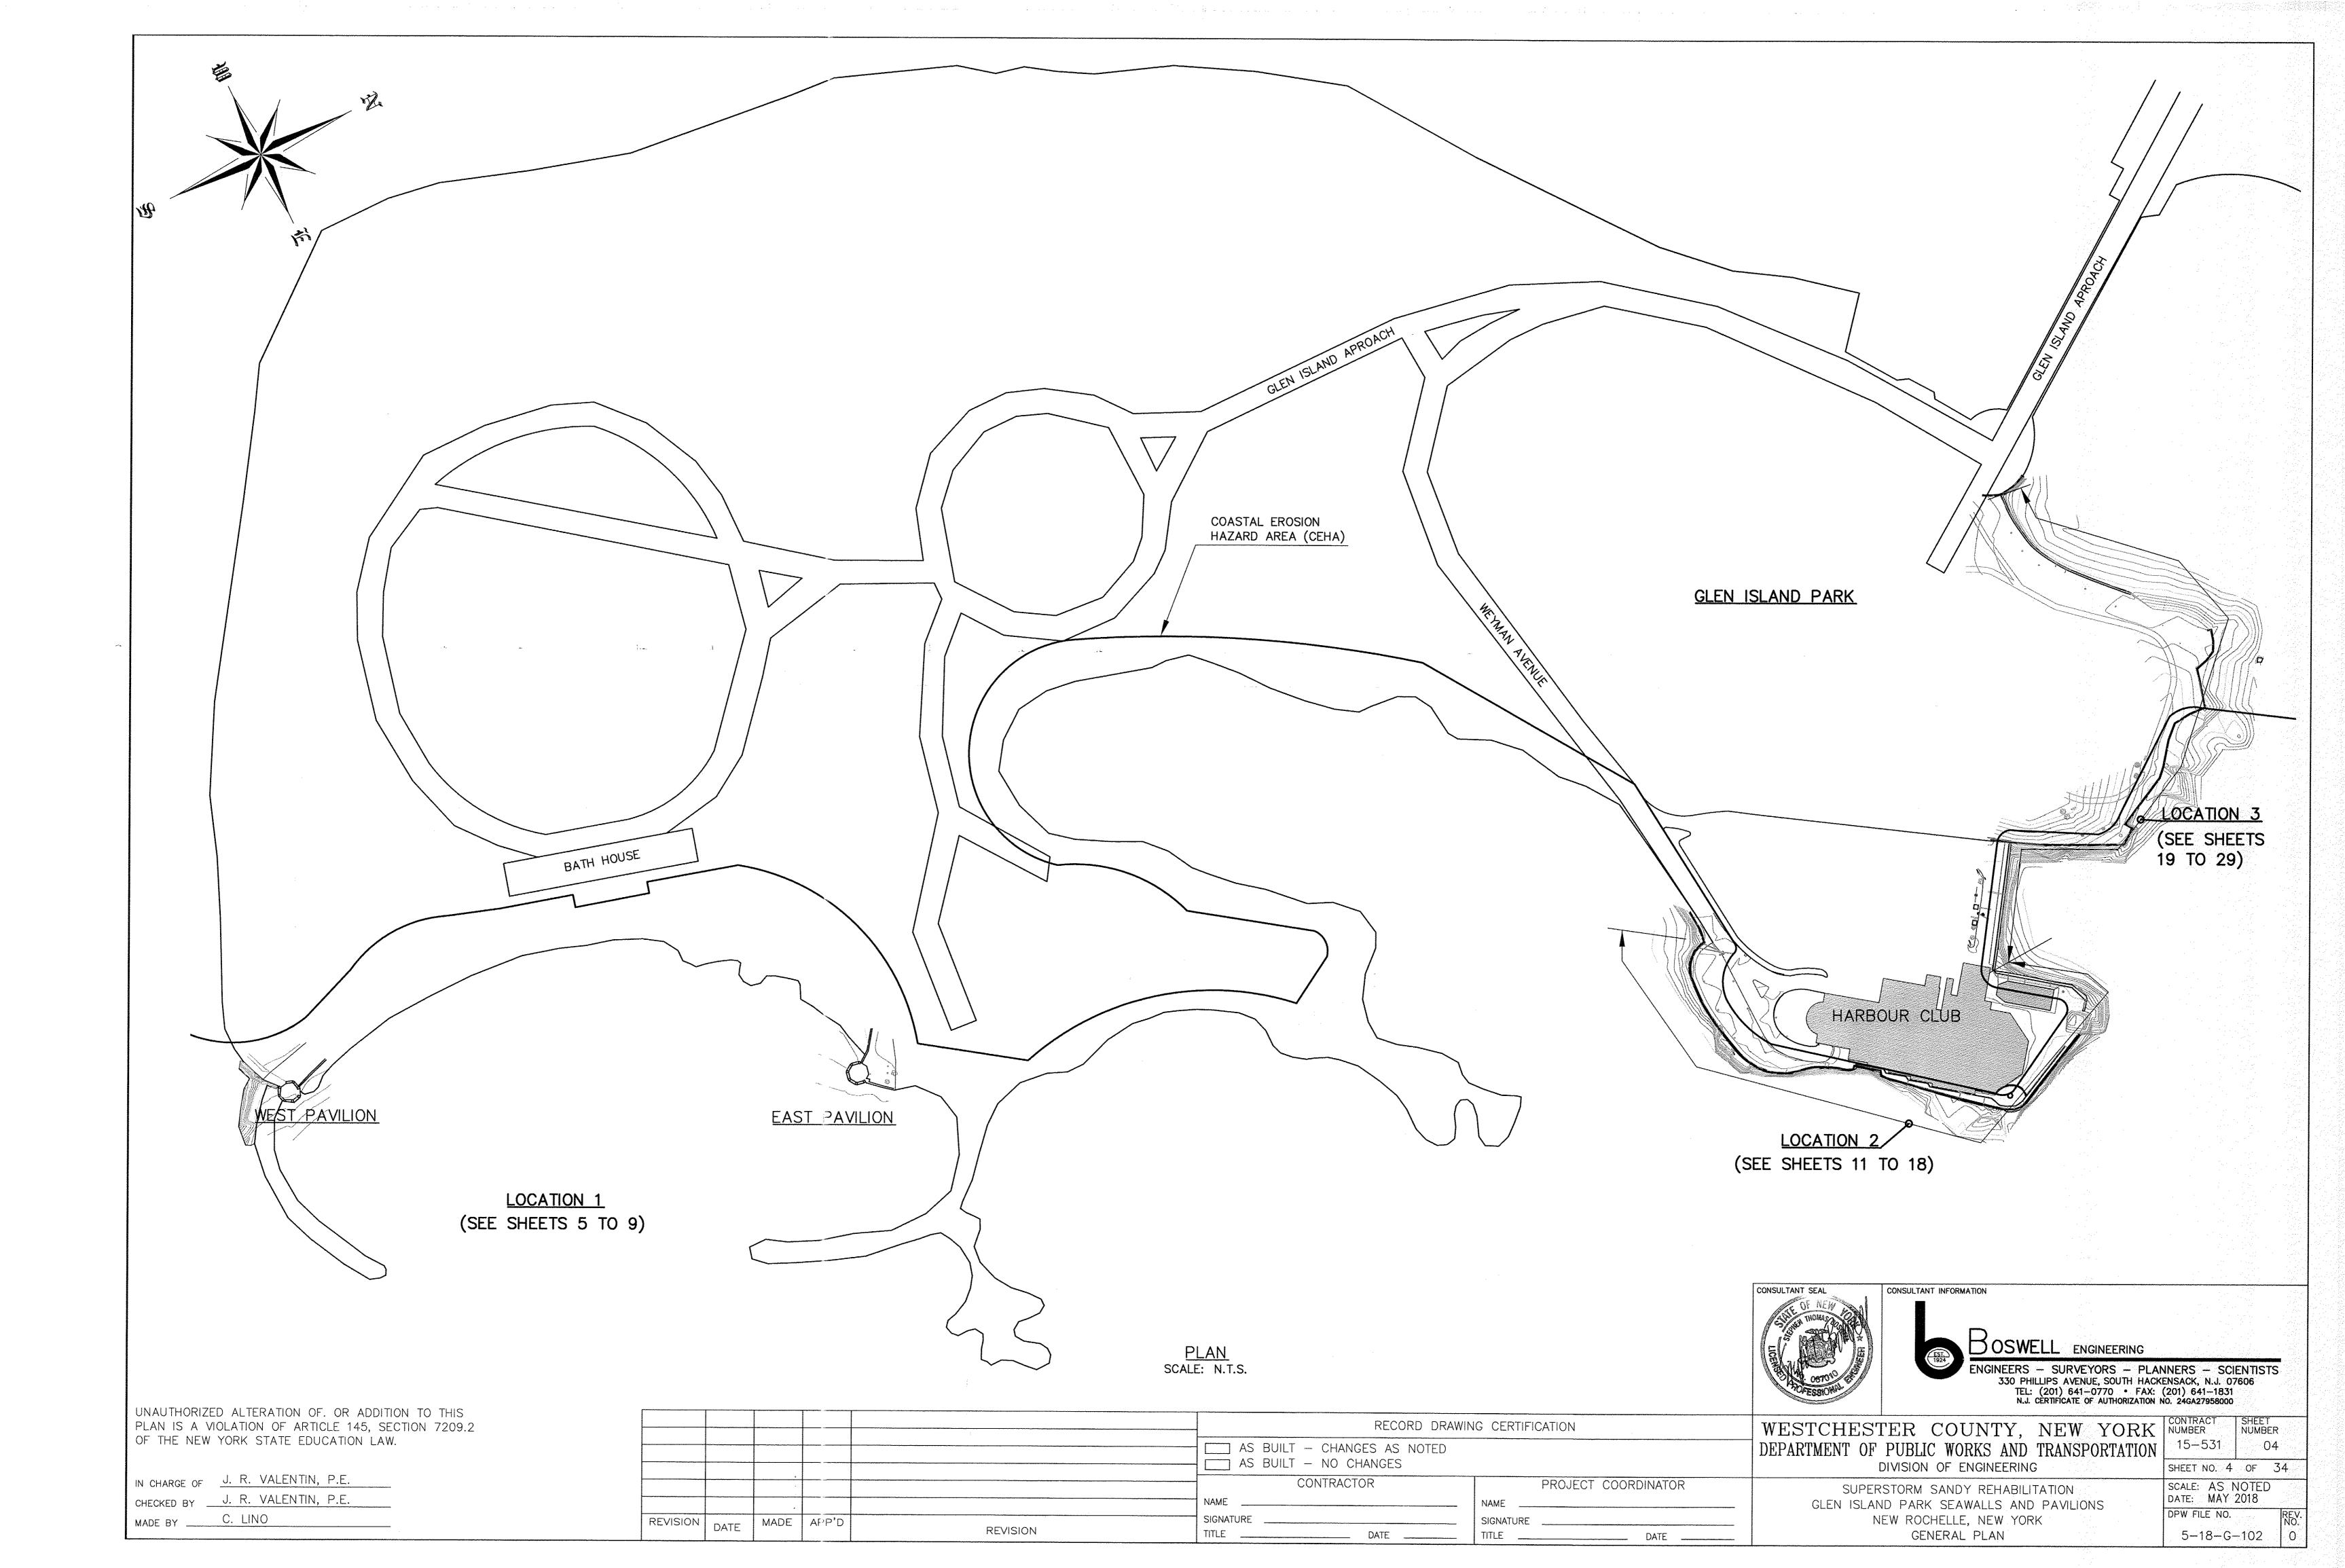


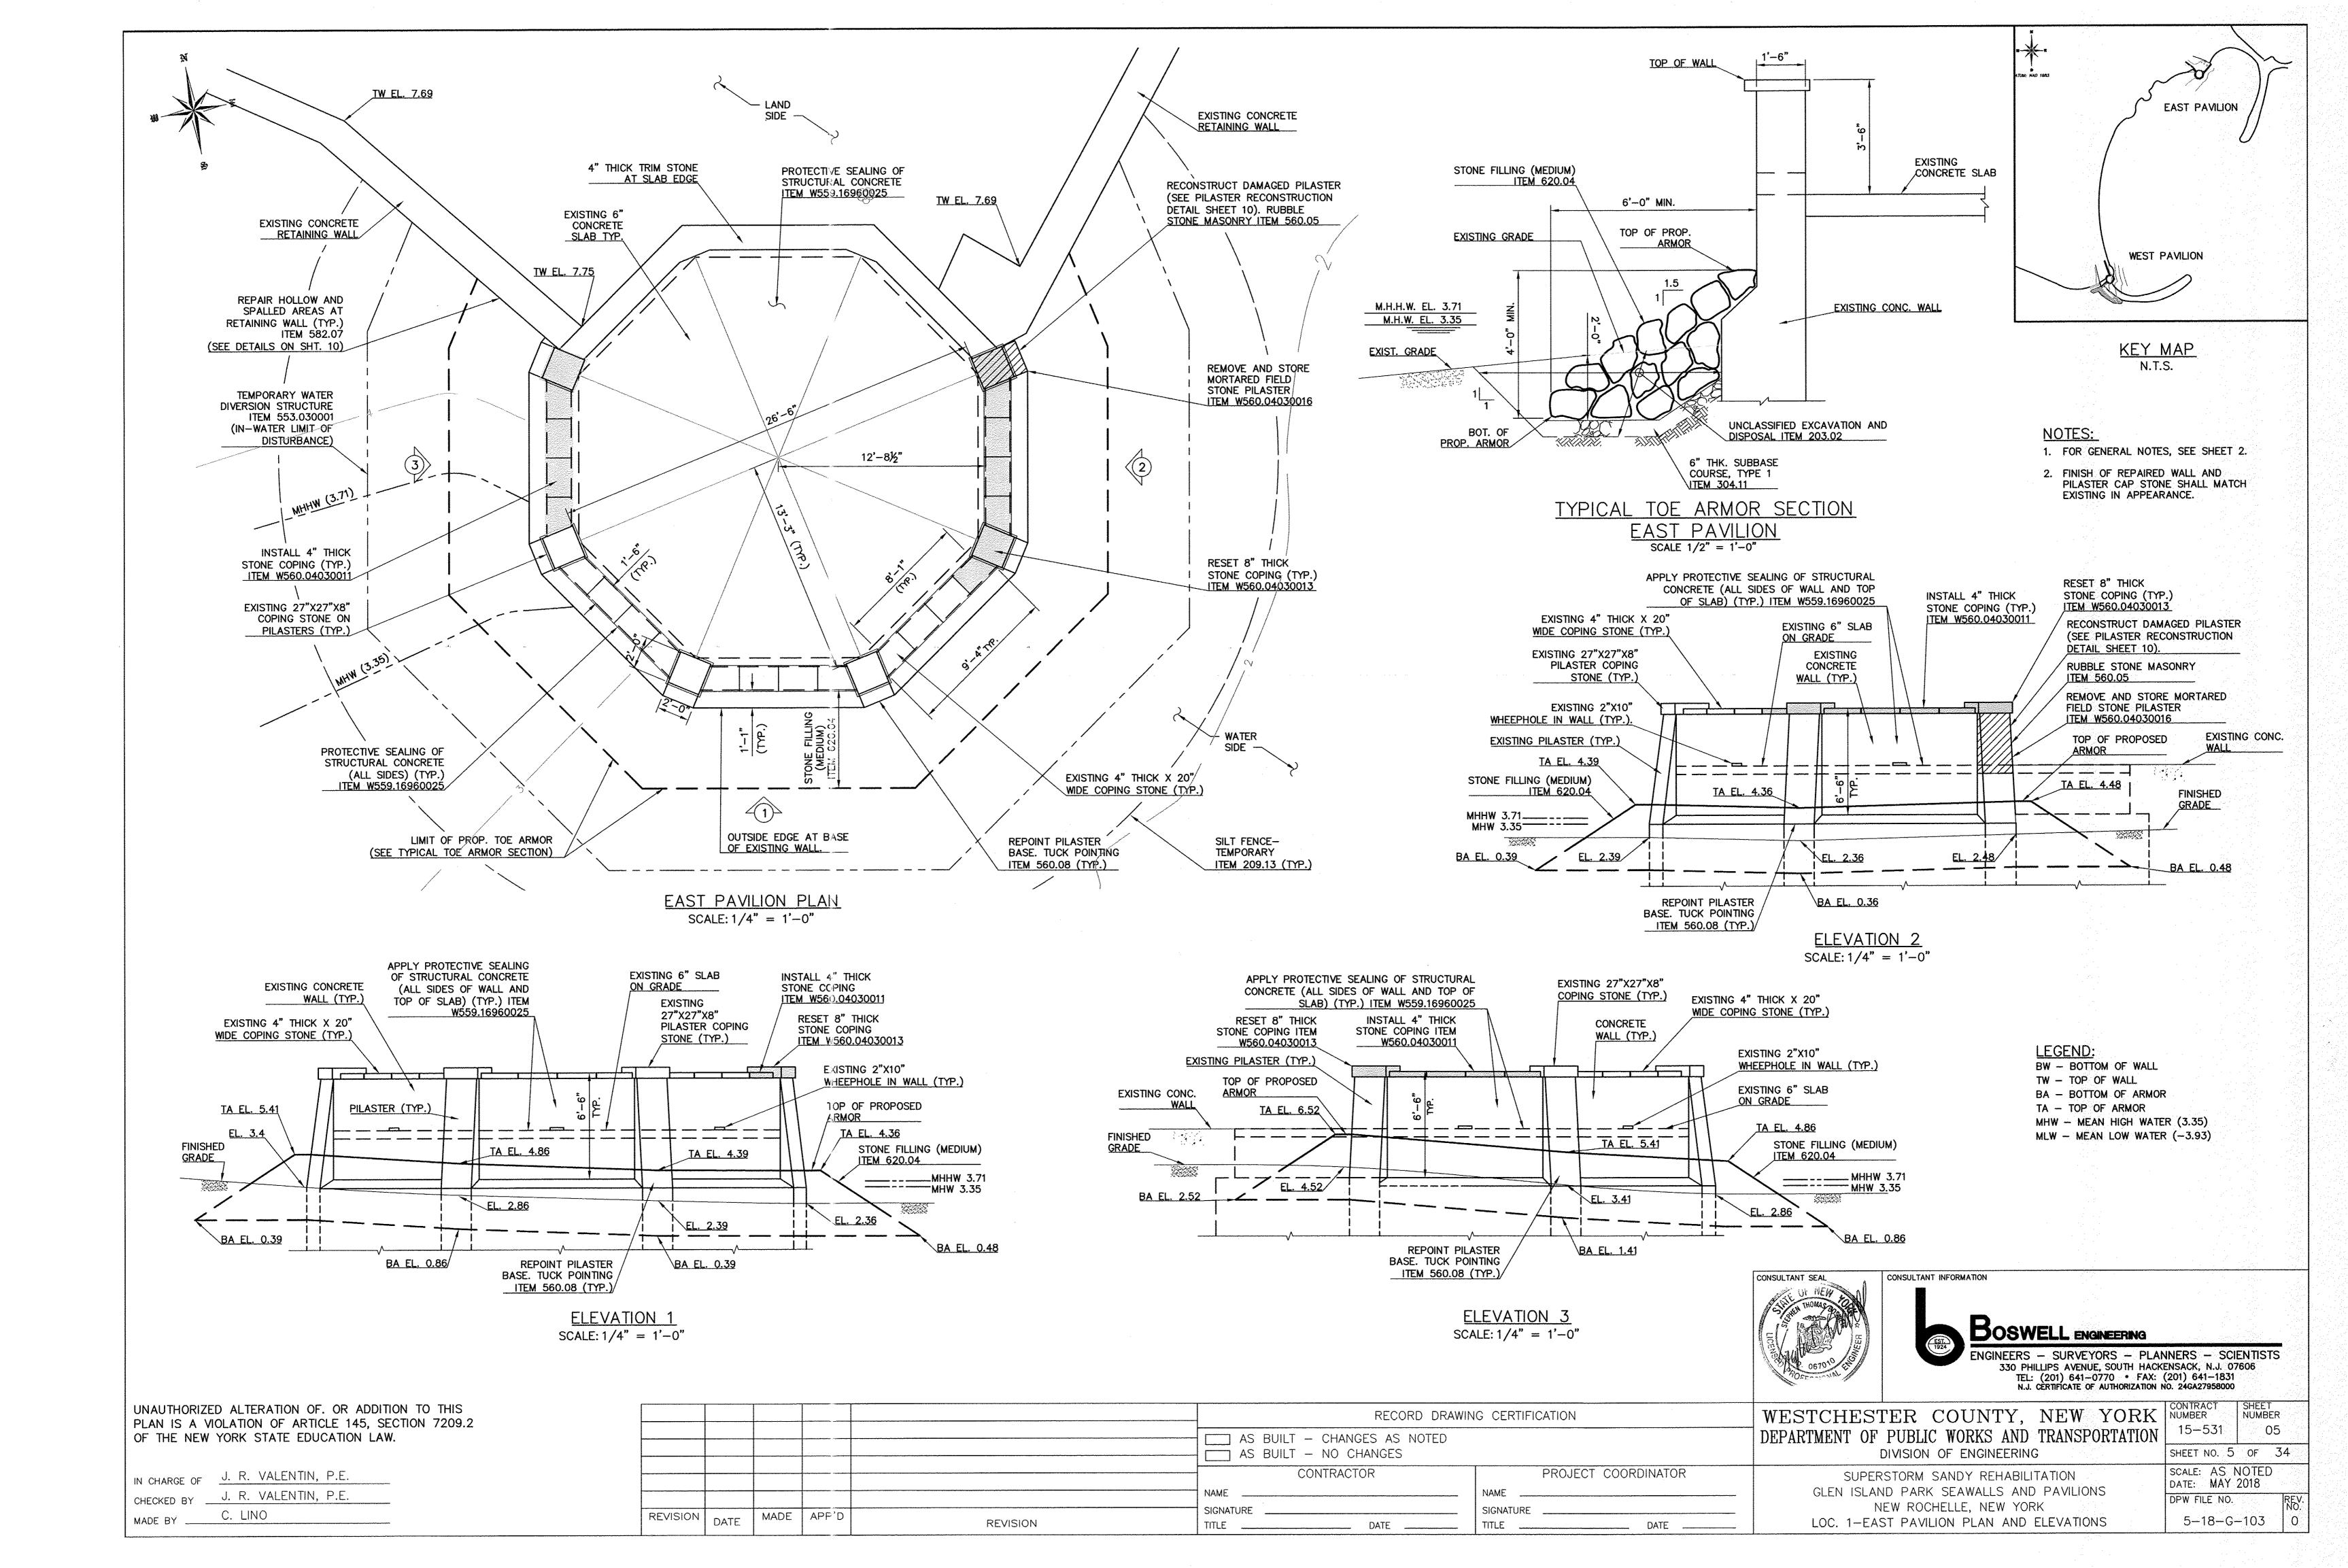

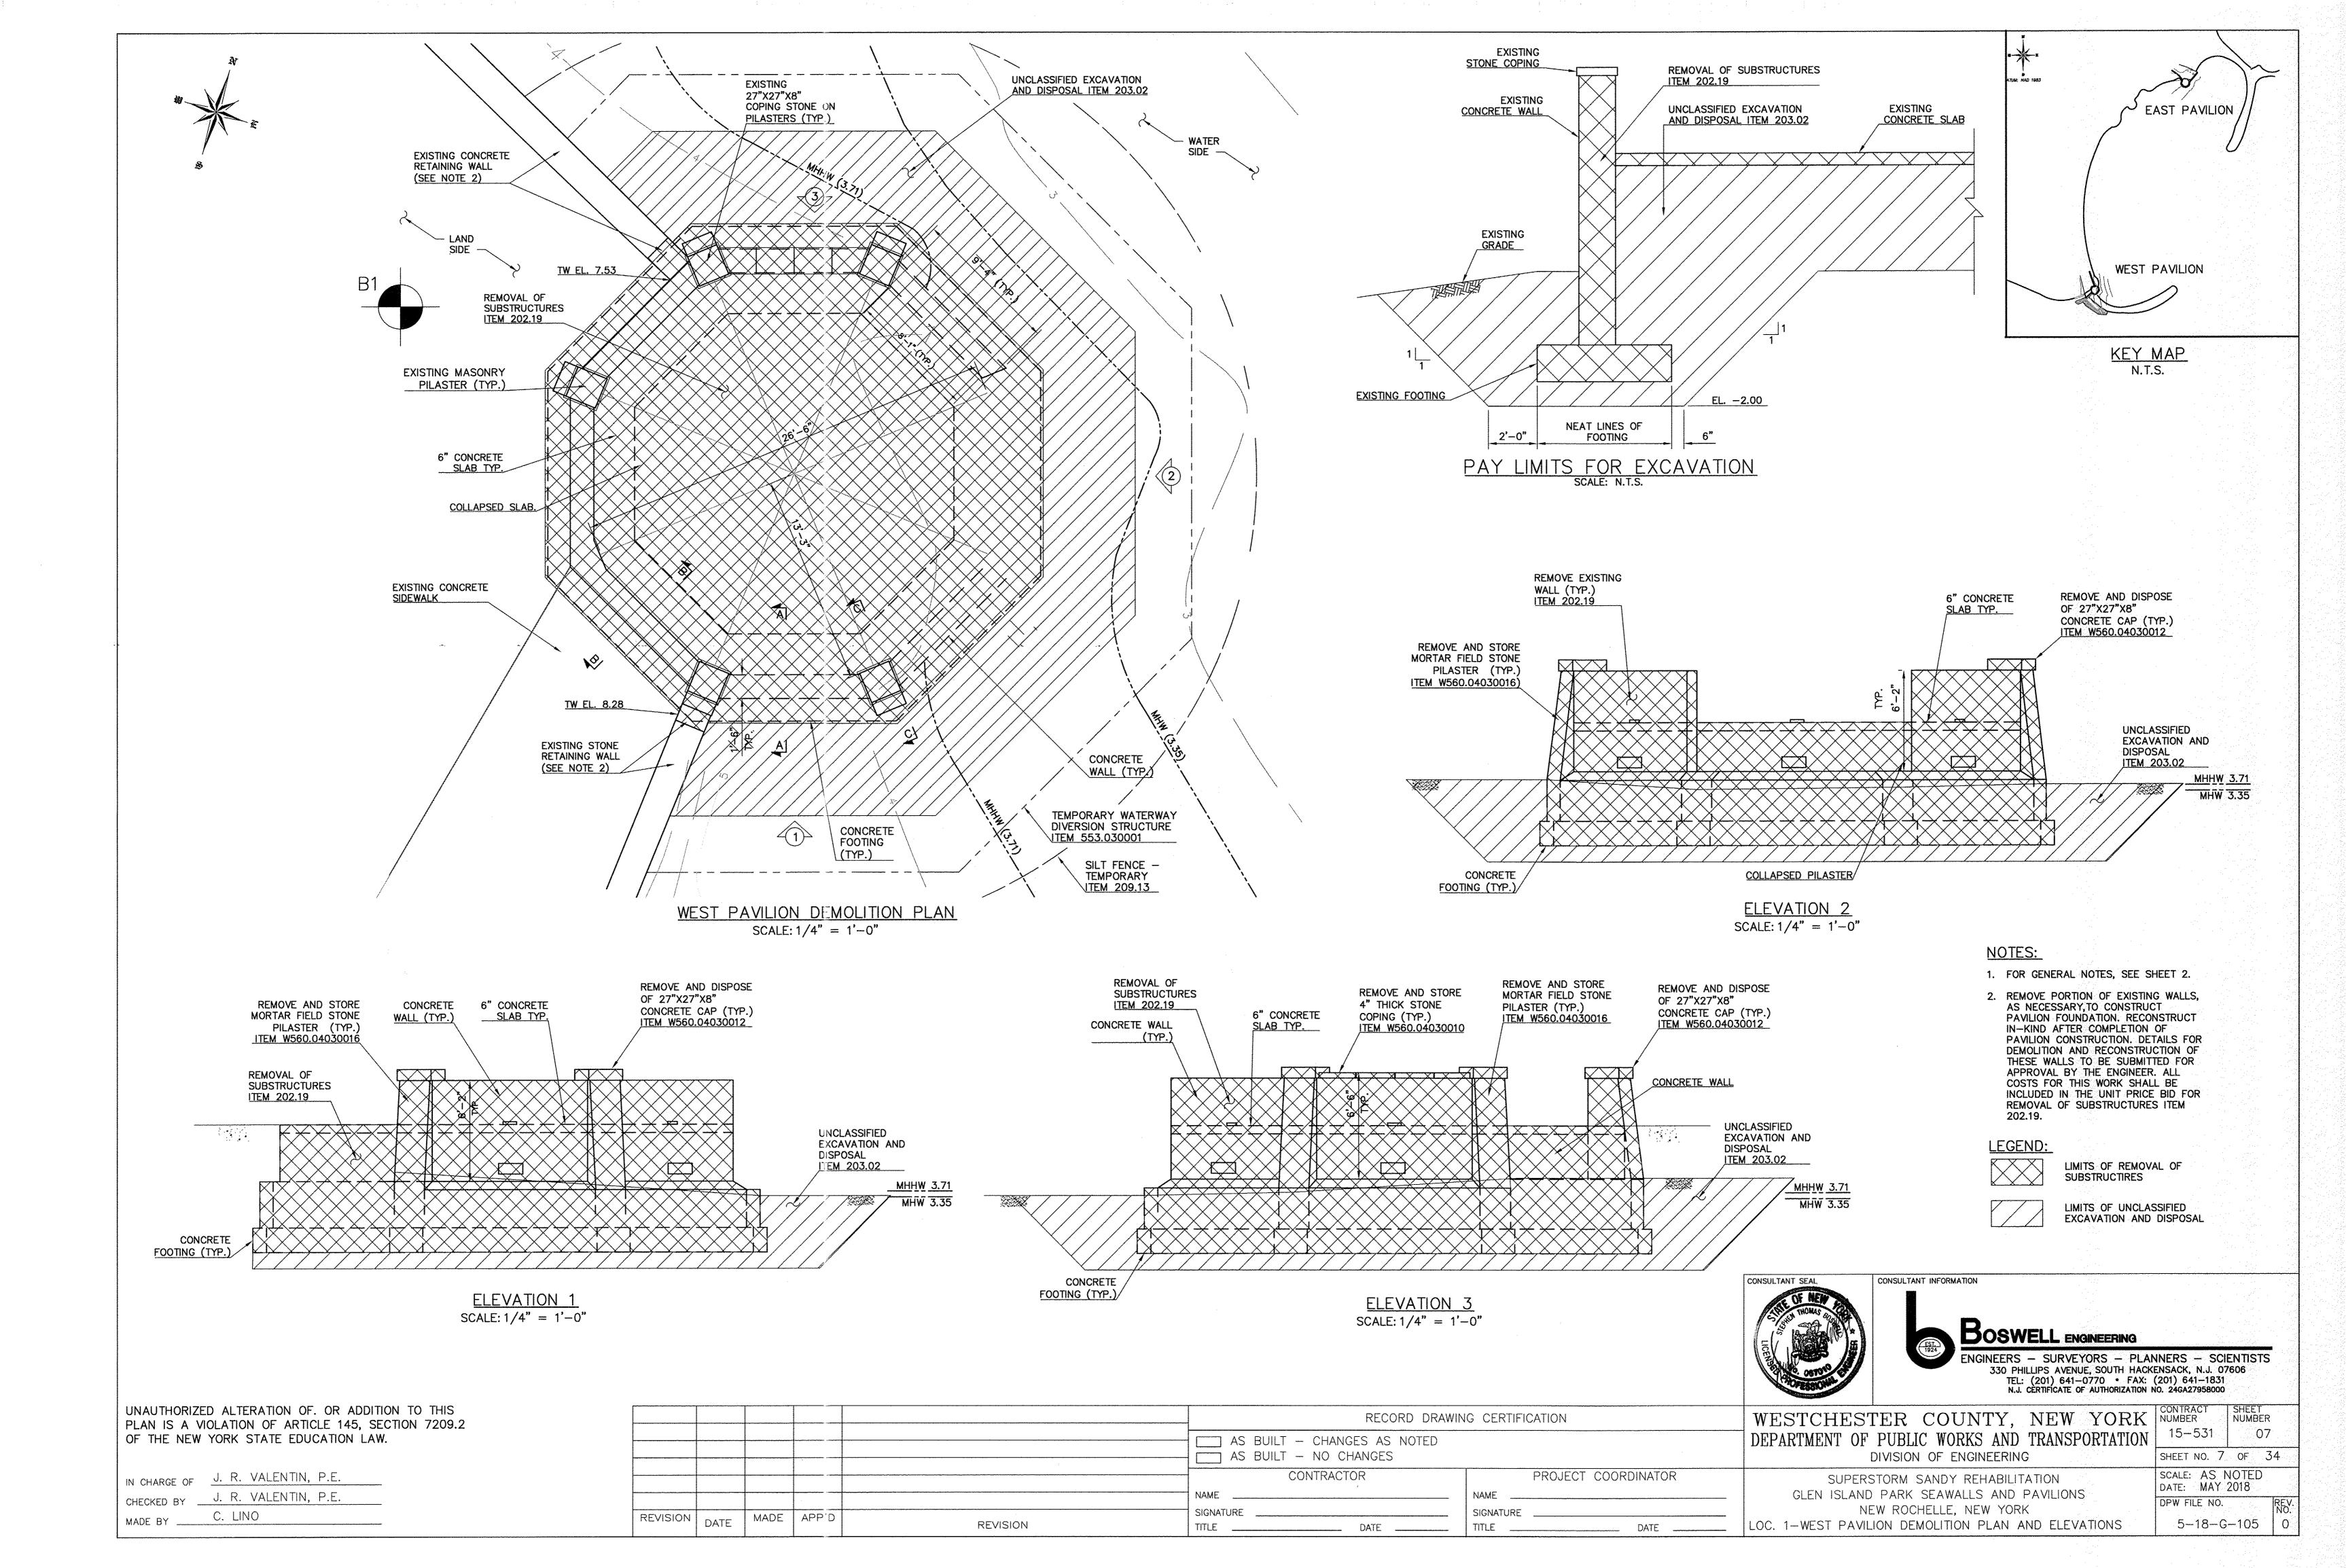


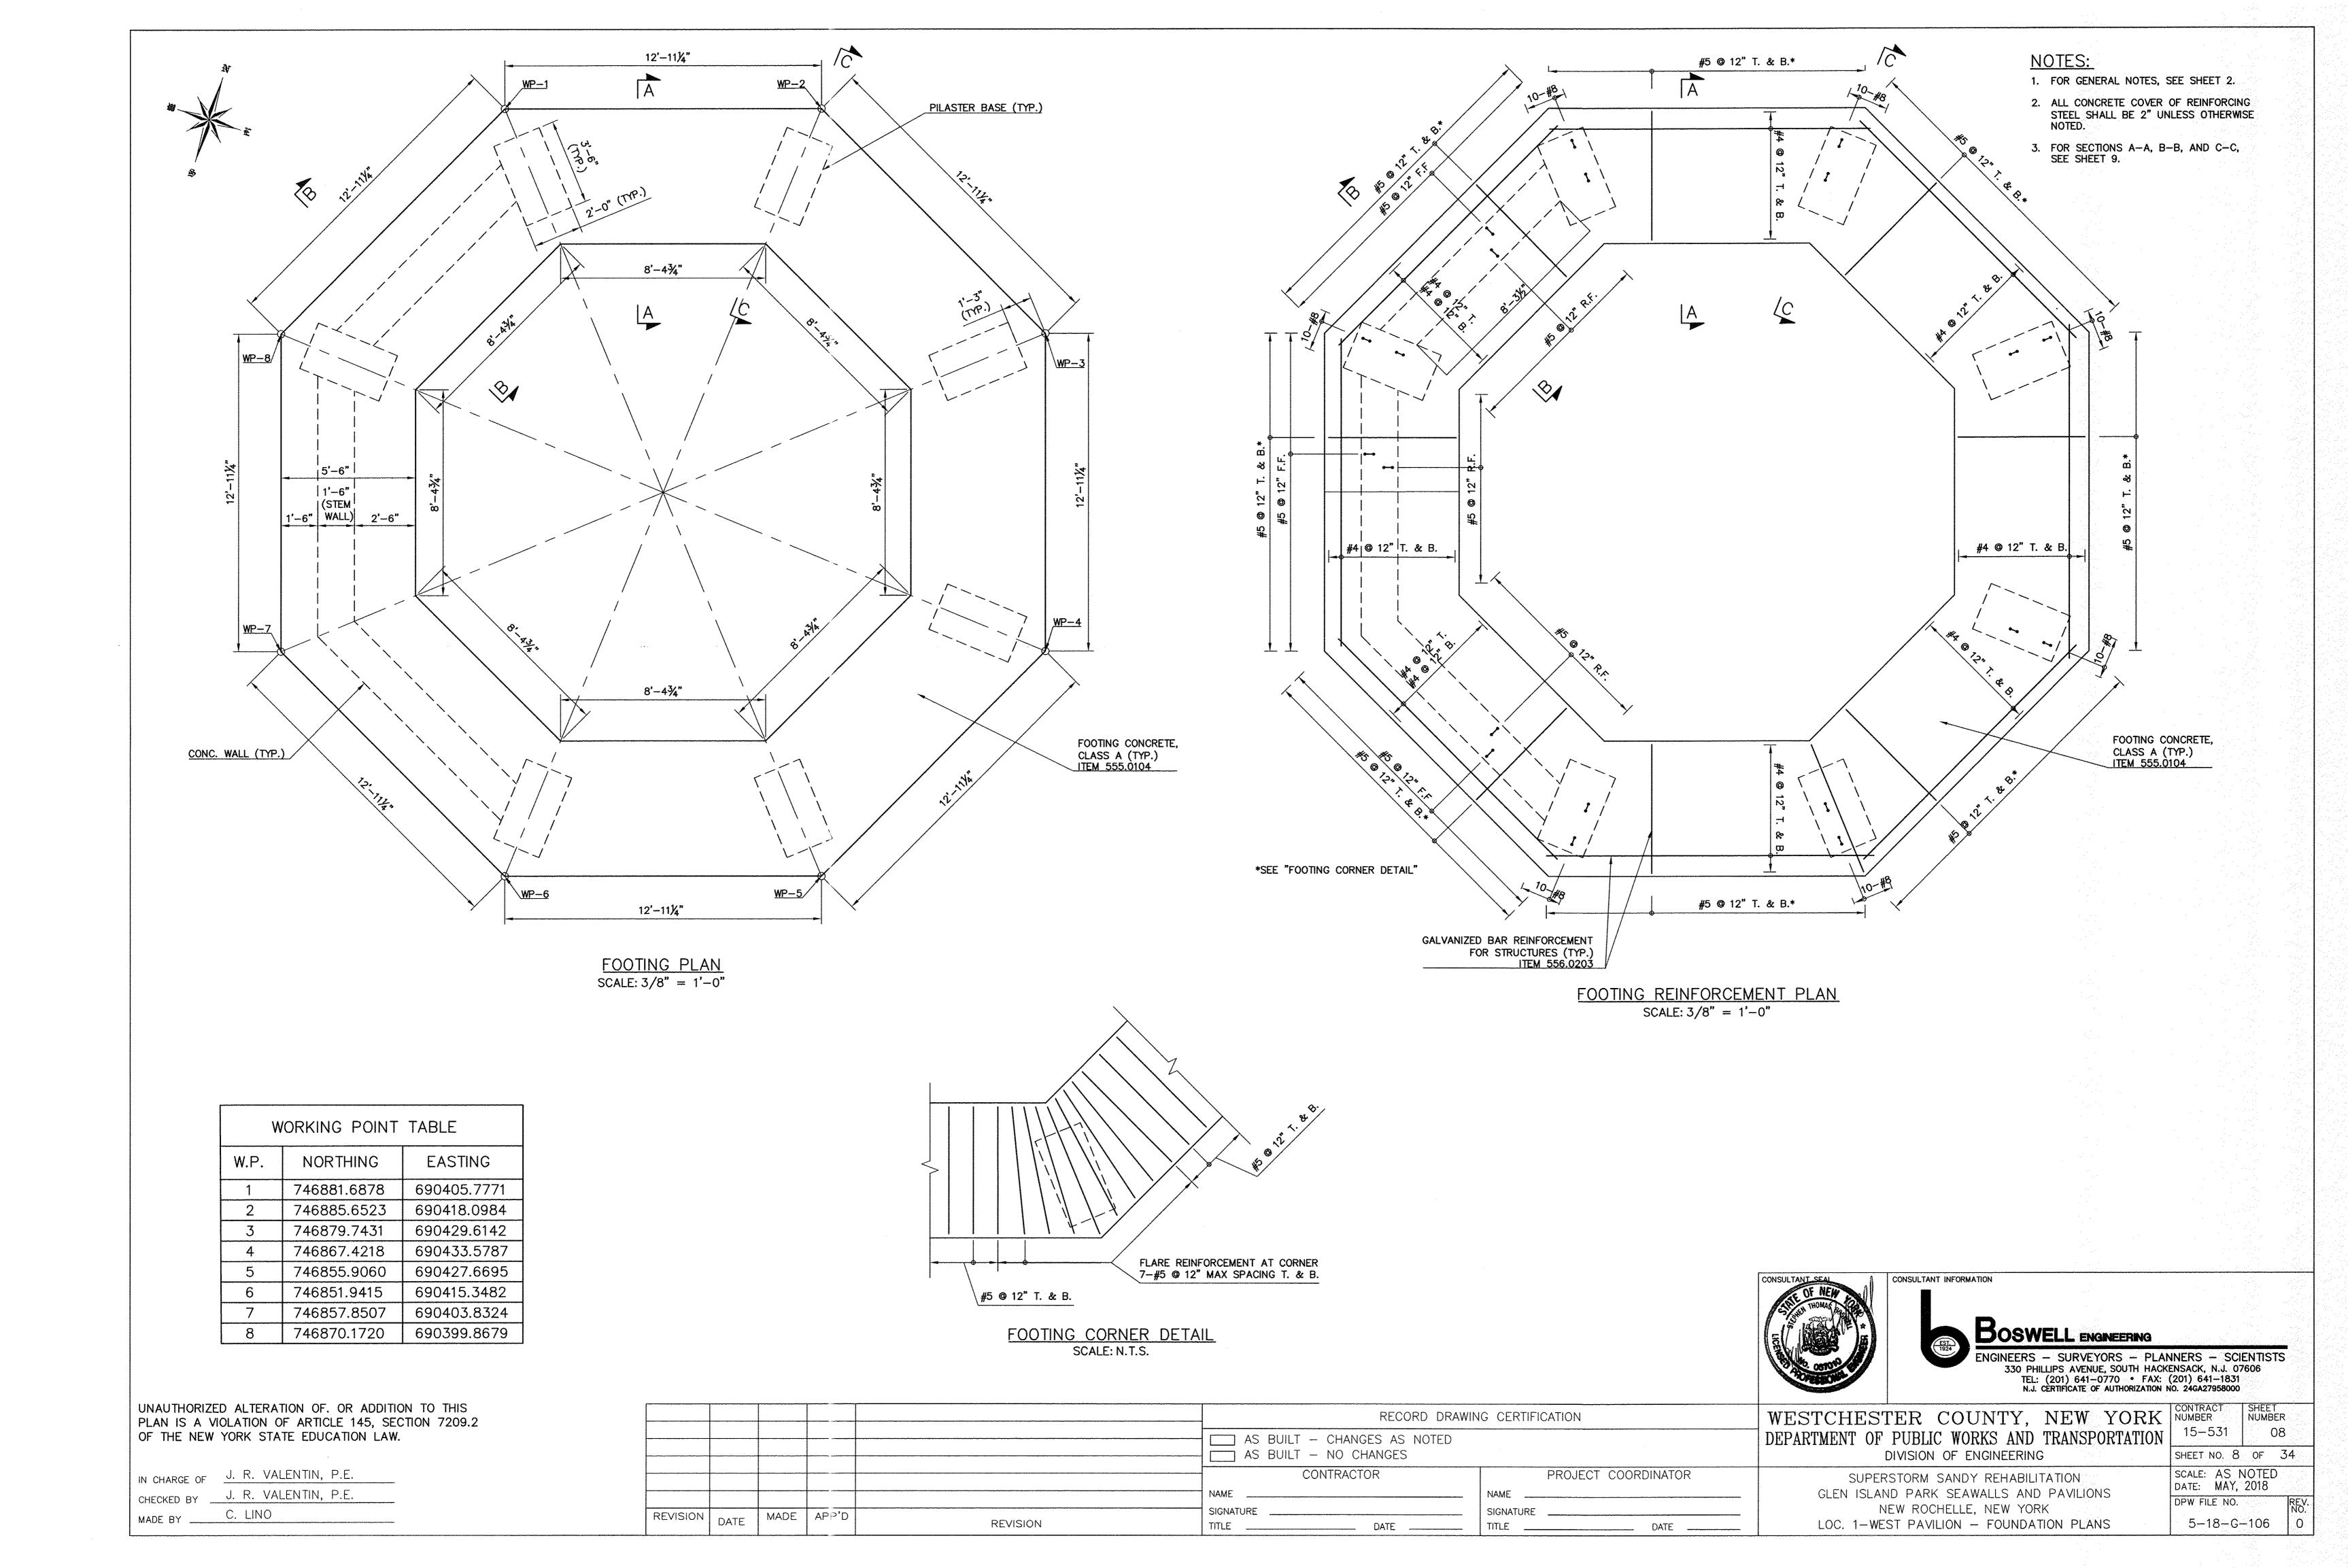


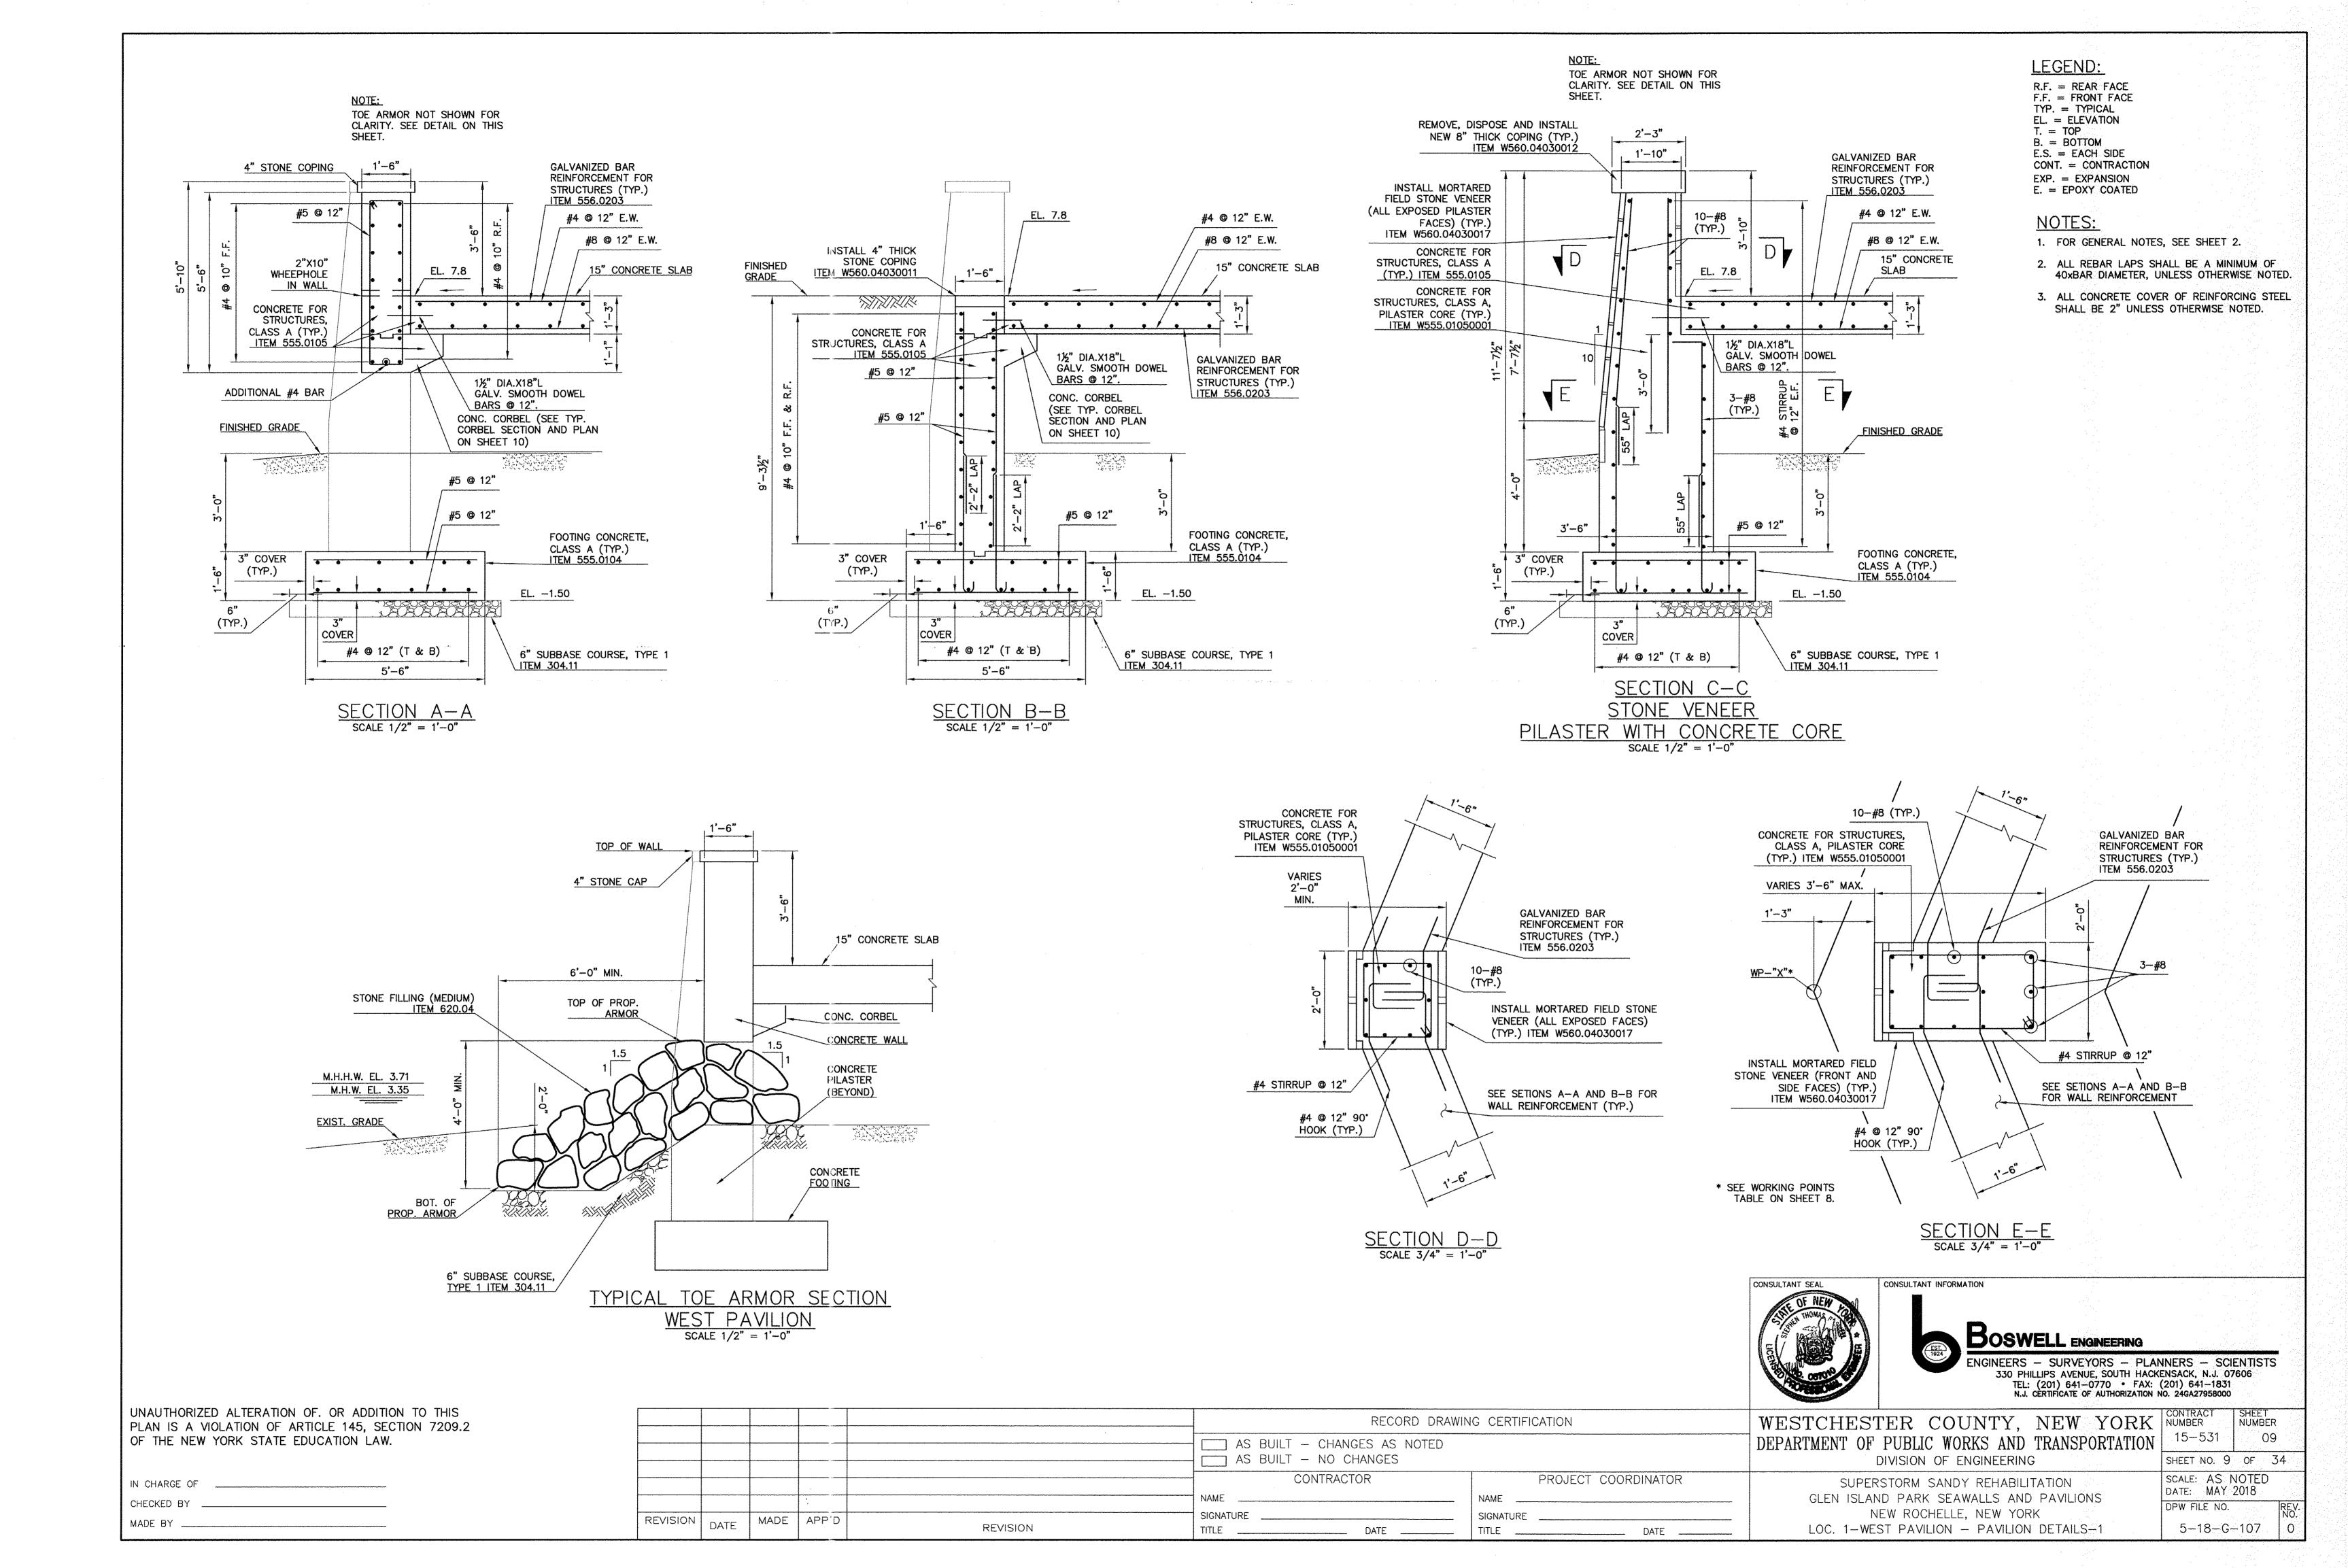

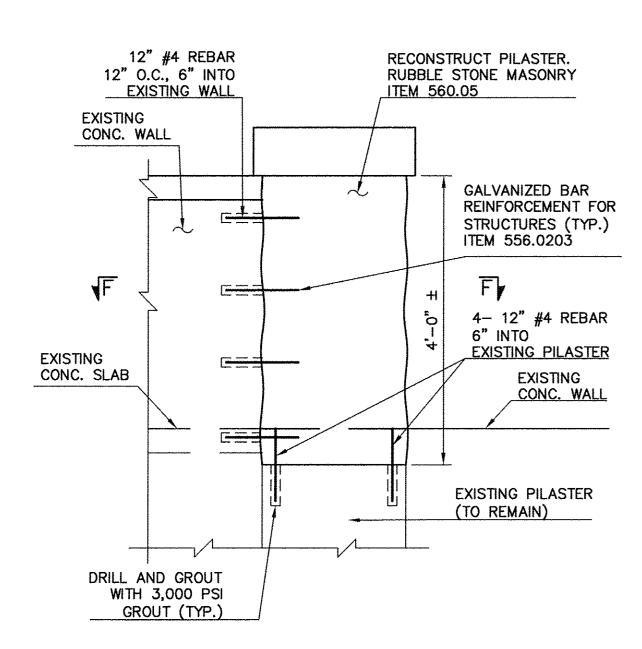


PILASTER RECONSTRUCTION DETAIL EAST PAVILION SCALE 3/4" = 1'-0"

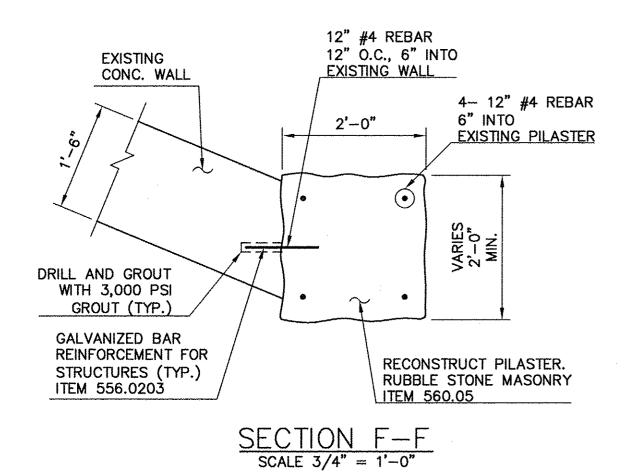


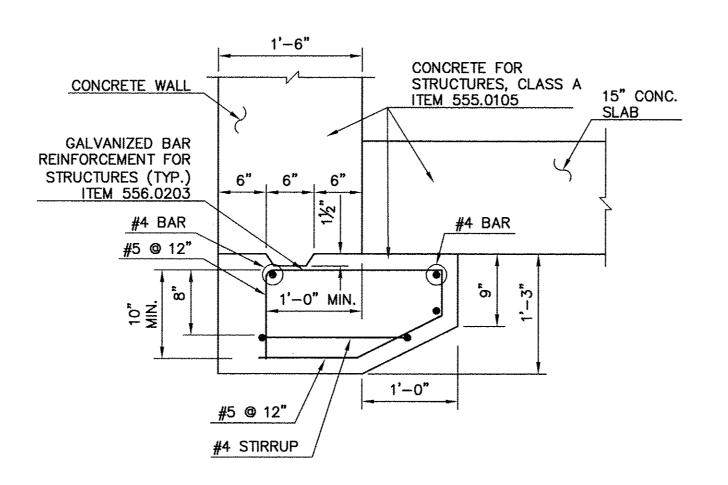


TYPICAL CORBEL SECTION WEST PAVILION SCALE 1"=1'-0"

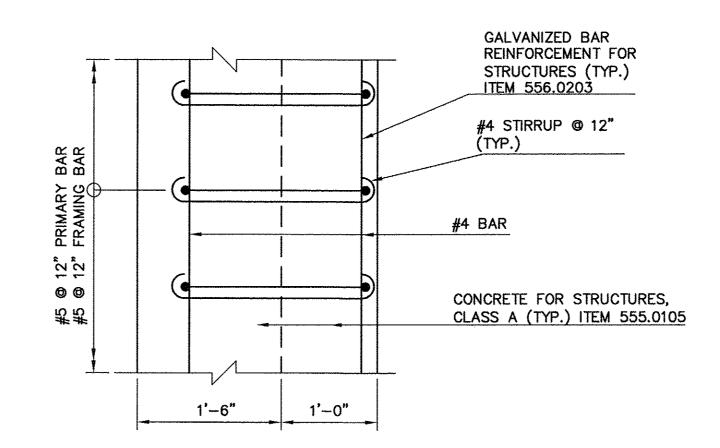


TYPICAL CORBEL REINFORCEMENT PLAN SCALE 1/2" = 1'-0"

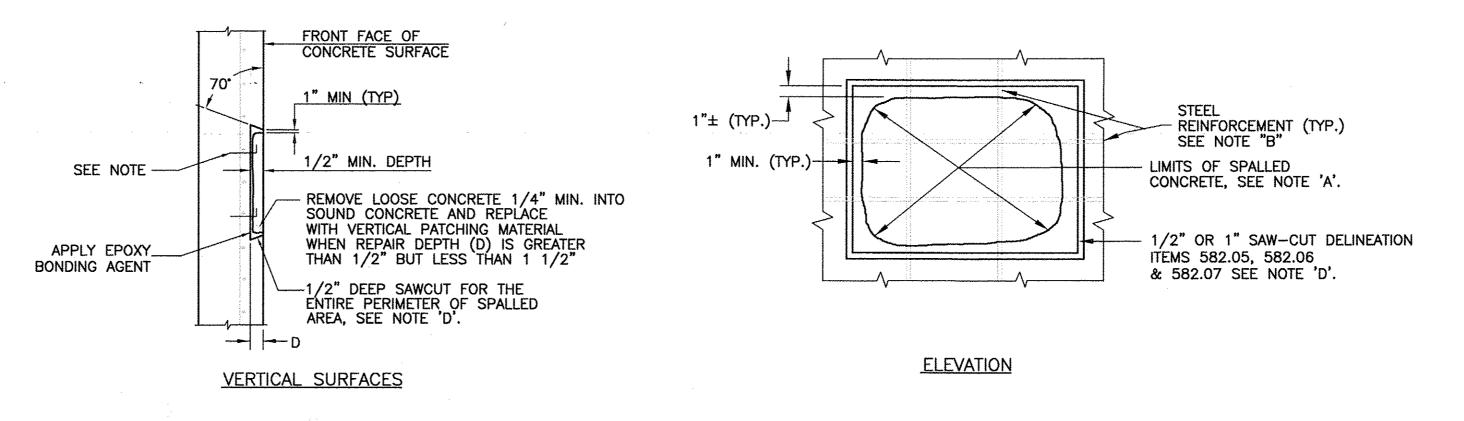

SHALLOW CONCRETE SPALL REPAIR - ITEM 582.07

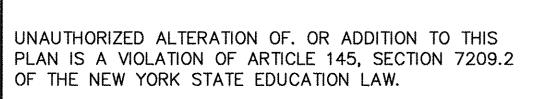

IN CHARGE OF	J.	R.	VALENTIN,	P.E.
CHECKED BY	J.	R.	VALENTIN,	P.E.
MADE BY	C.	LIN	10	

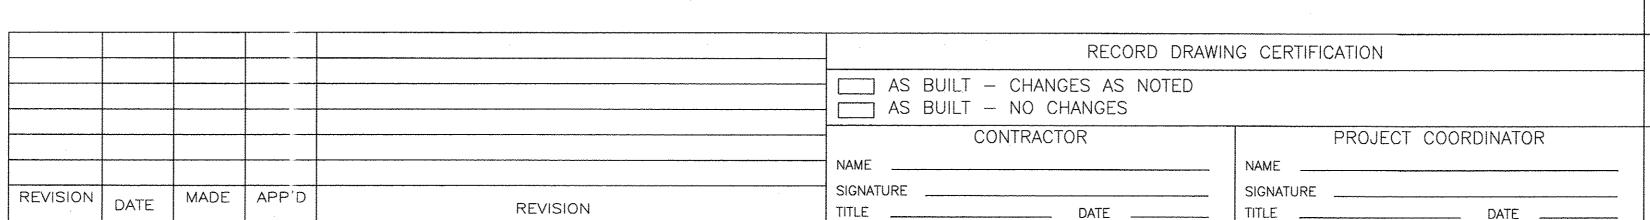

LEGEND:

R.F. = REAR FACE F.F. = FRONT FACE TYP. = TYPICAL EL. = ELEVATION T. = TOP B. = BOTTOM E.S. = EACH SIDE CONT. = CONTRACTION EXP. = EXPANSION


E. = EPOXY COATED

NOTES:

1. FOR GENERAL NOTES, SEE SHEET 2.

2. ALL REBAR LAPS SHALL BE A MINIMUM OF 40xBAR DIAMETER, UNLESS OTHERWISE NOTED.

3. ALL CONCRETE COVER OF REINFORCING STEEL SHALL BE 2" UNLESS OTHERWISE NOTED.

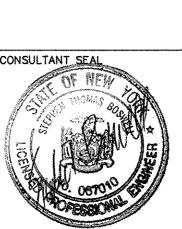

BOSWELL ENGINEERING ENGINEERS - SURVEYORS - PLANNERS - SCIENTISTS 330 PHILLIPS AVENUE, SOUTH HACKENSACK, N.J. 07606 TEL: (201) 641-0770 • FAX: (201) 641-1831 N.J. CERTIFICATE OF AUTHORIZATION NO. 24GA27958000

WESTCHESTER COUNTY, NEW YORK CONTRACT NUMBER DEPARTMENT OF PUBLIC WORKS AND TRANSPORTATION


LOC. 1- PAVILION DETAILS


CONSULTANT INFORMATION


15-531 DIVISION OF ENGINEERING SHEET NO. 10 OF 34 SCALE: AS NOTED SUPERSTORM SANDY REHABILITATION GLEN ISLAND PARK SEAWALLS AND PAVILIONS NEW ROCHELLE, NEW YORK


DATE: MAY 2018 DPW FILE NO. 5-18-G-108


SHEET NUMBER

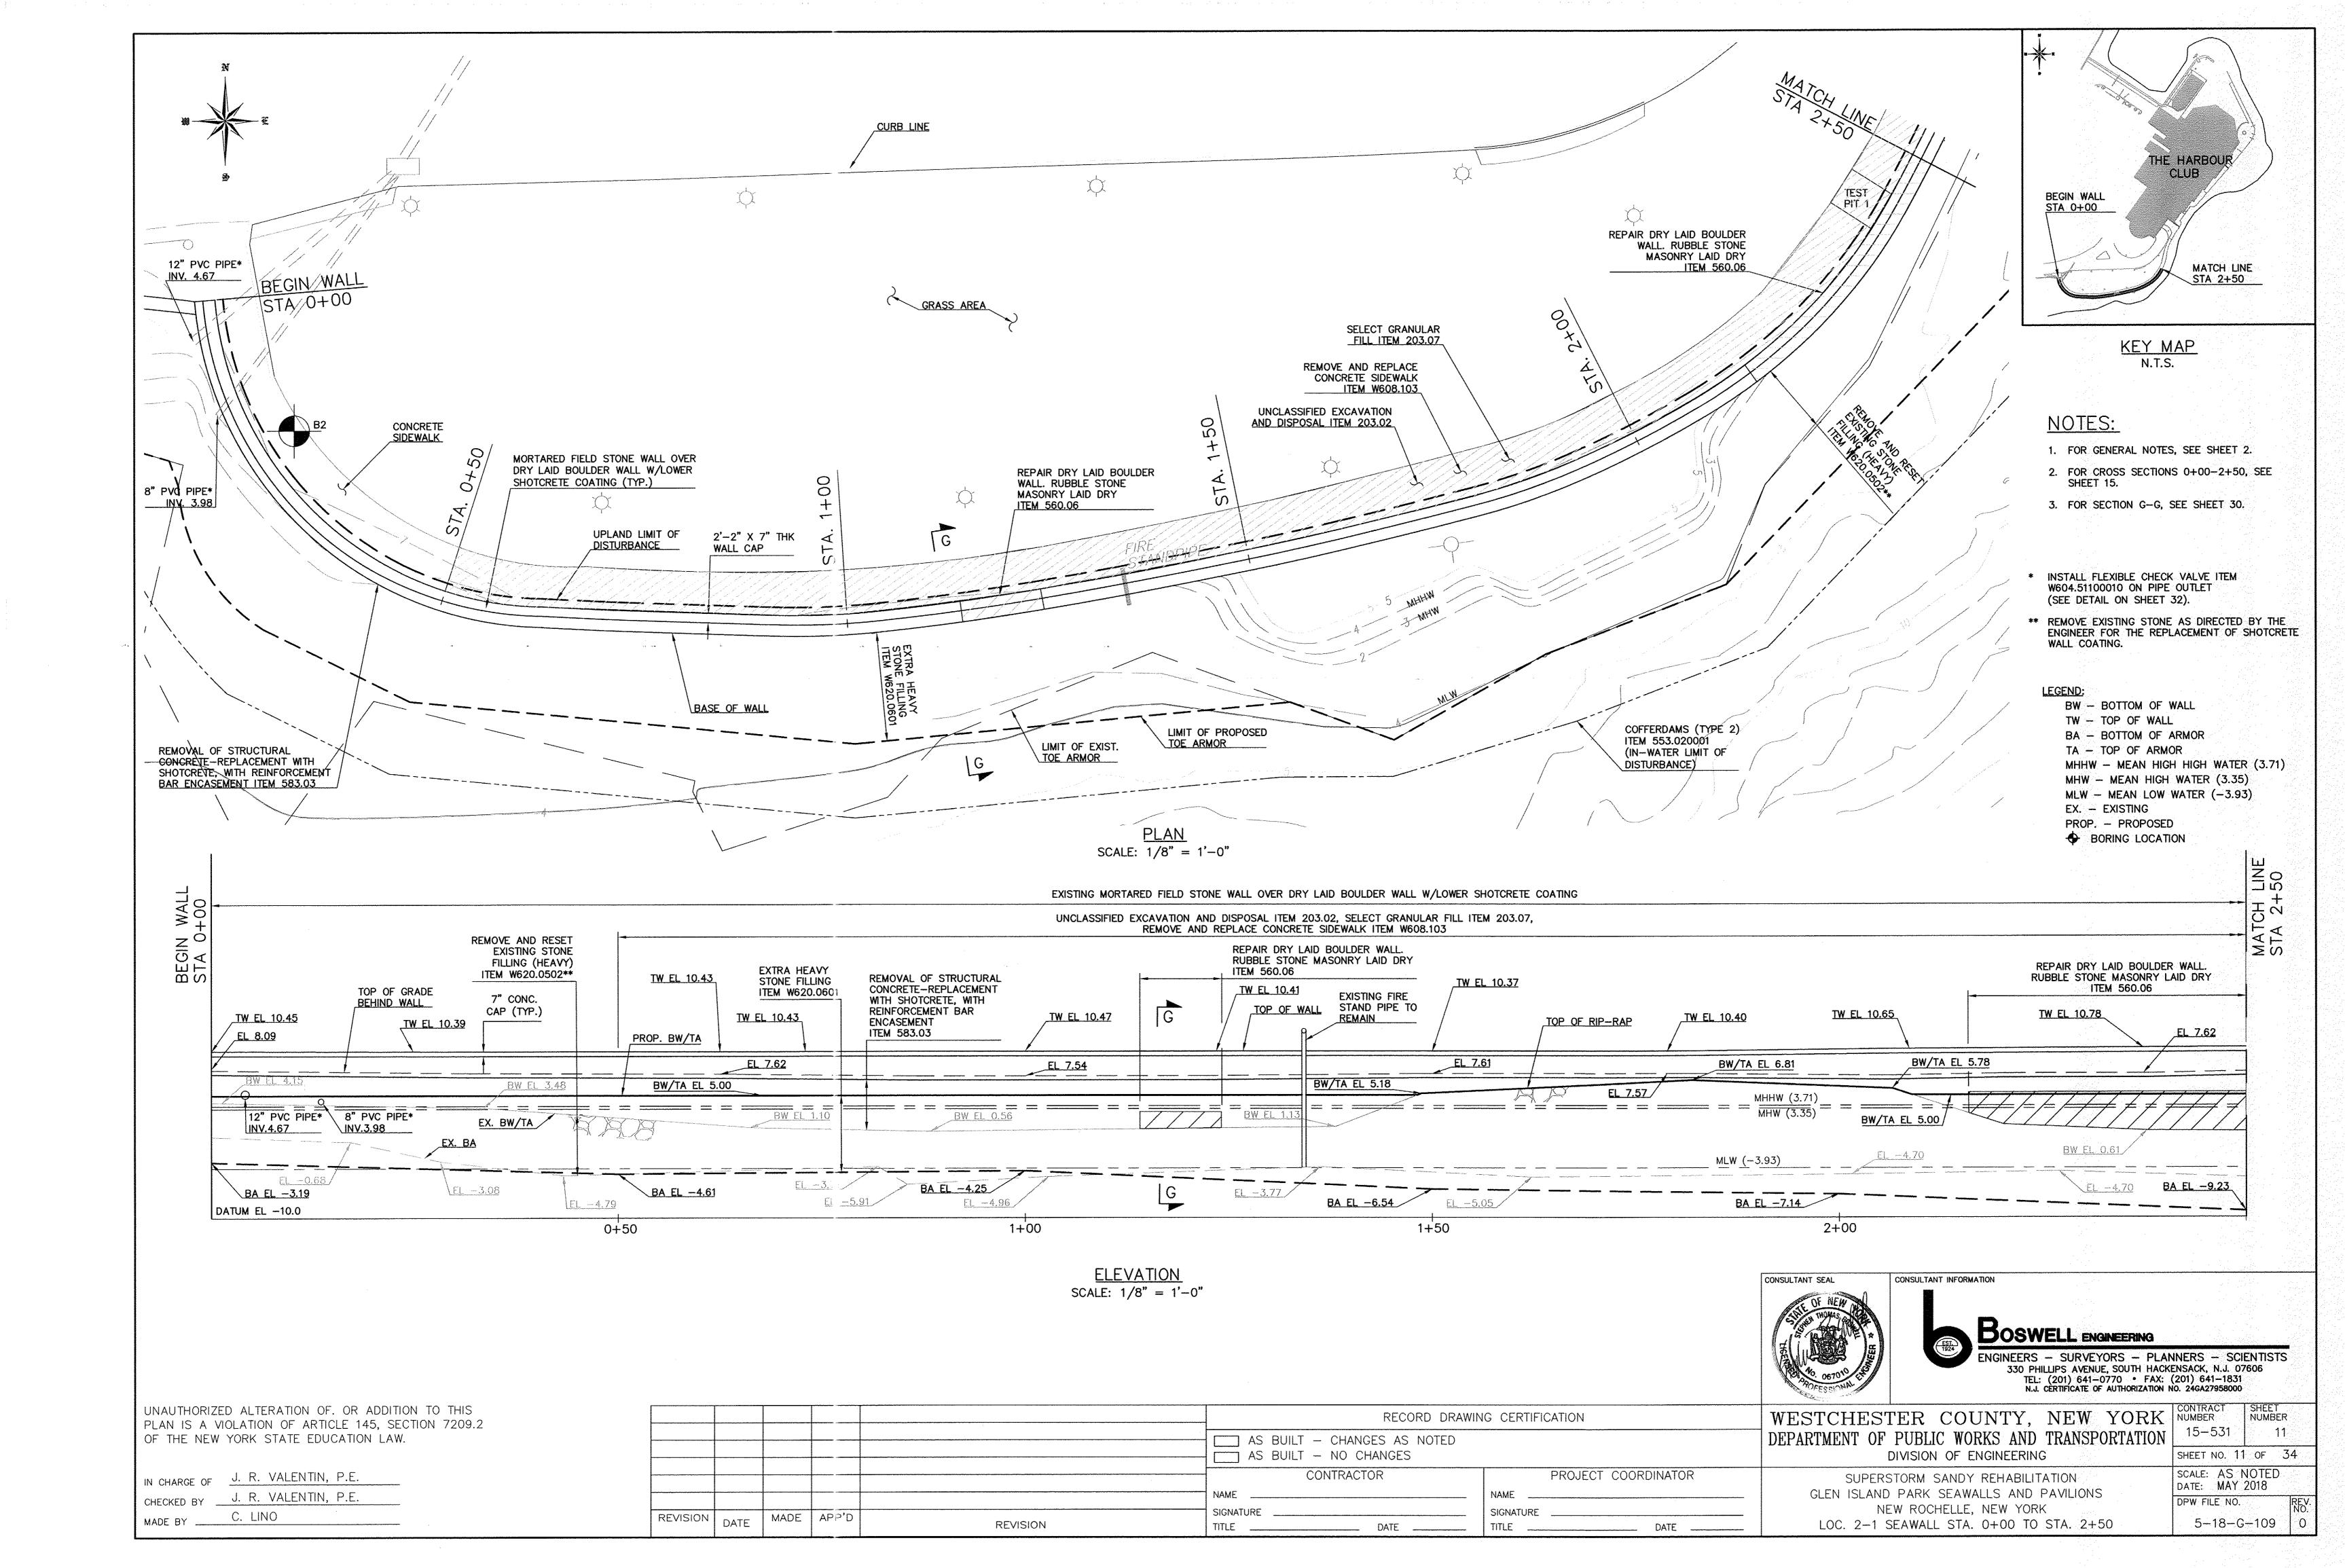


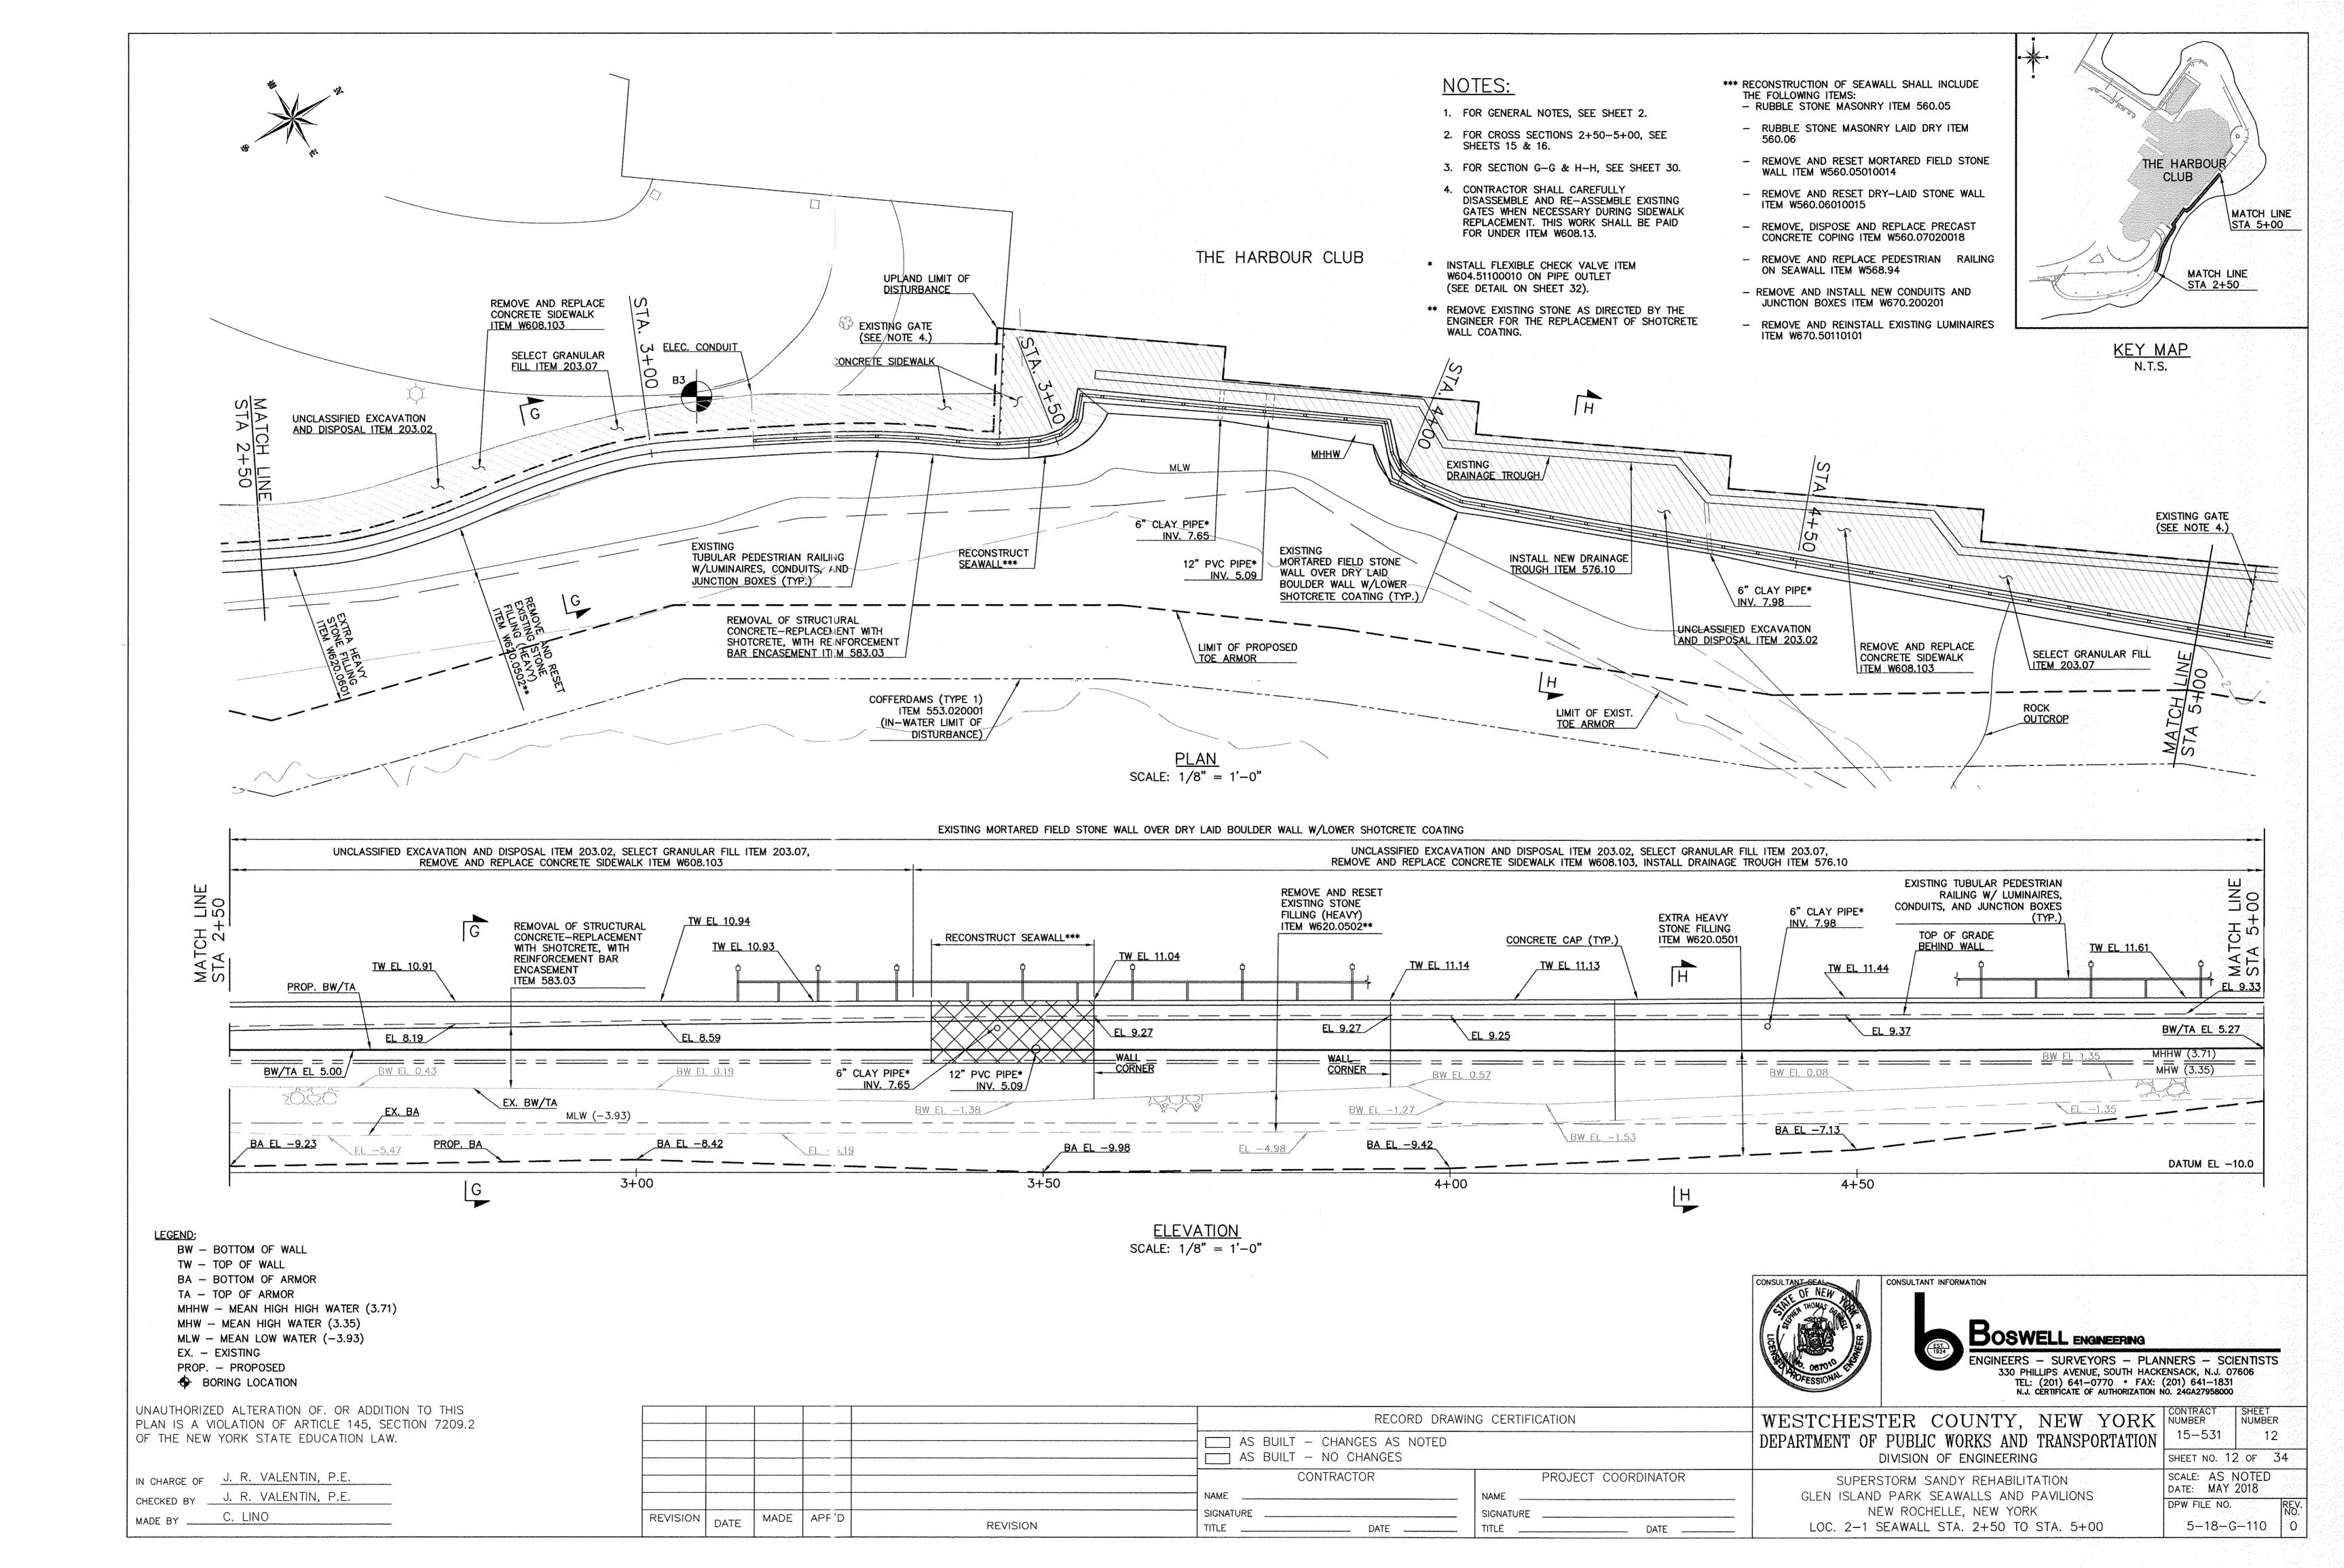


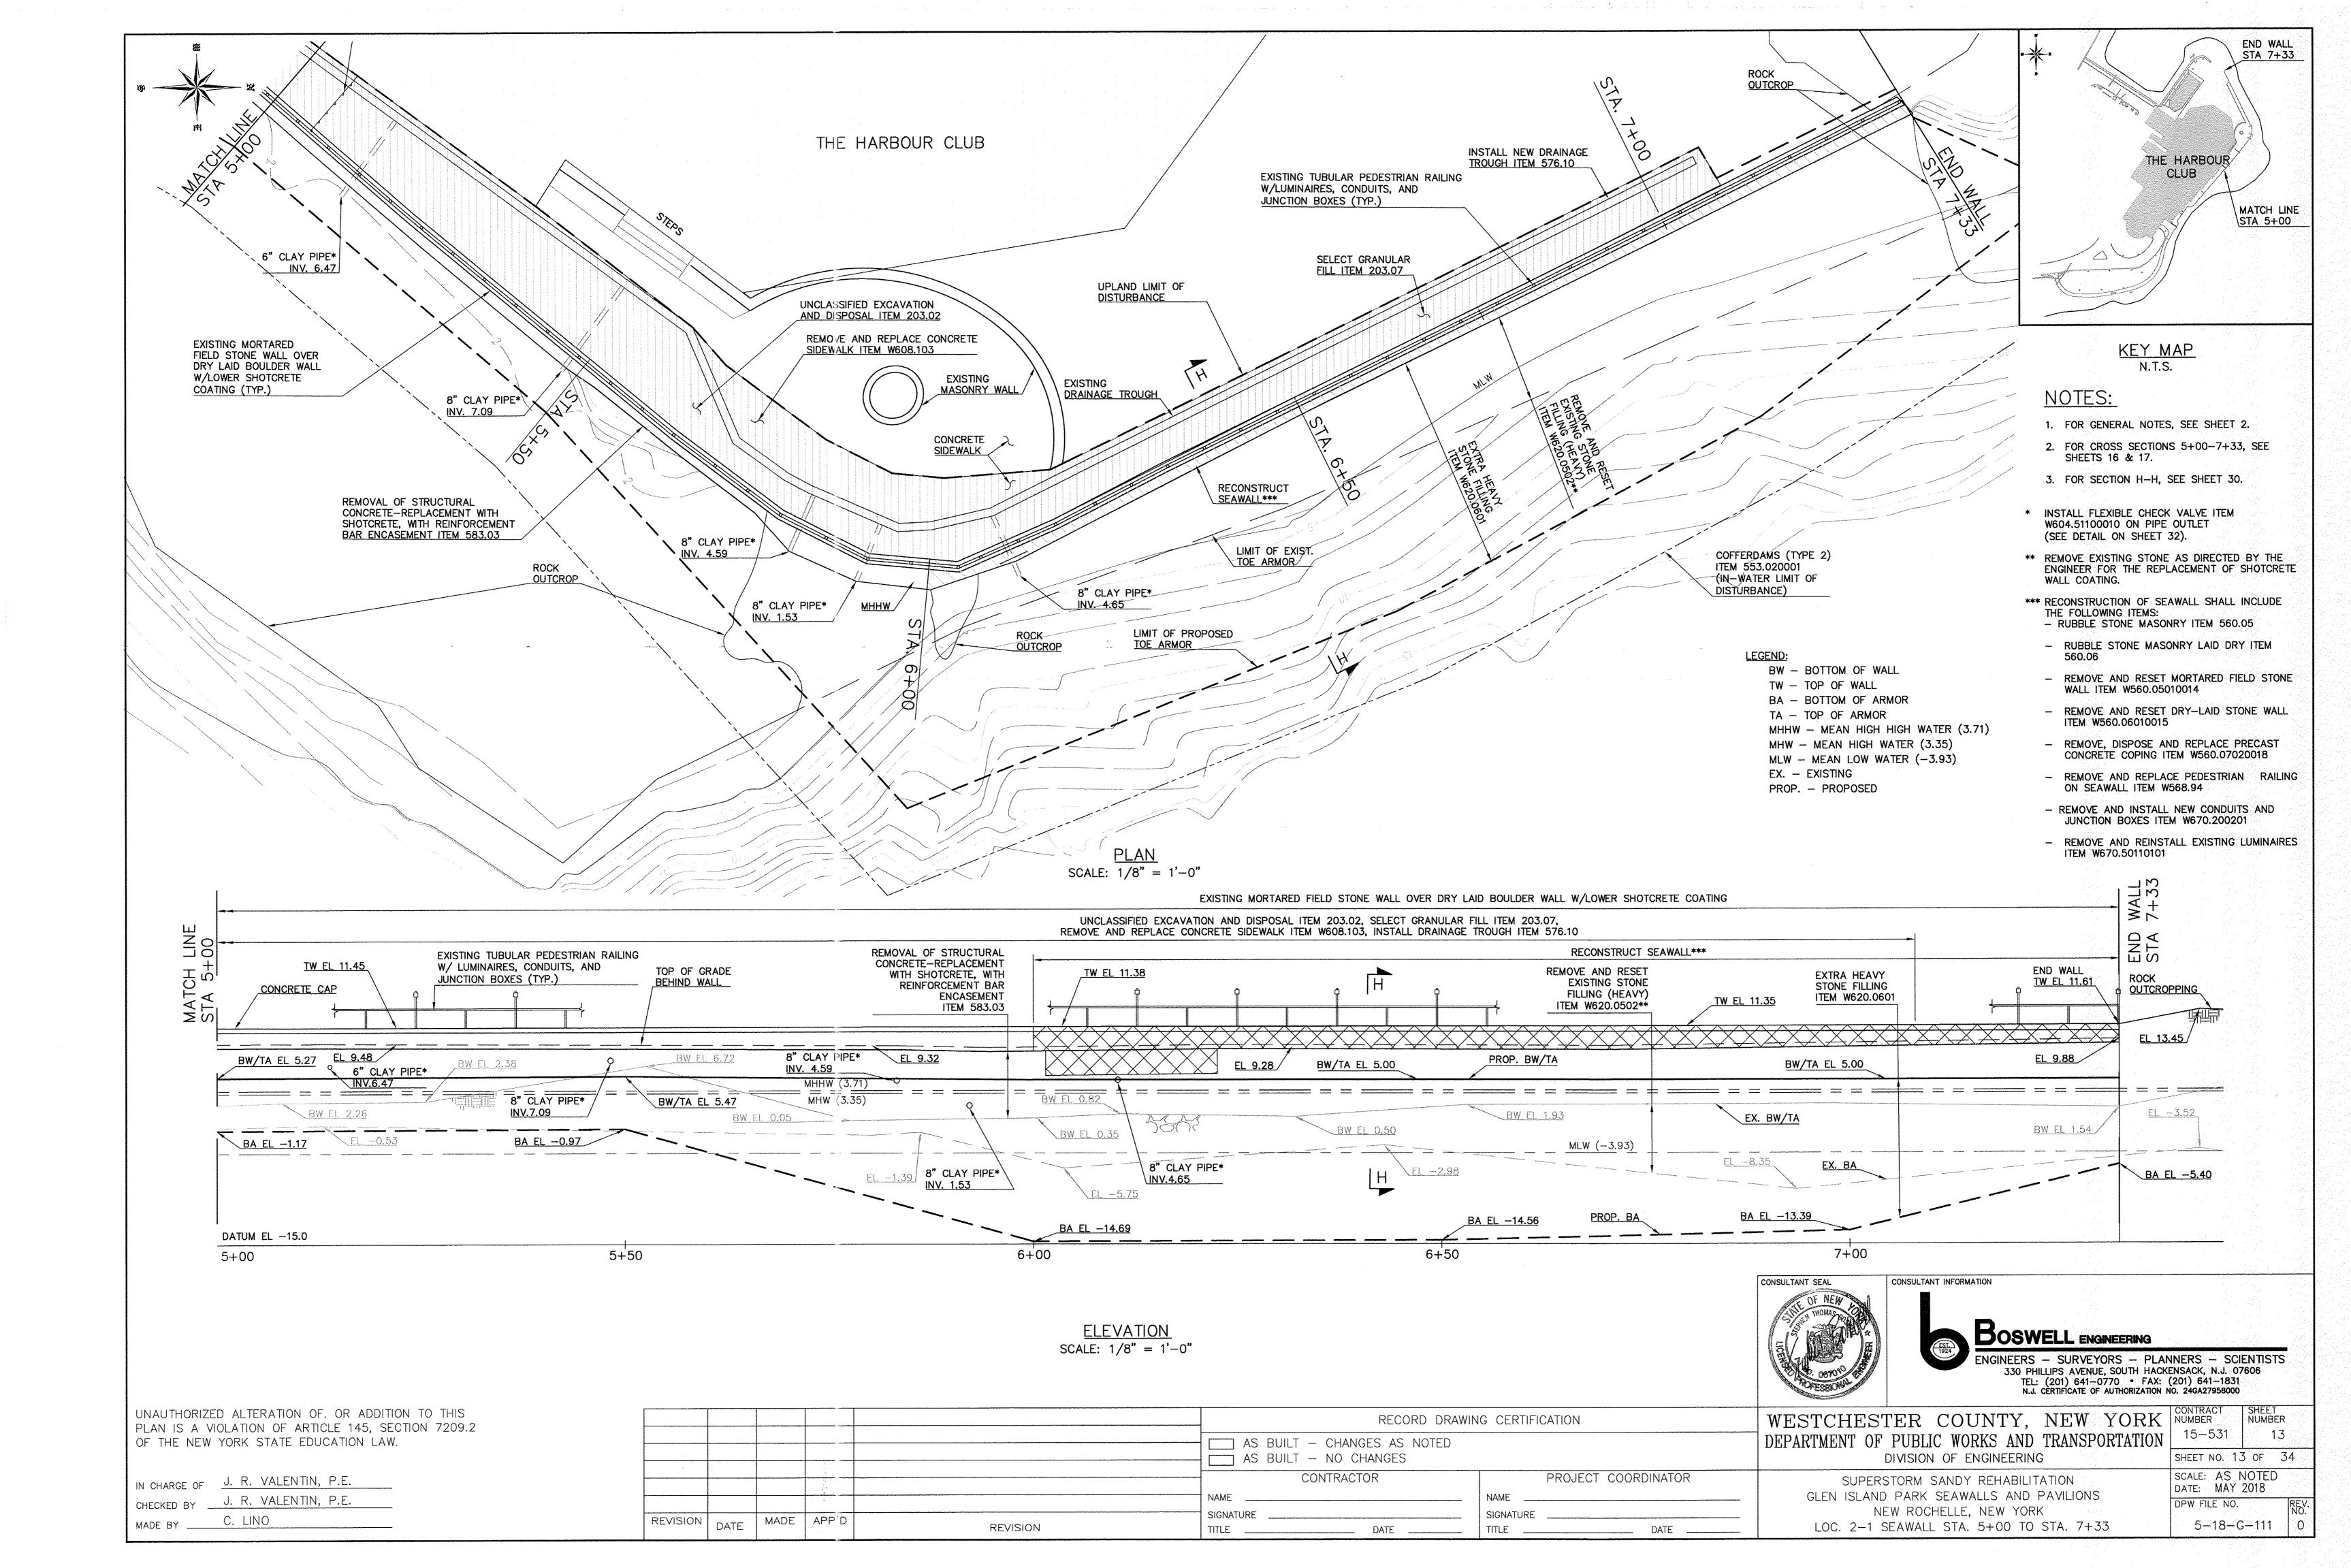


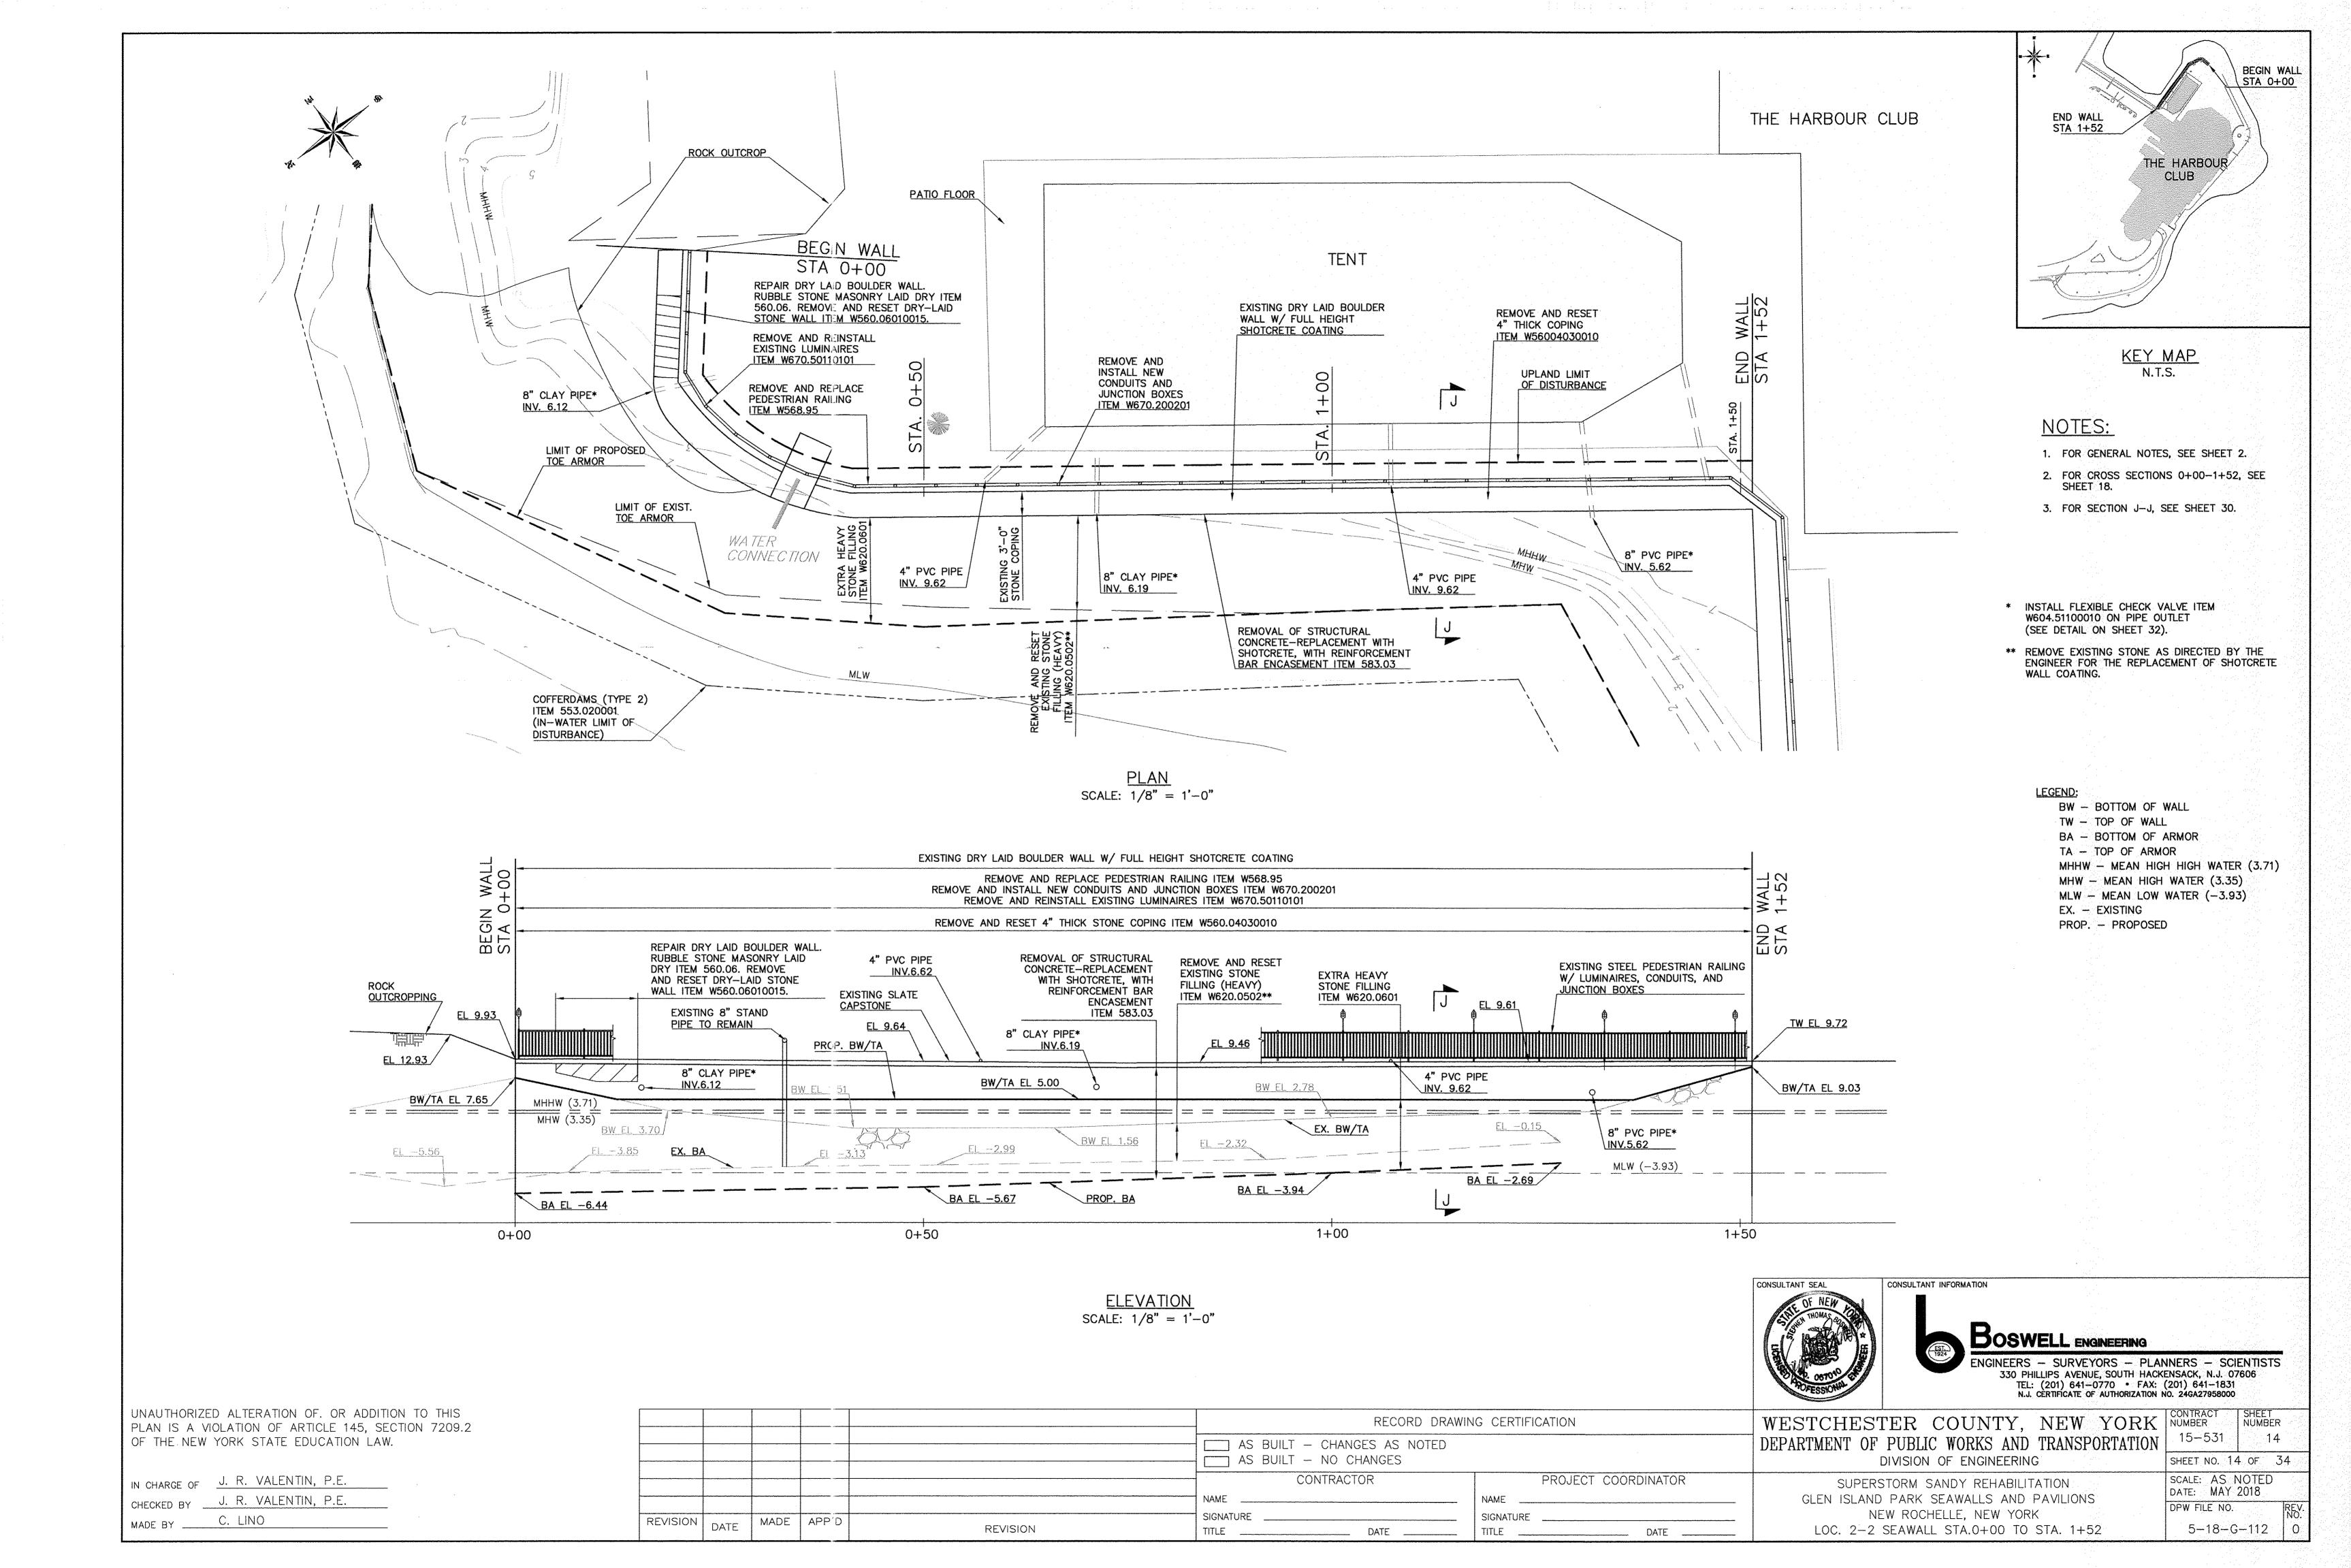


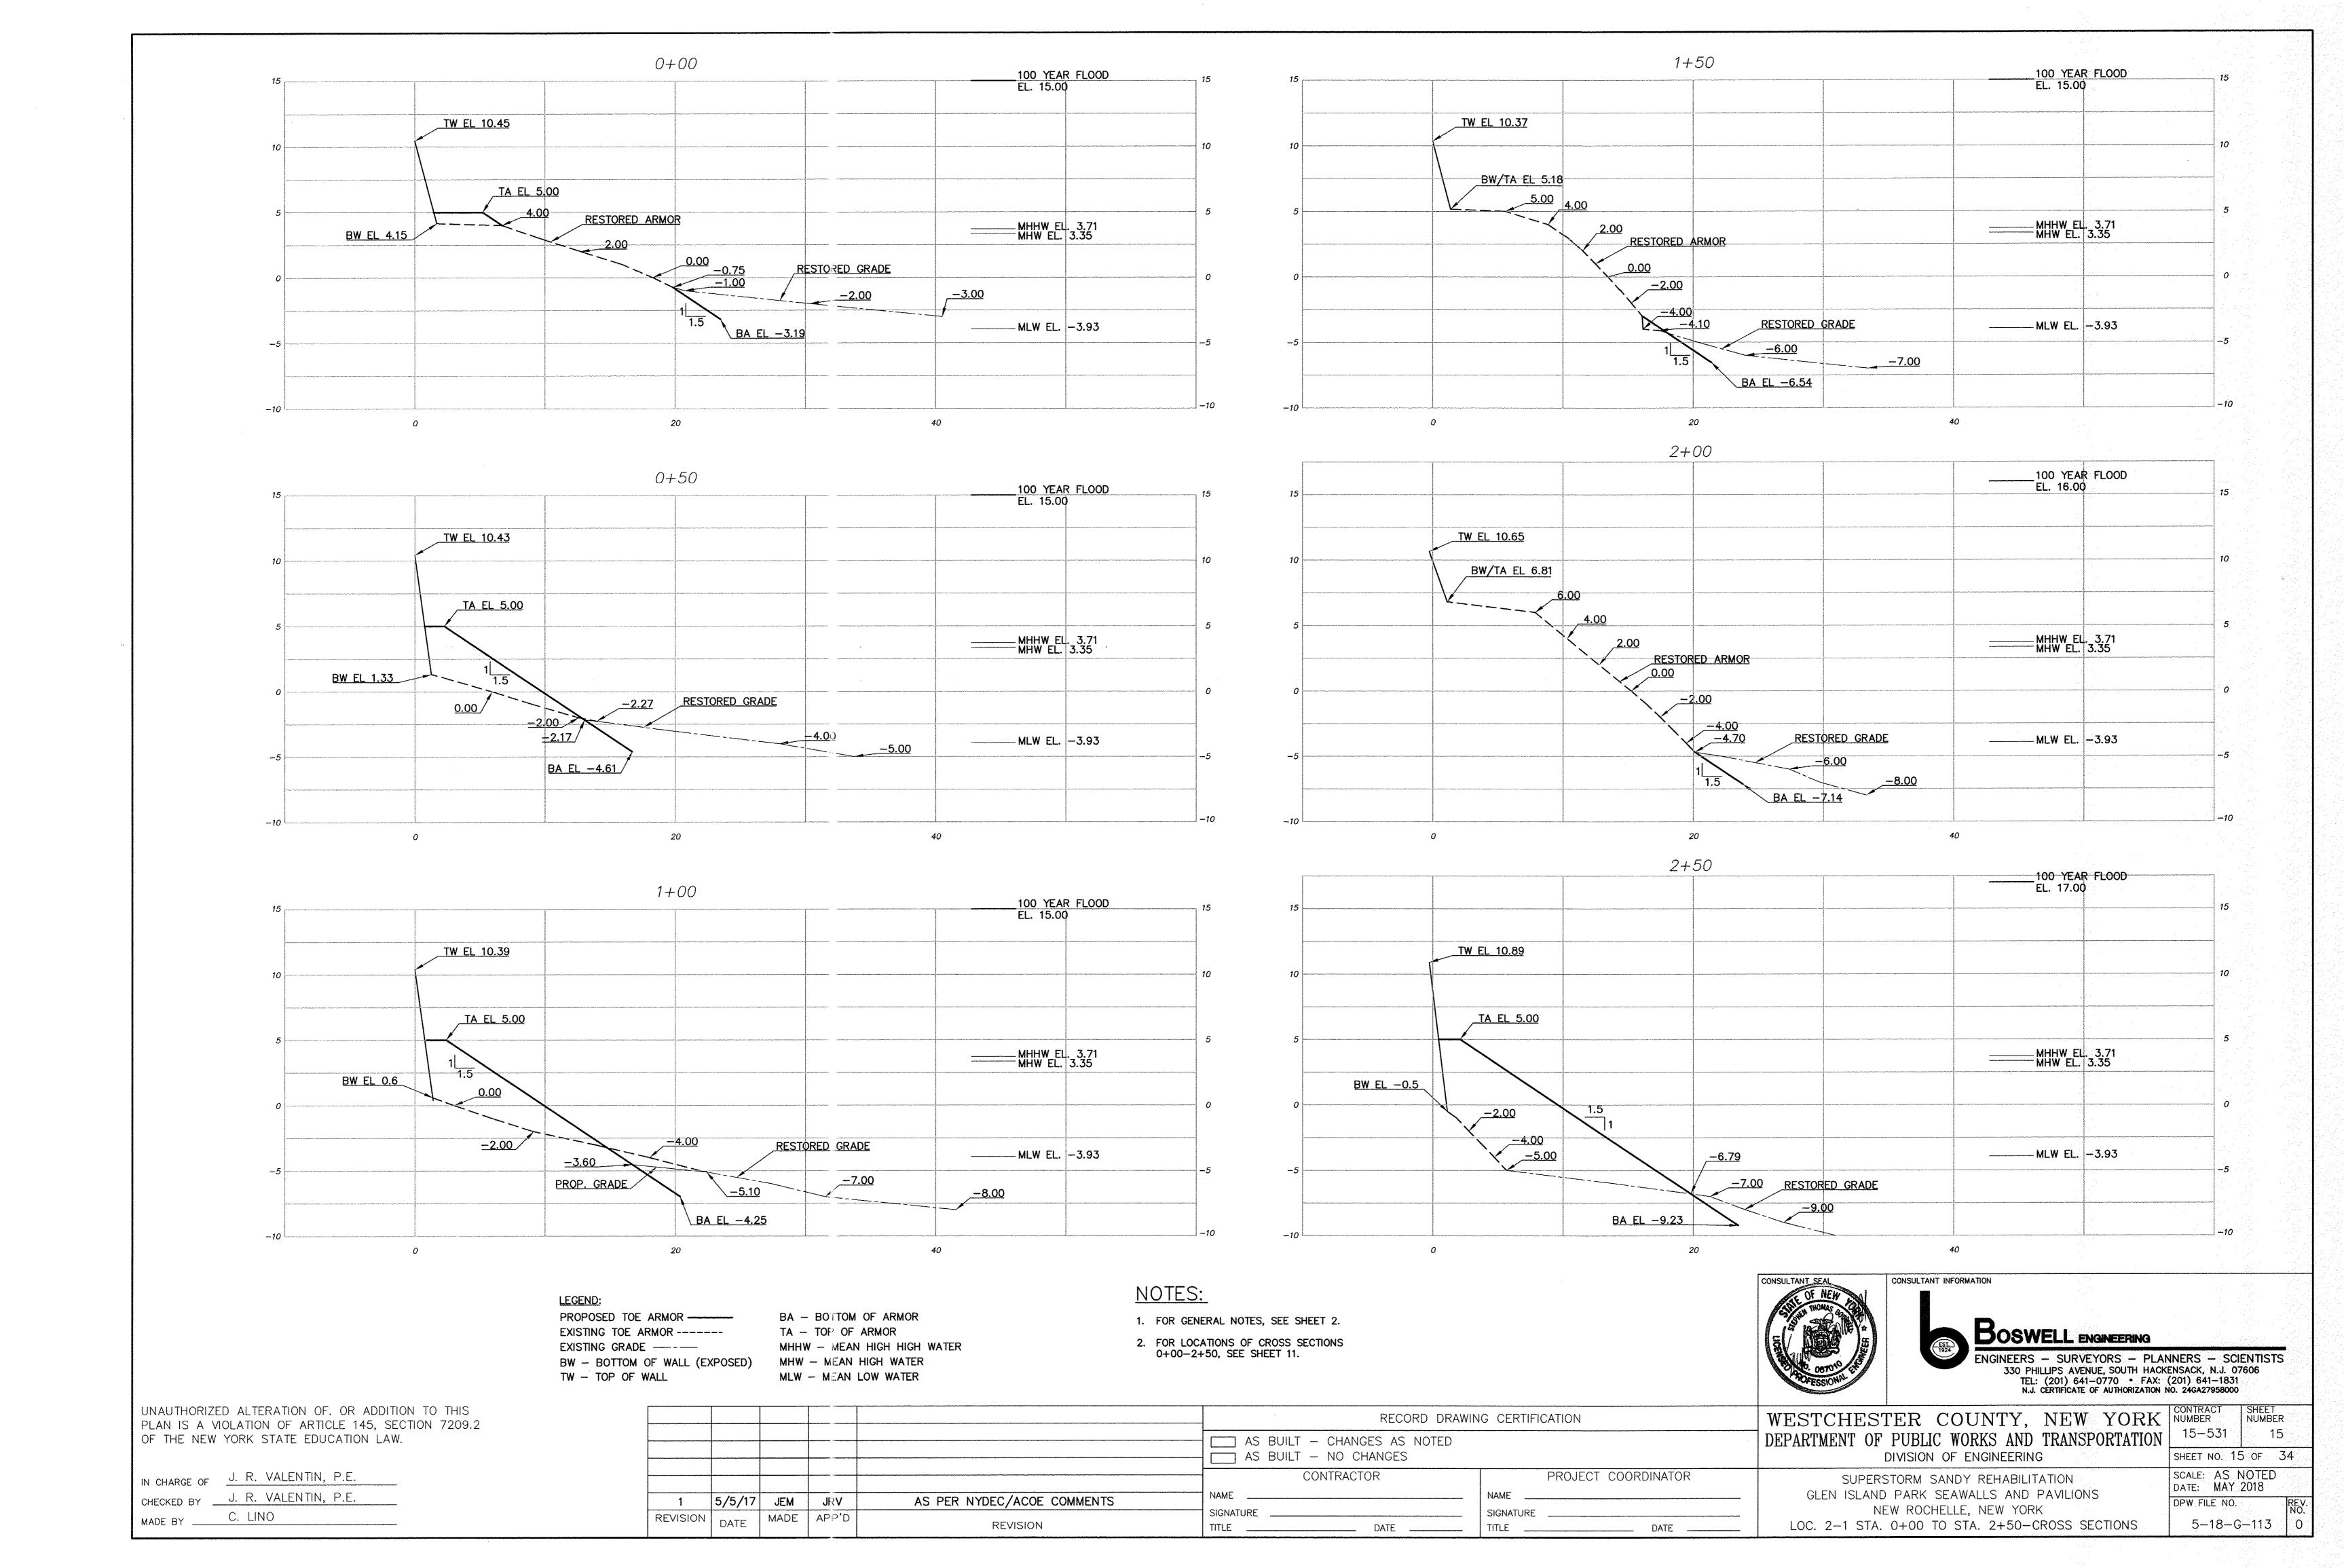


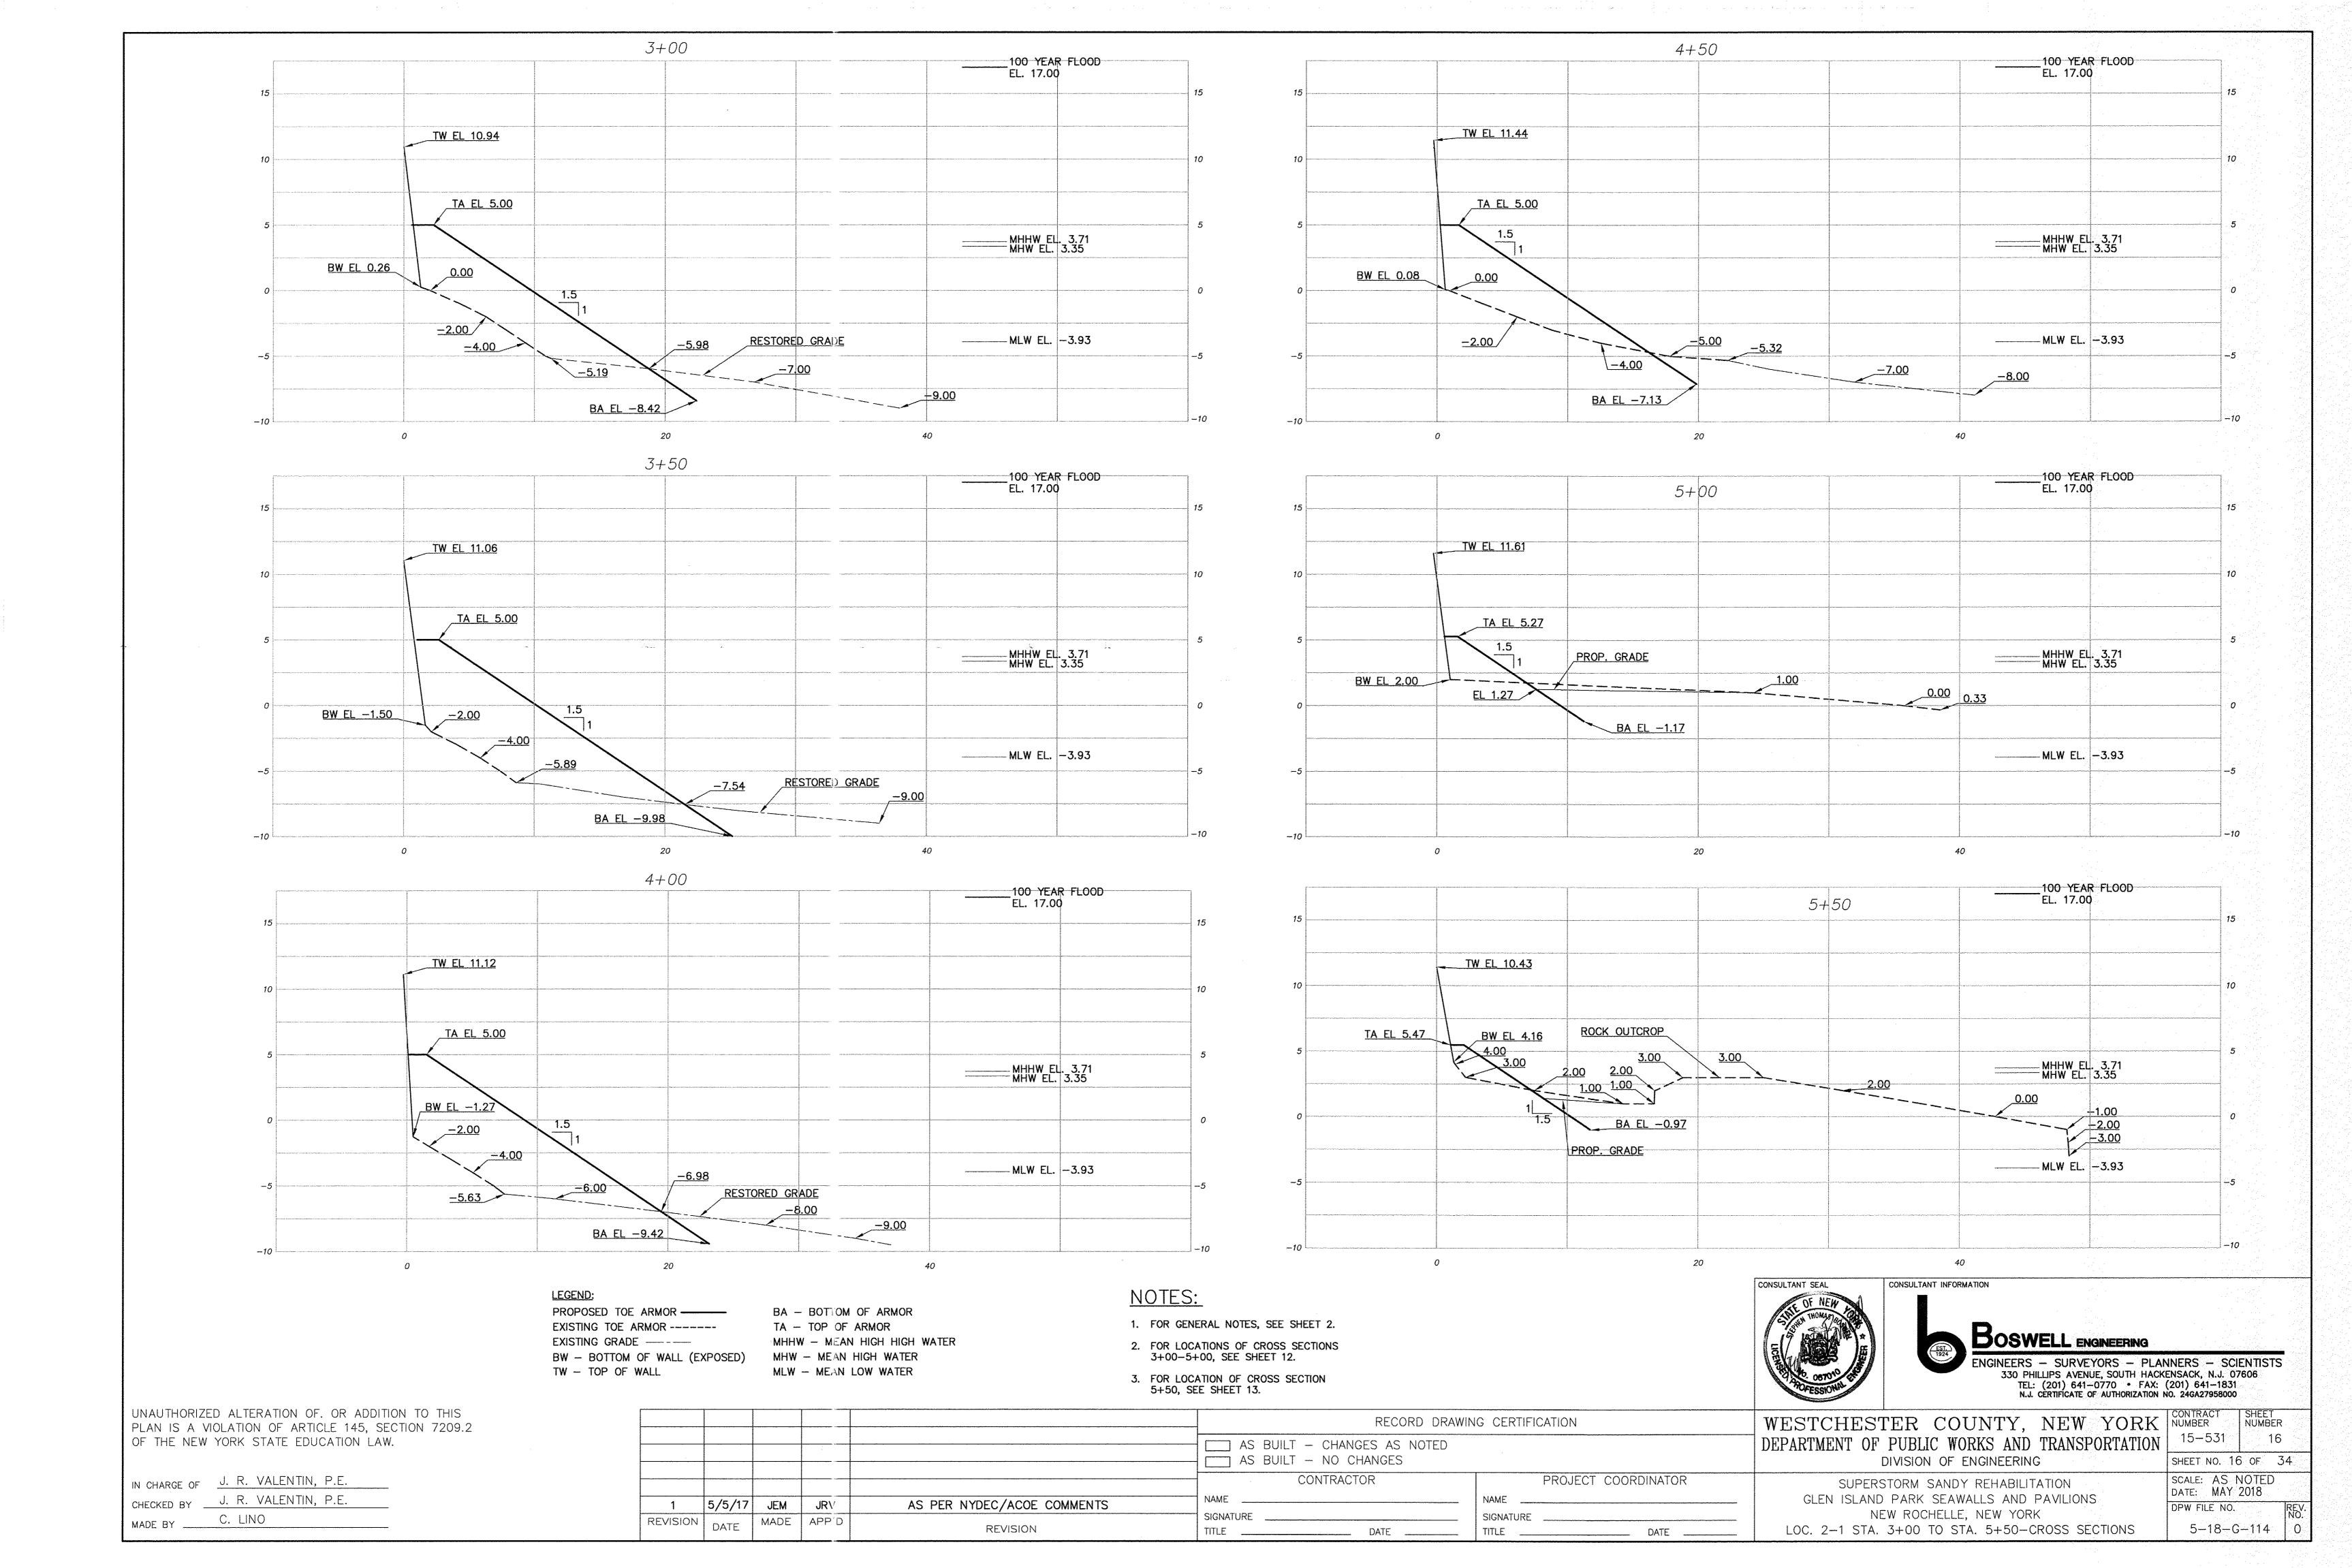


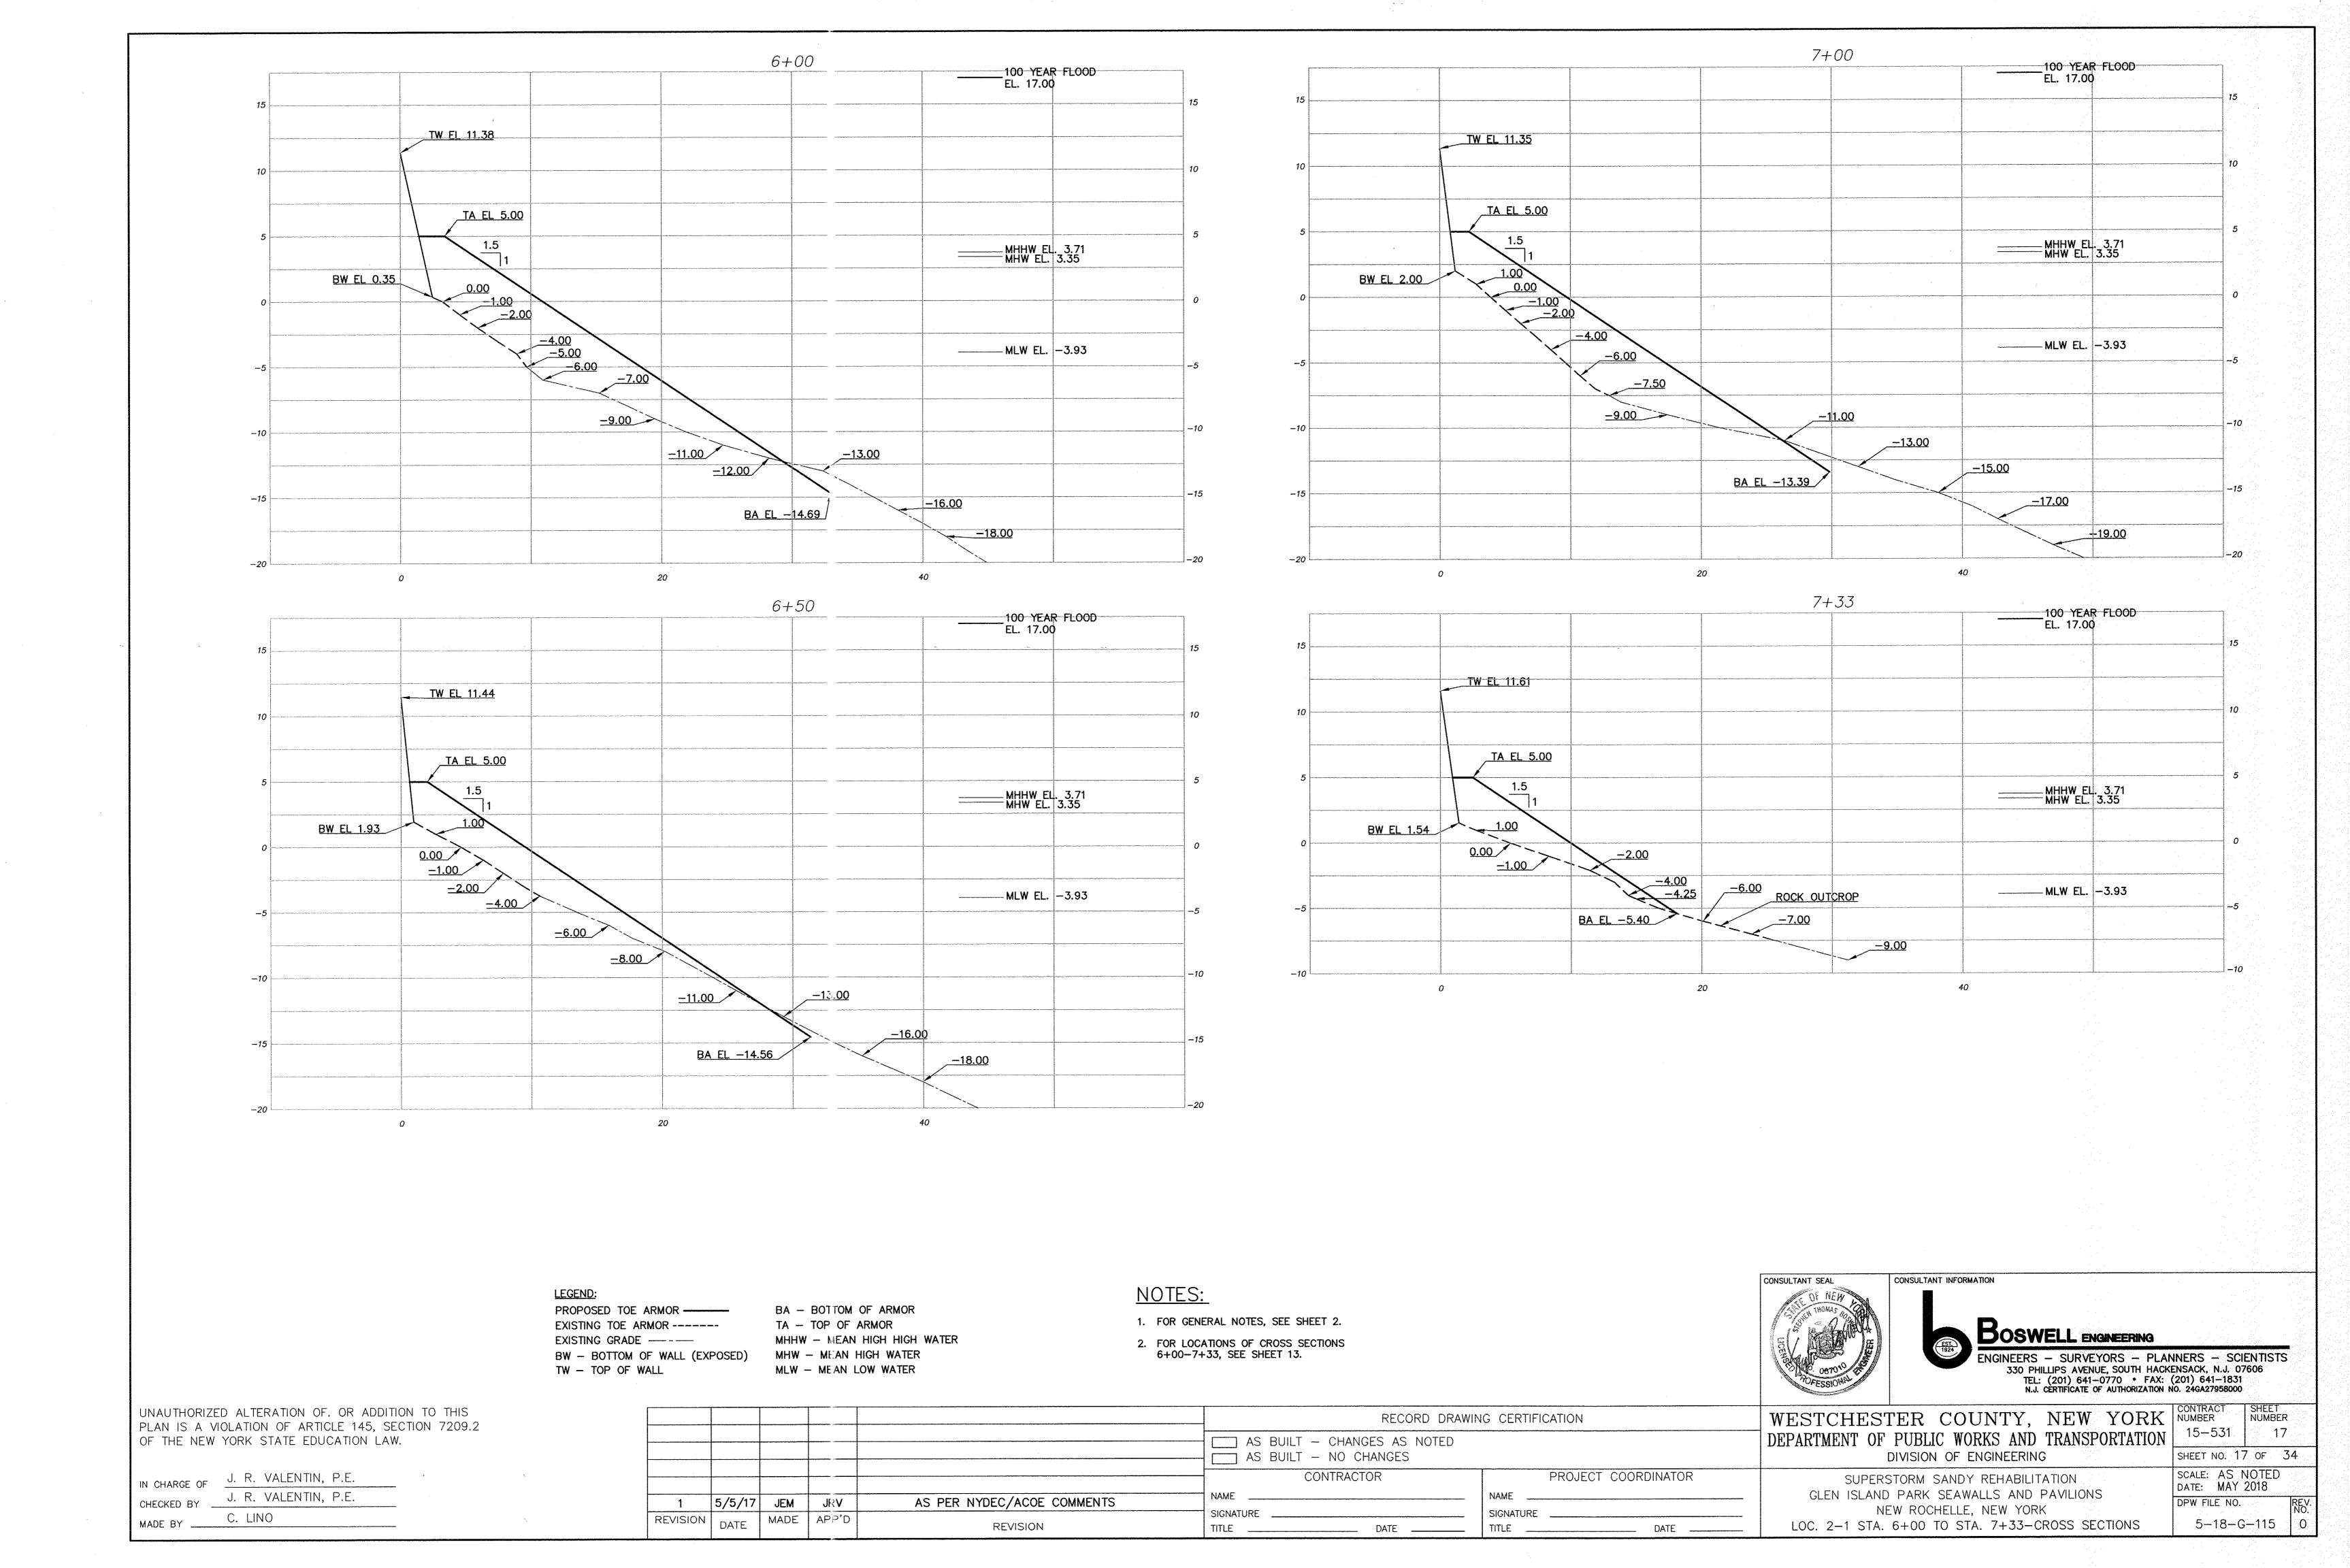


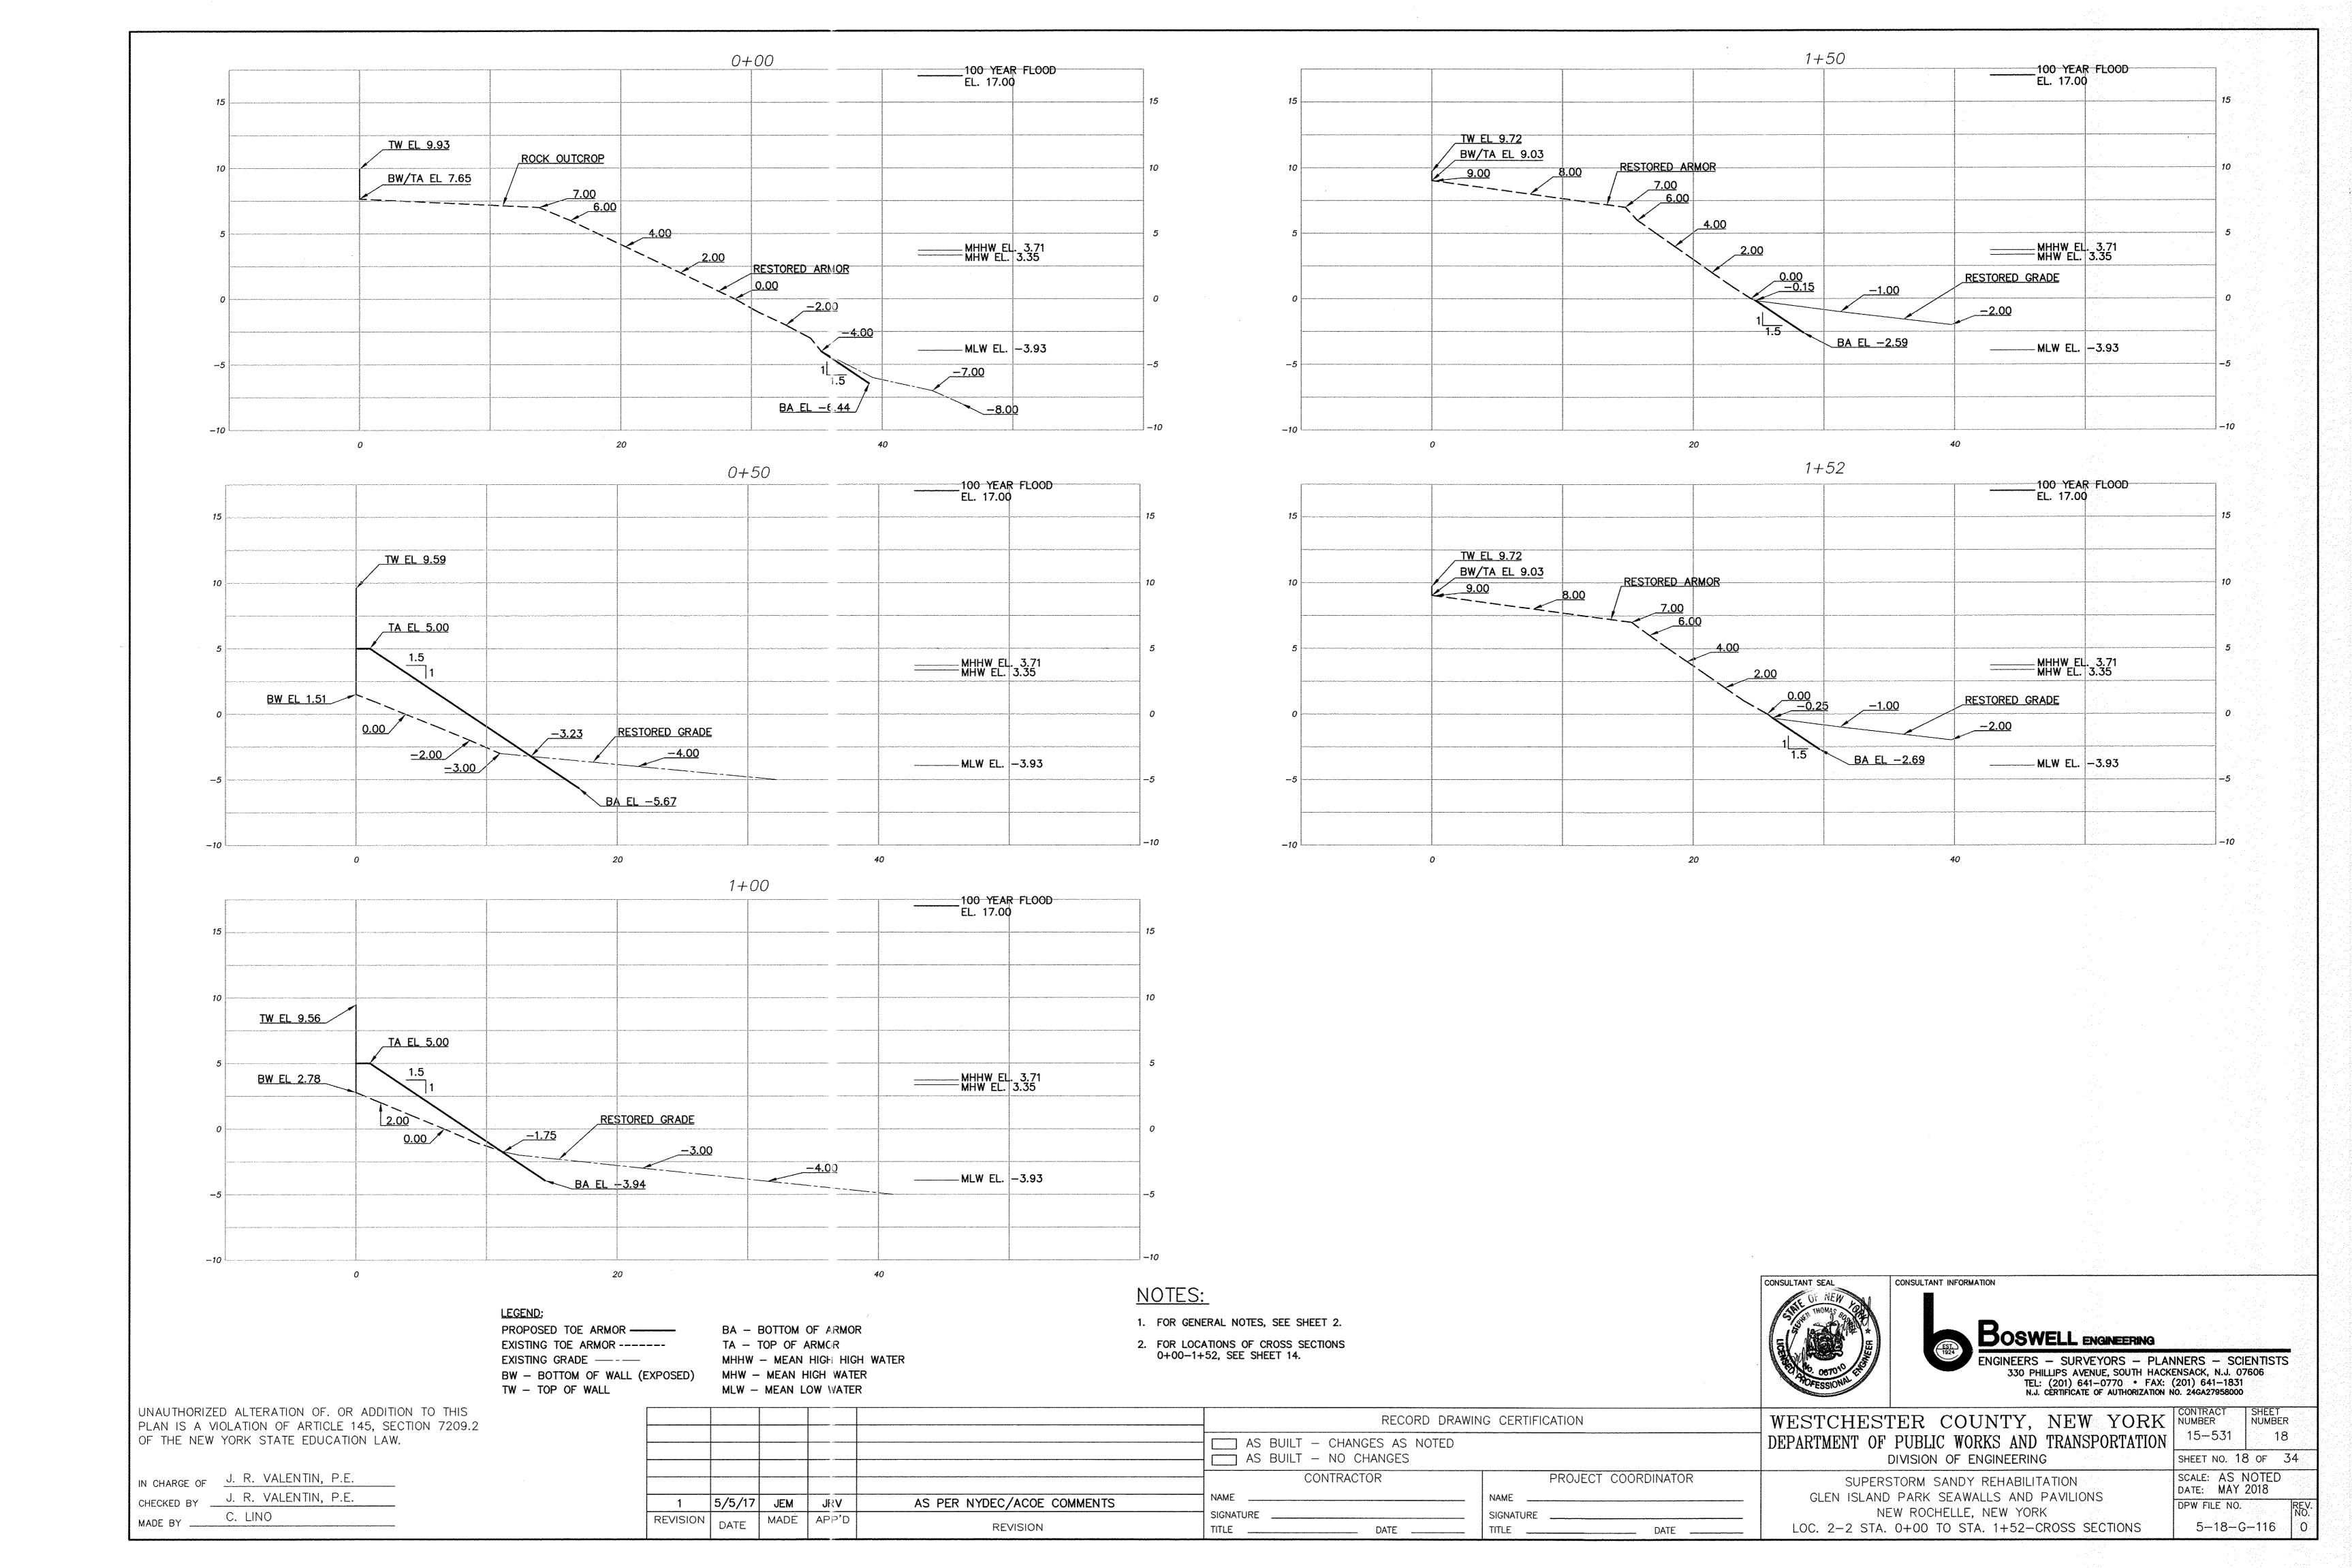


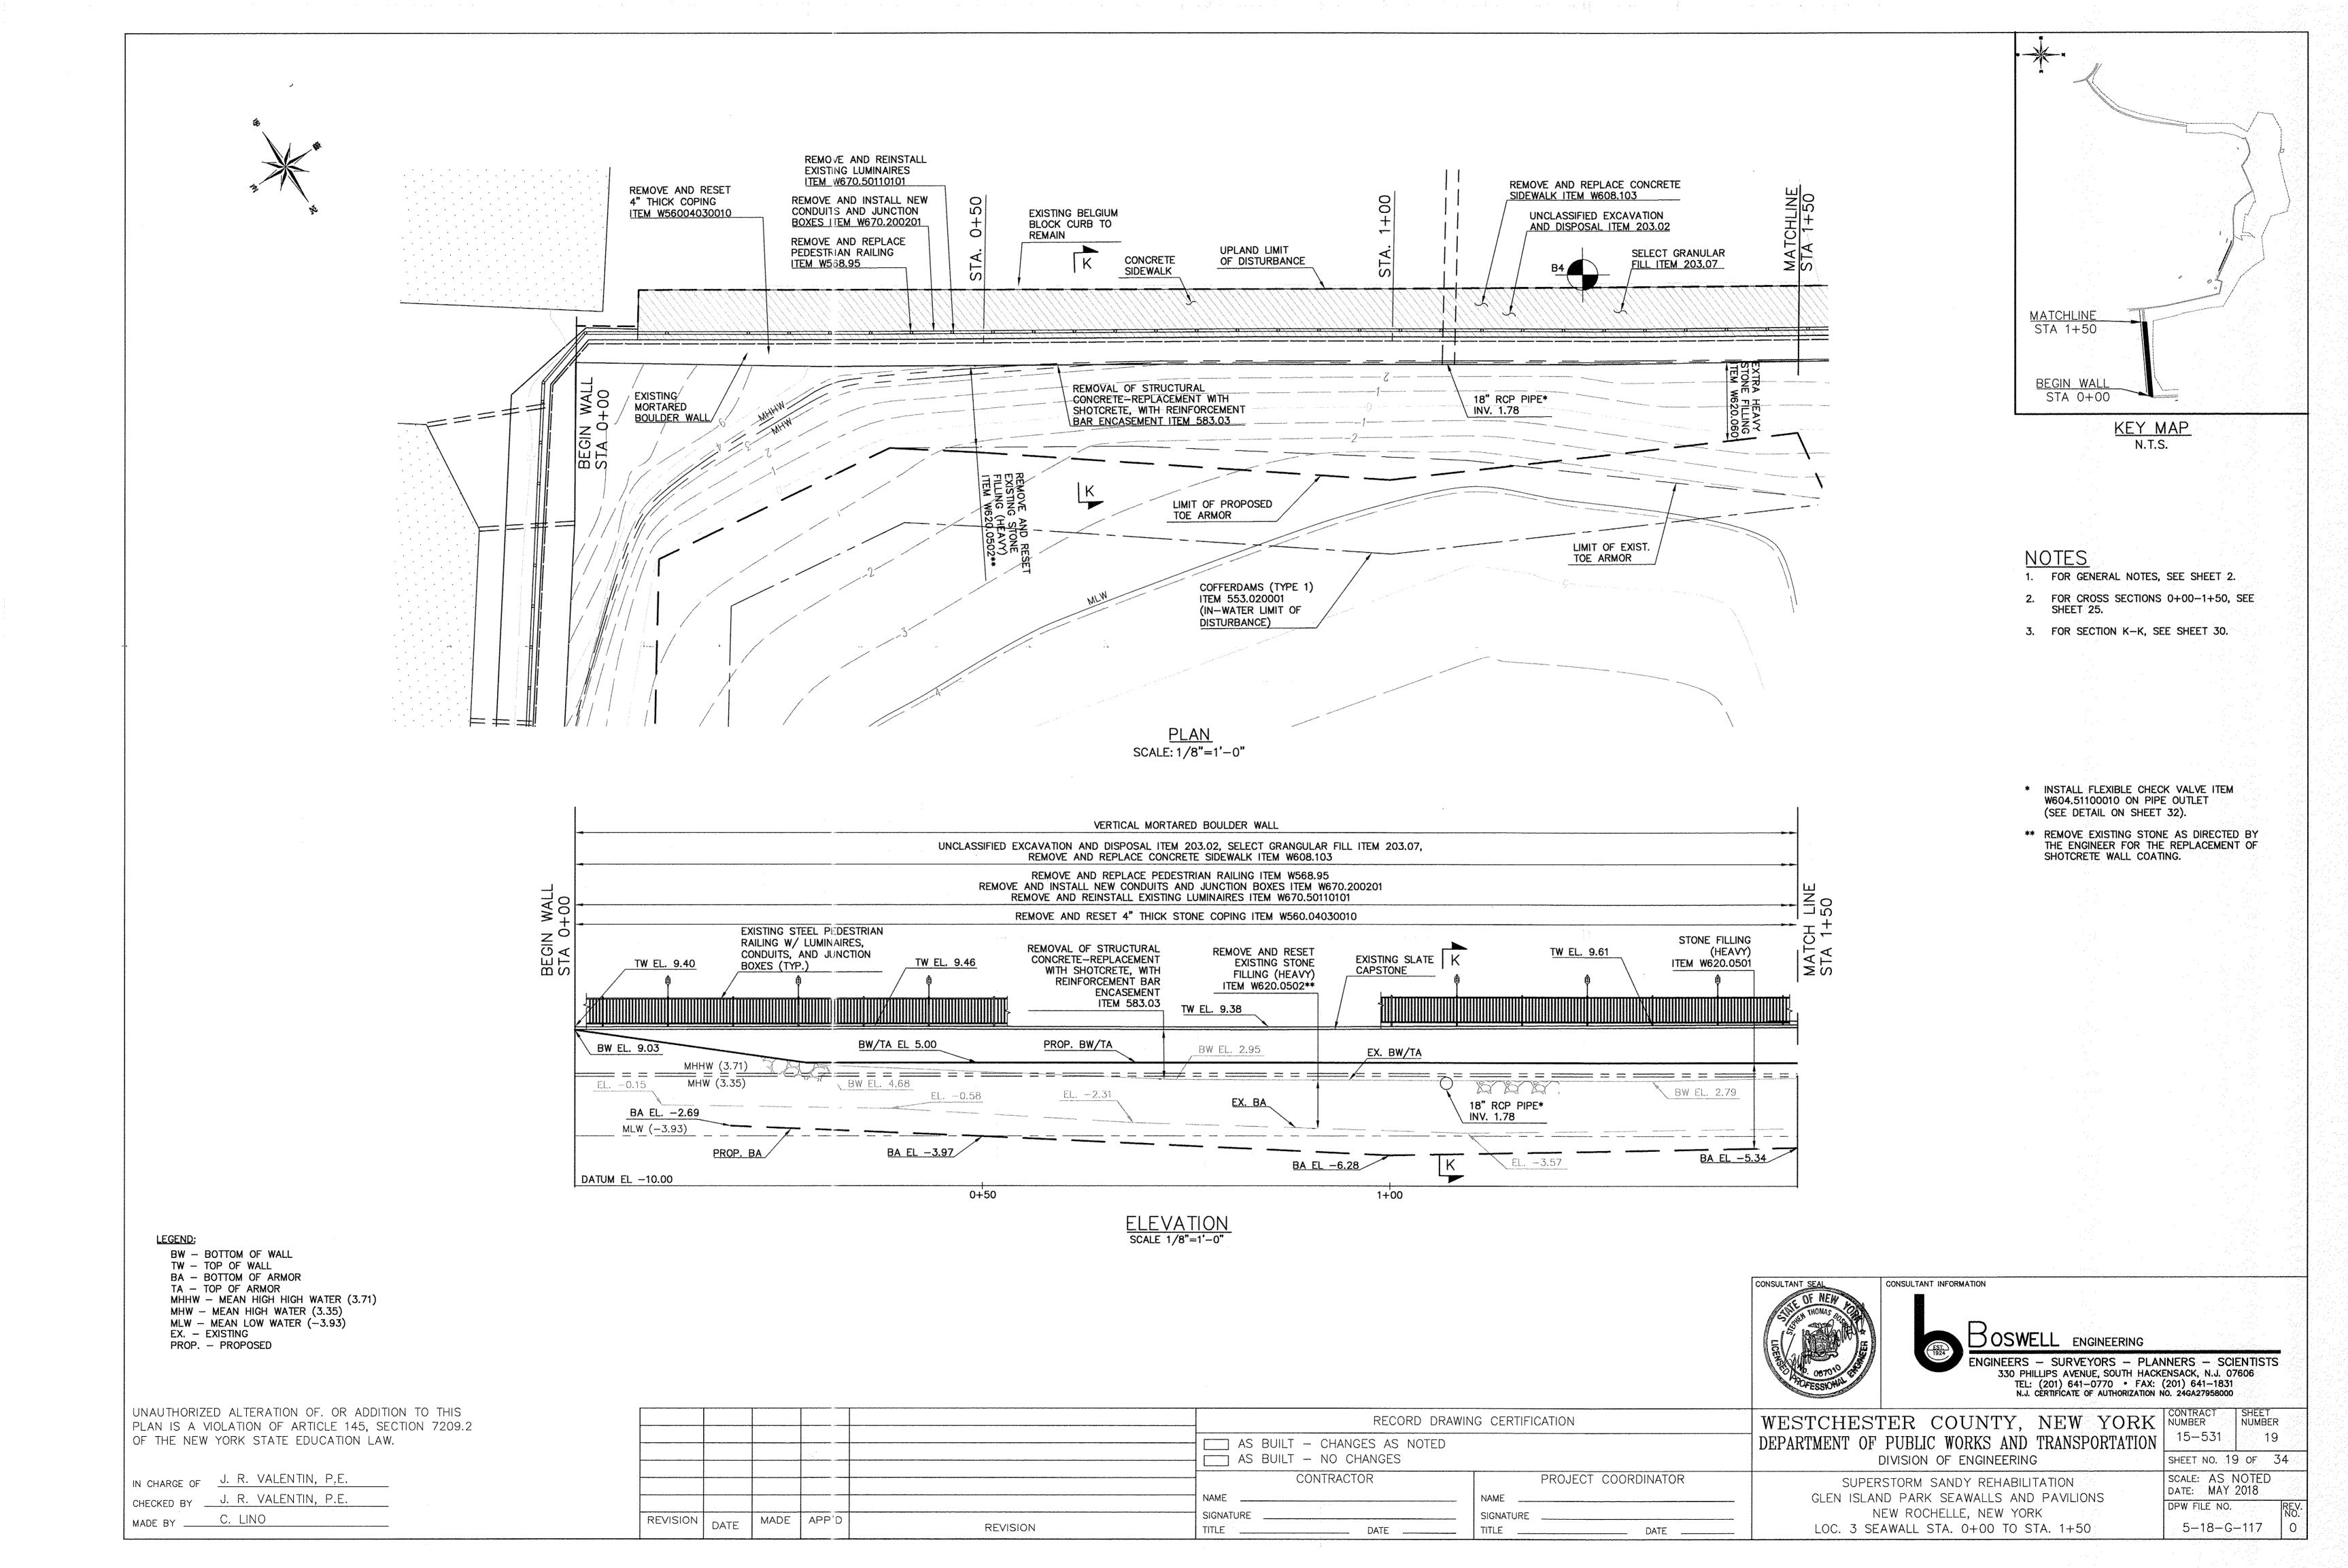


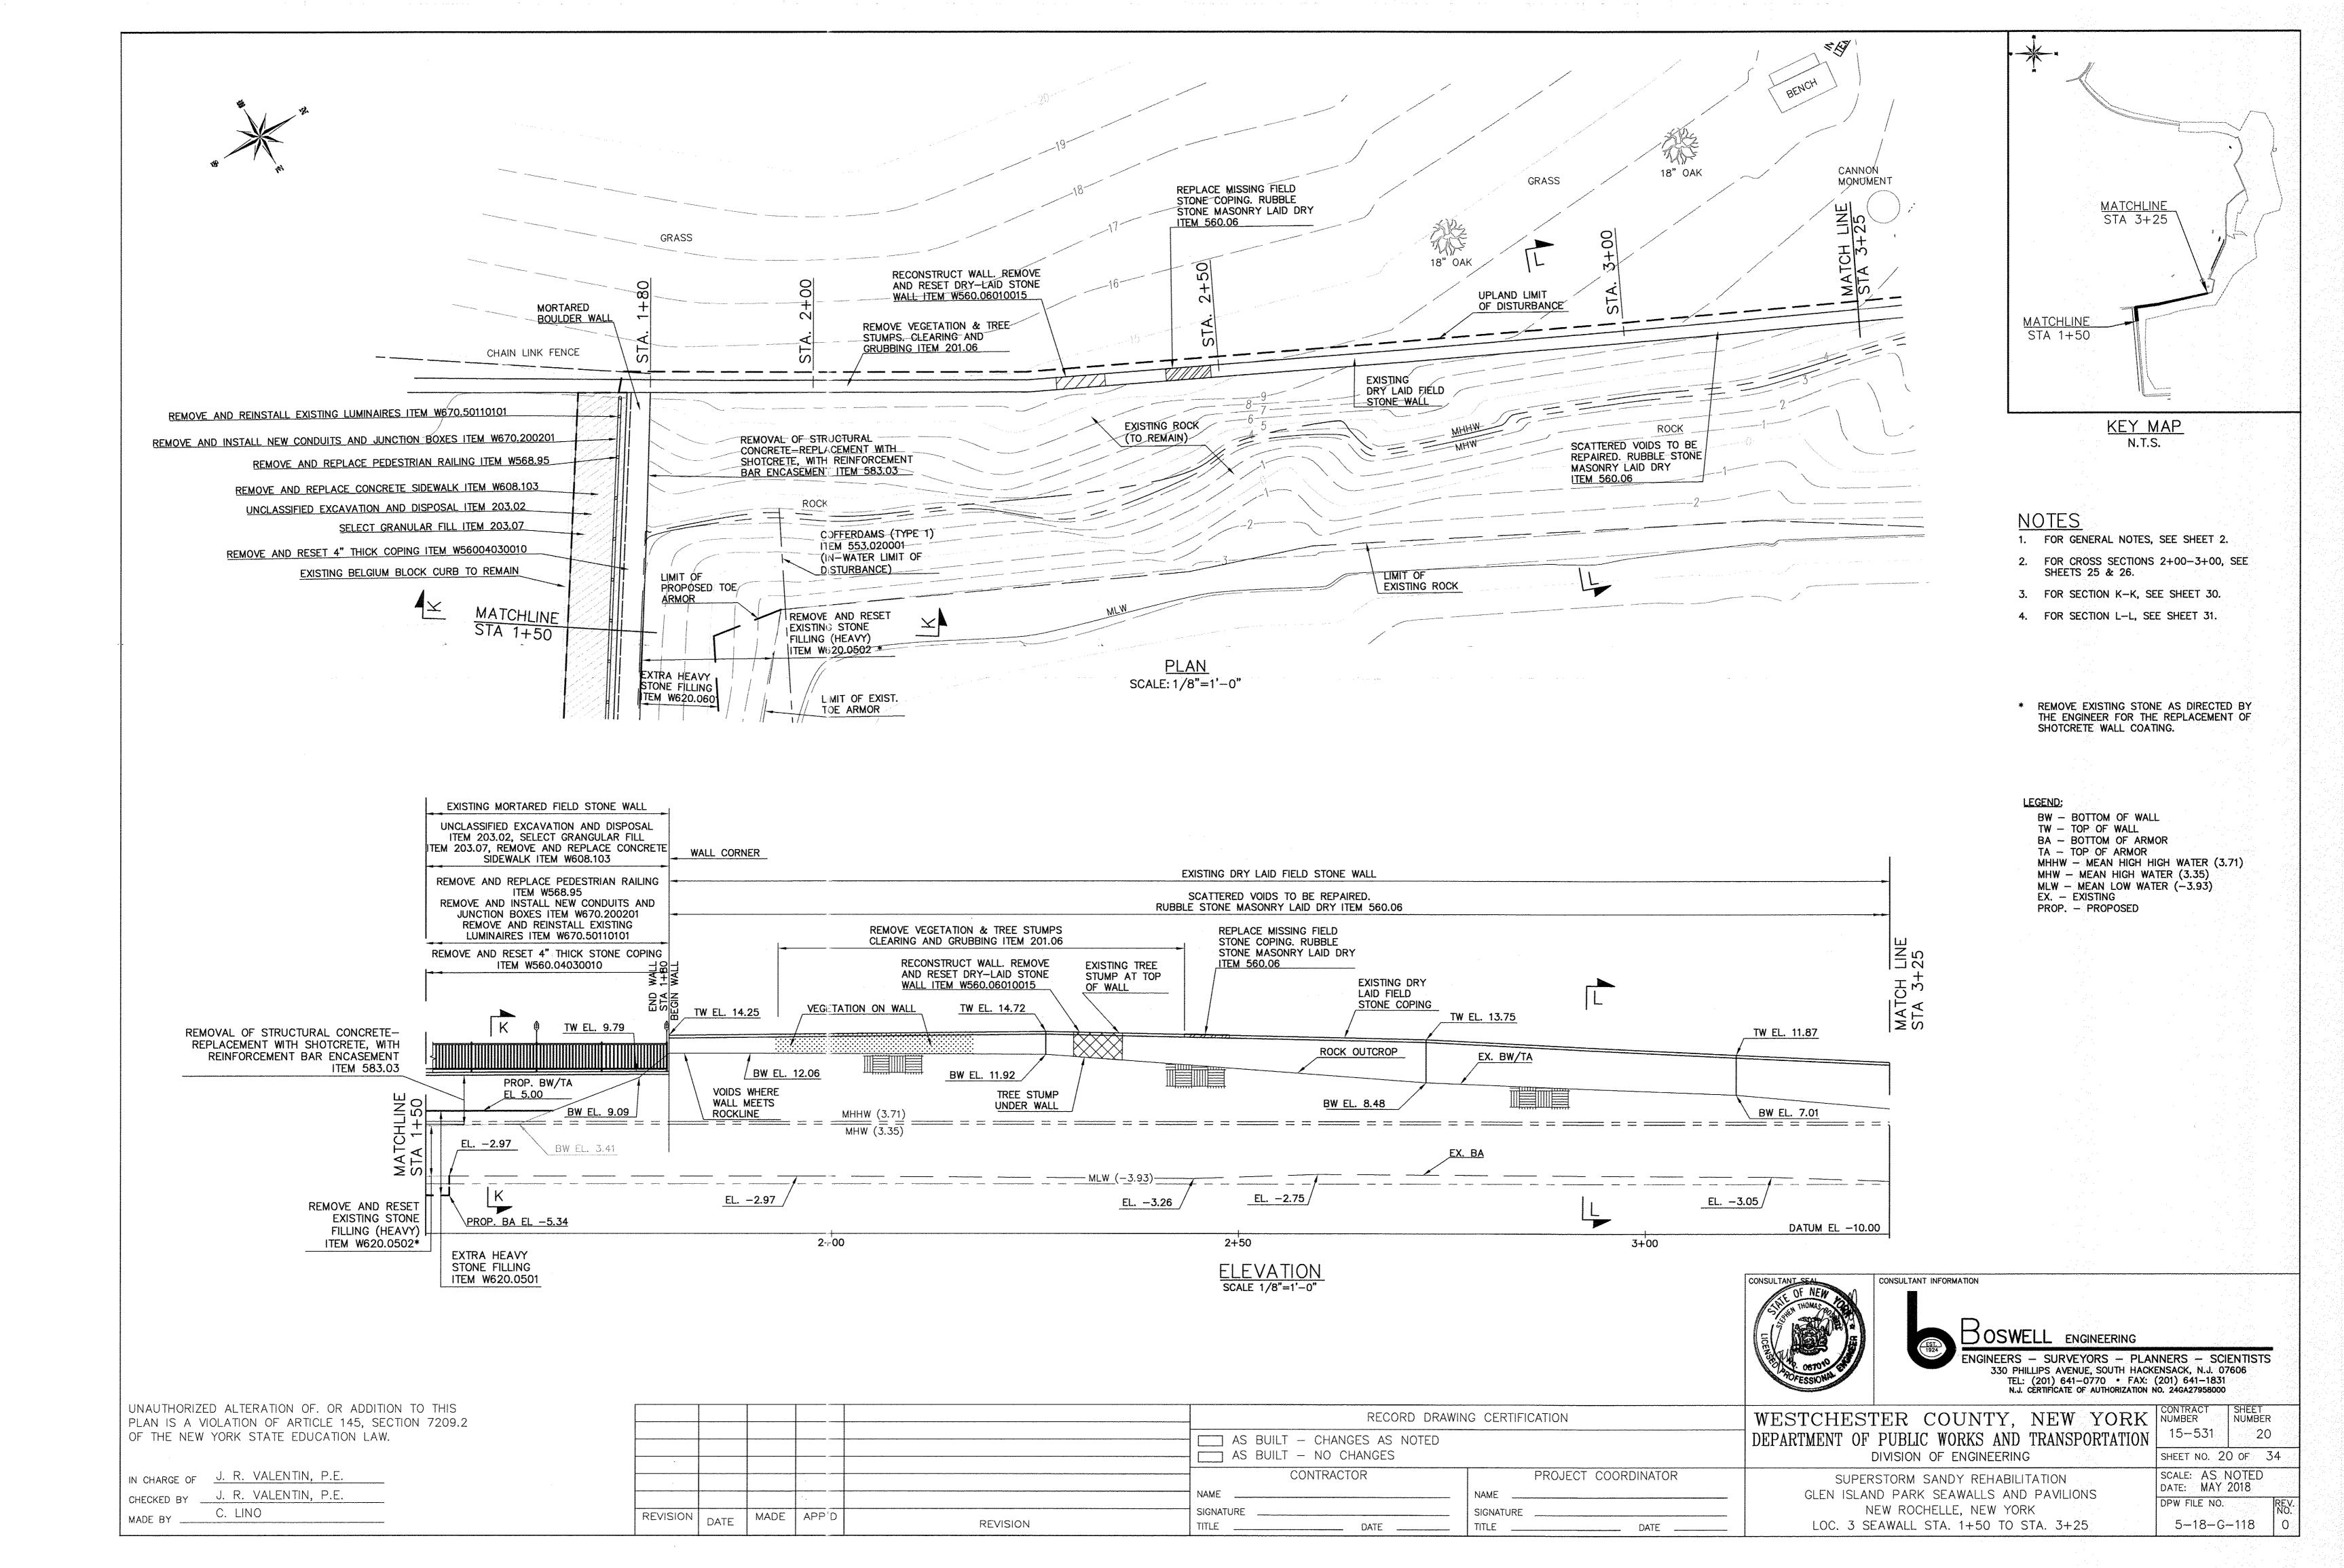


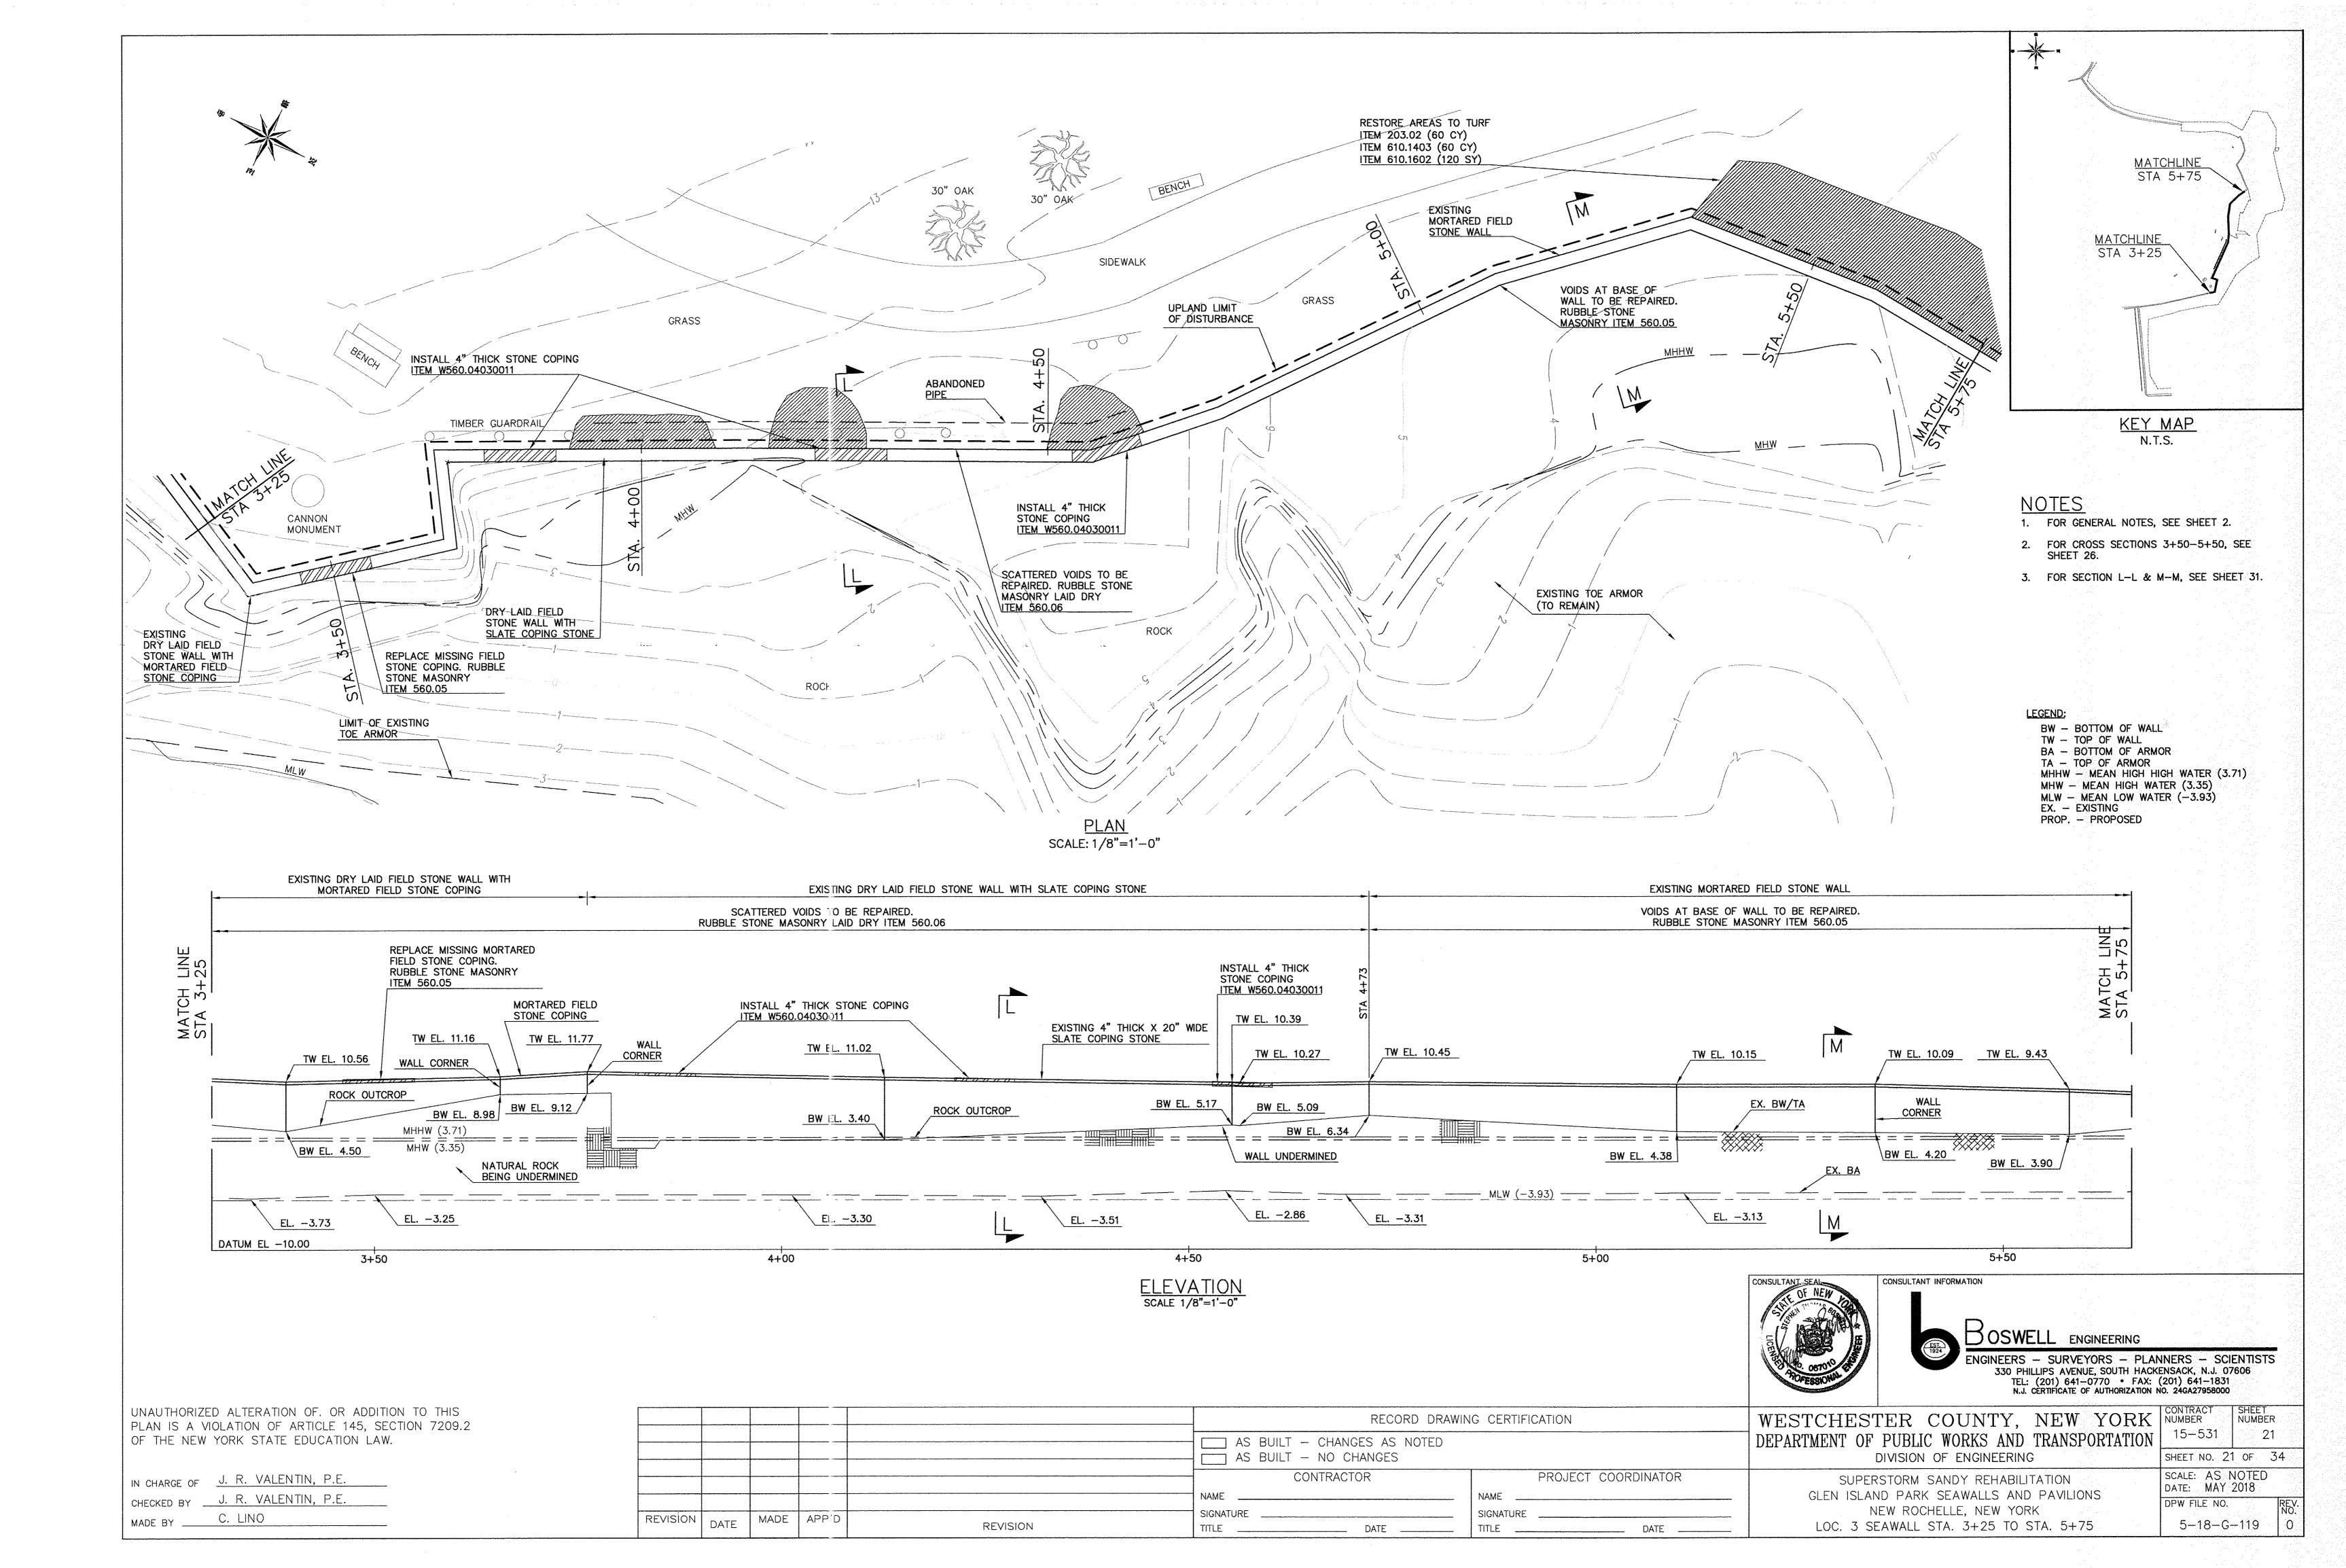


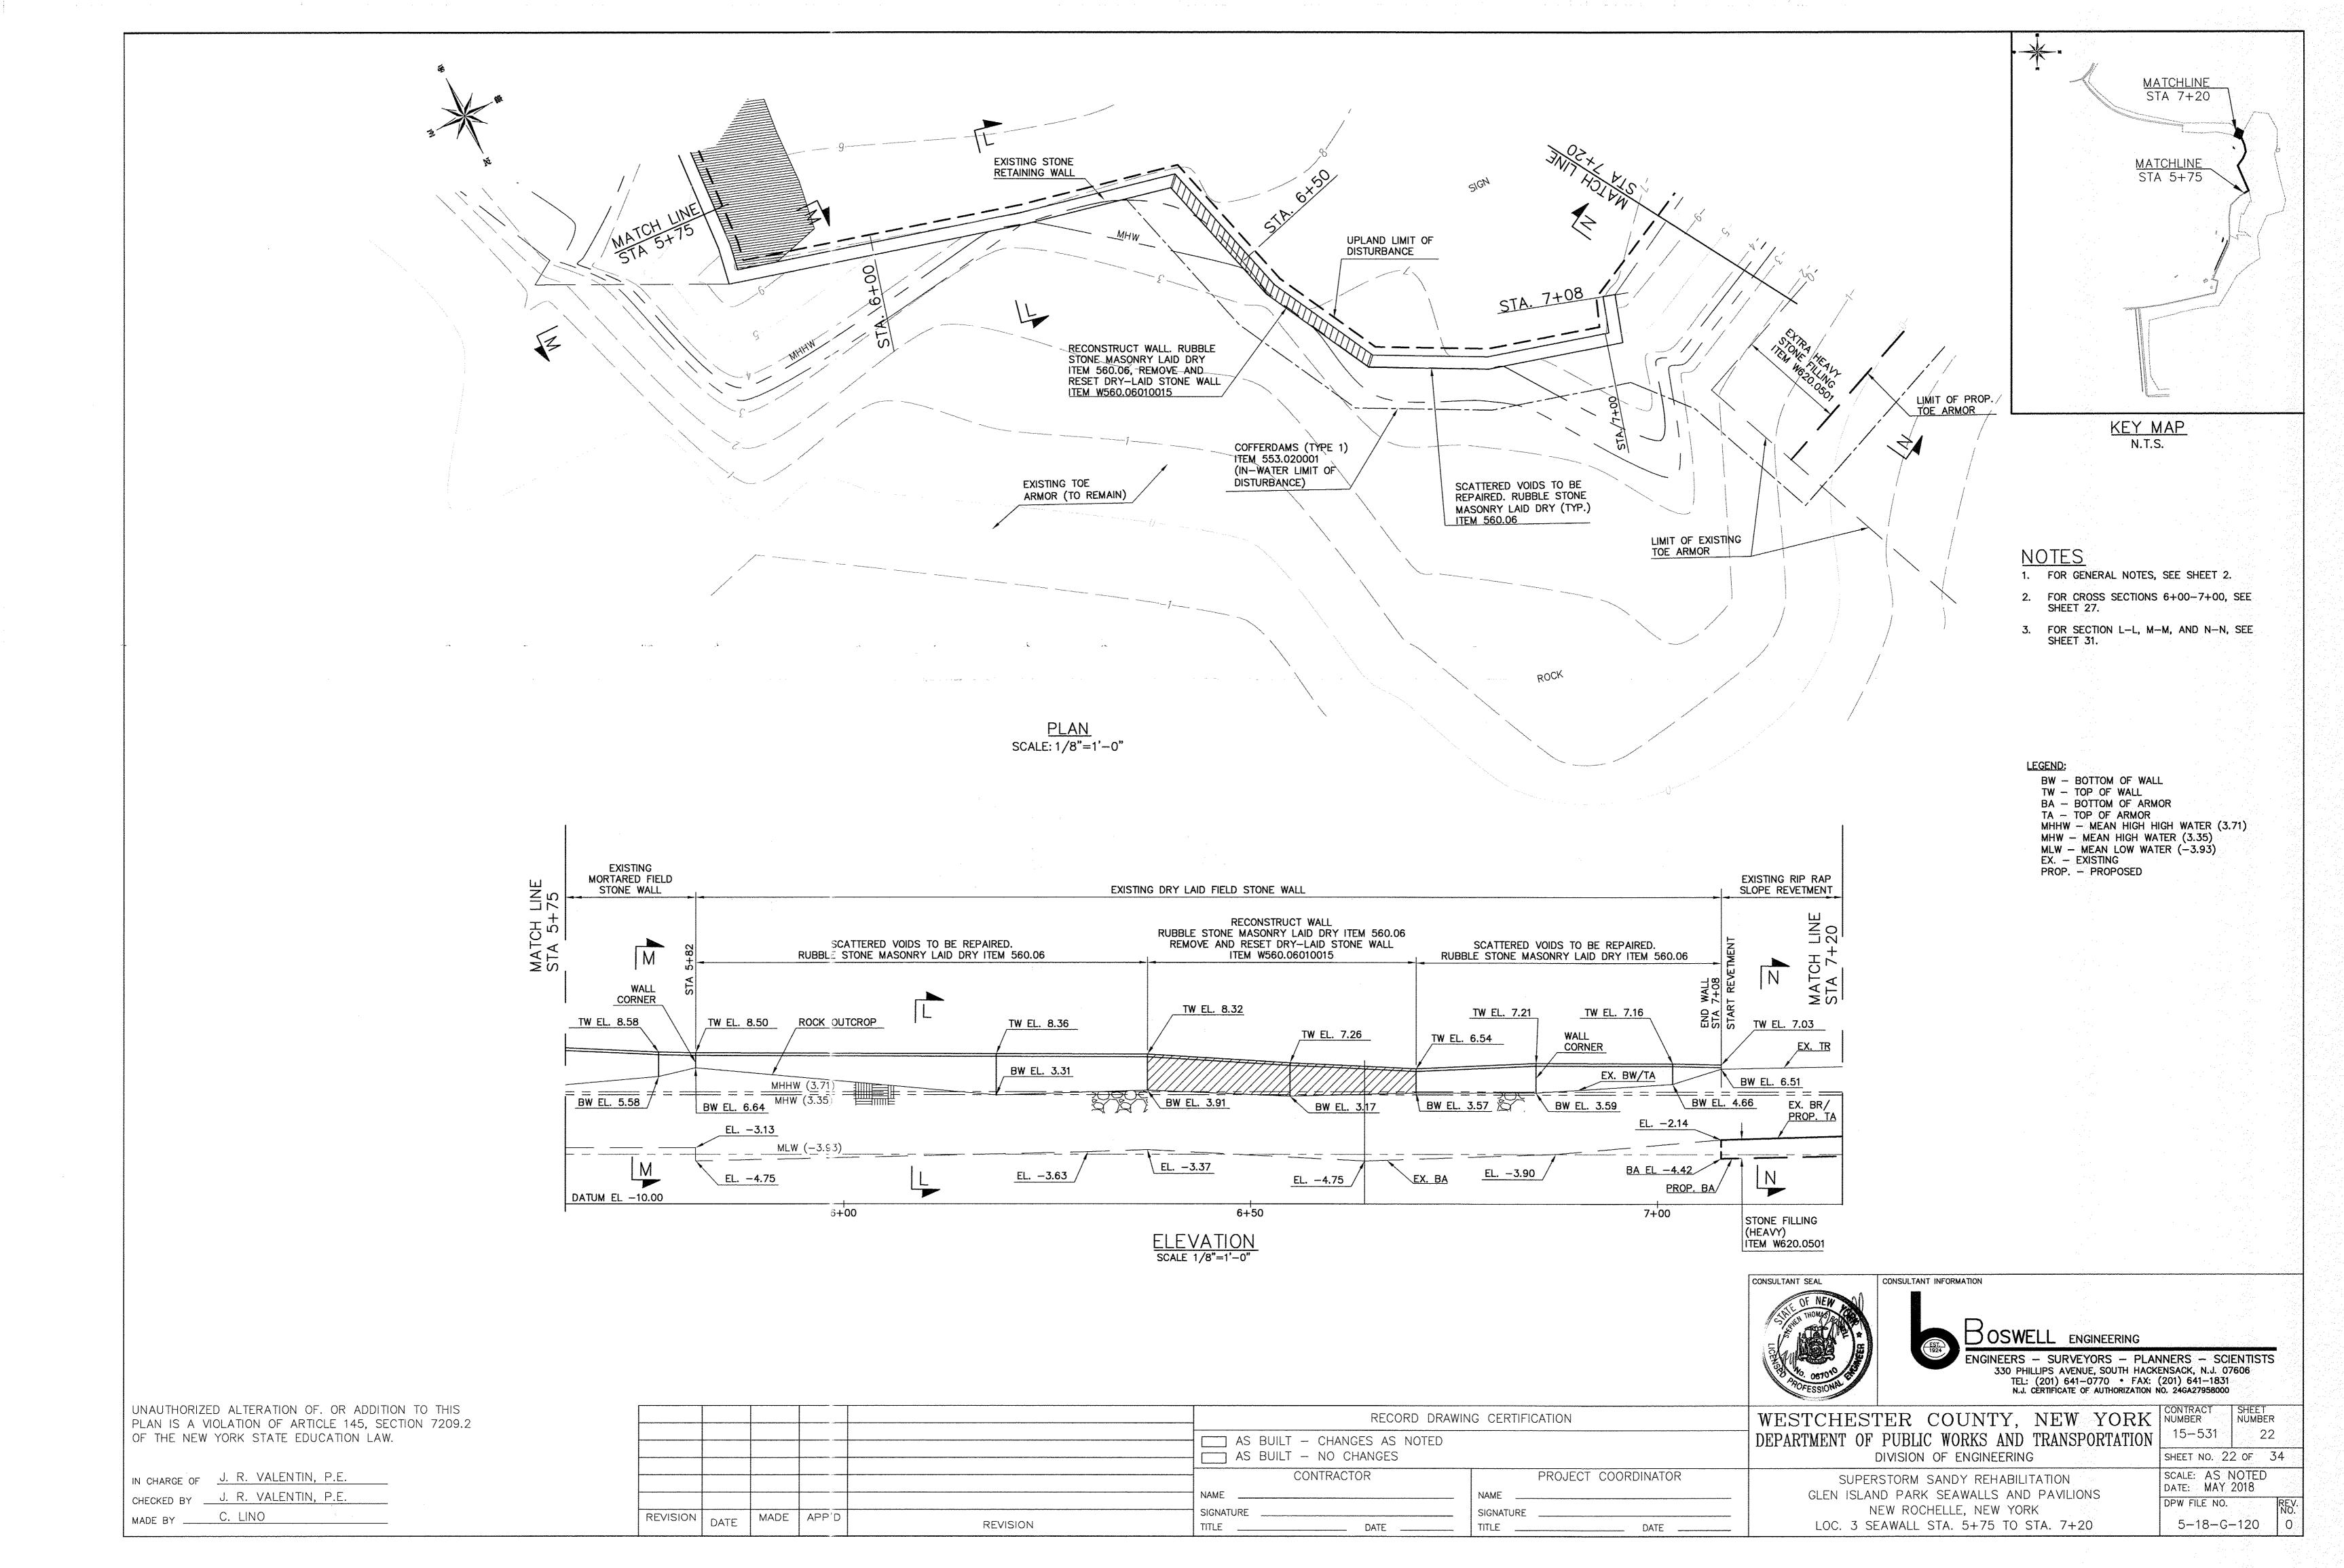


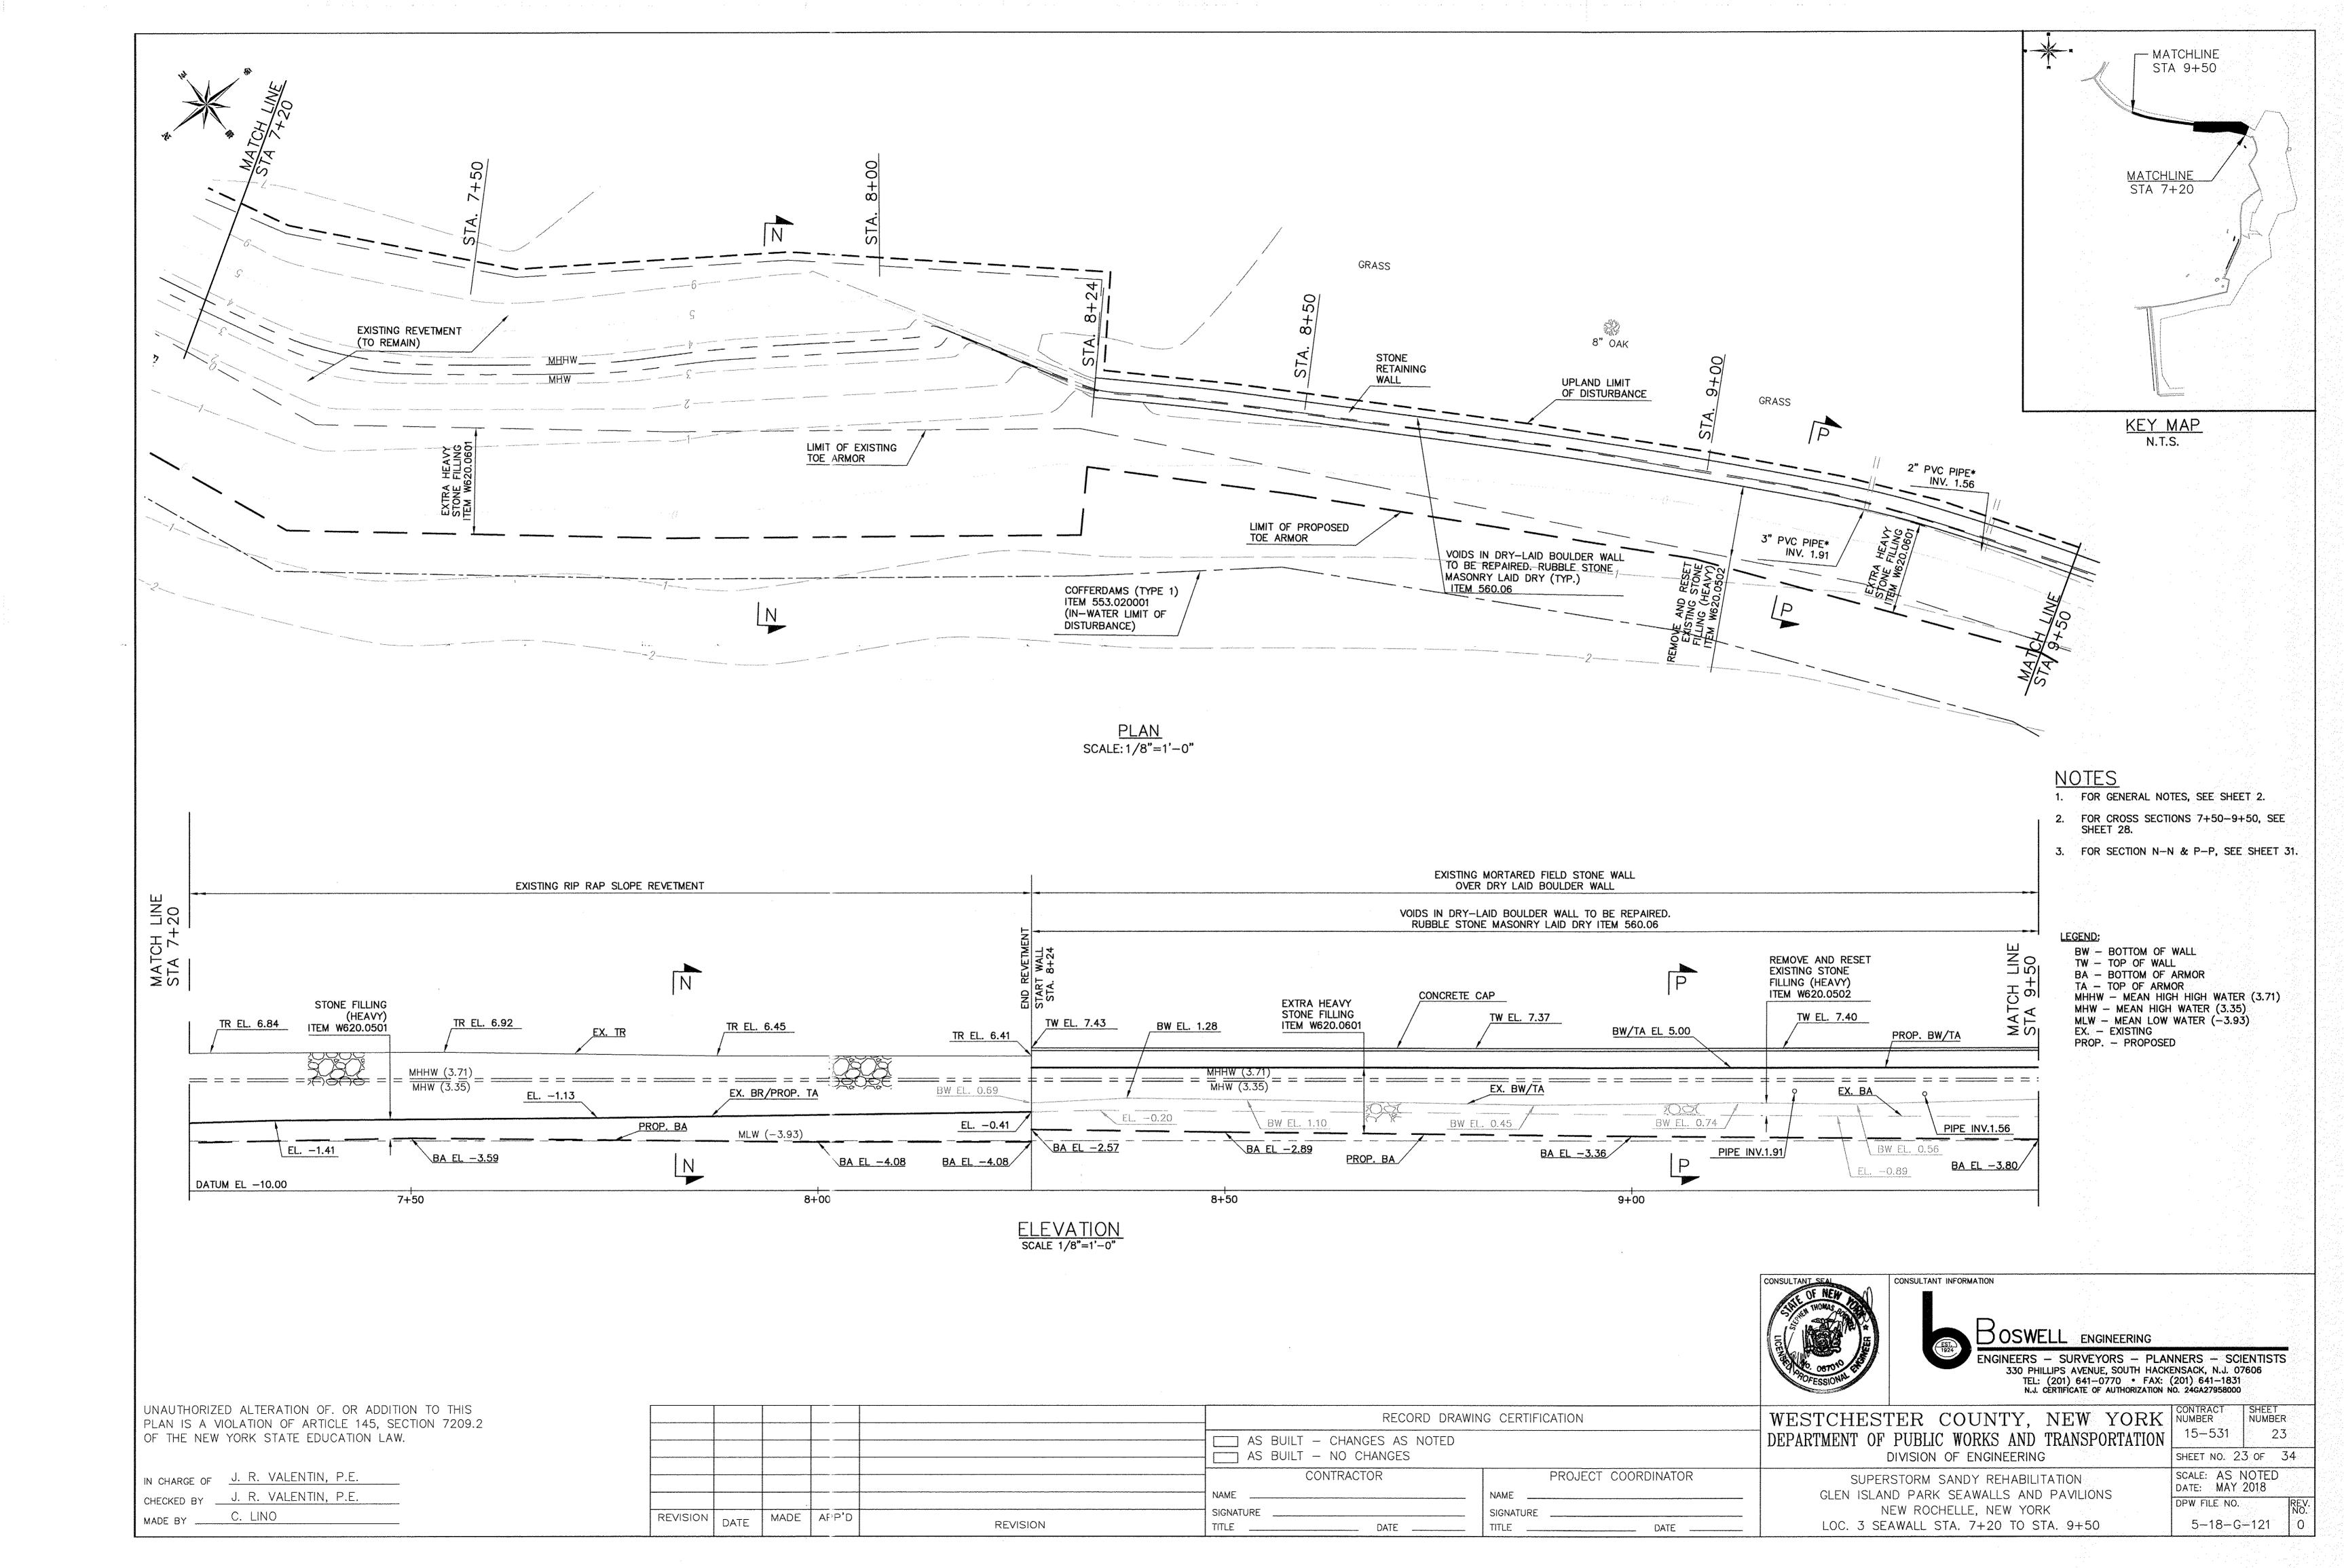


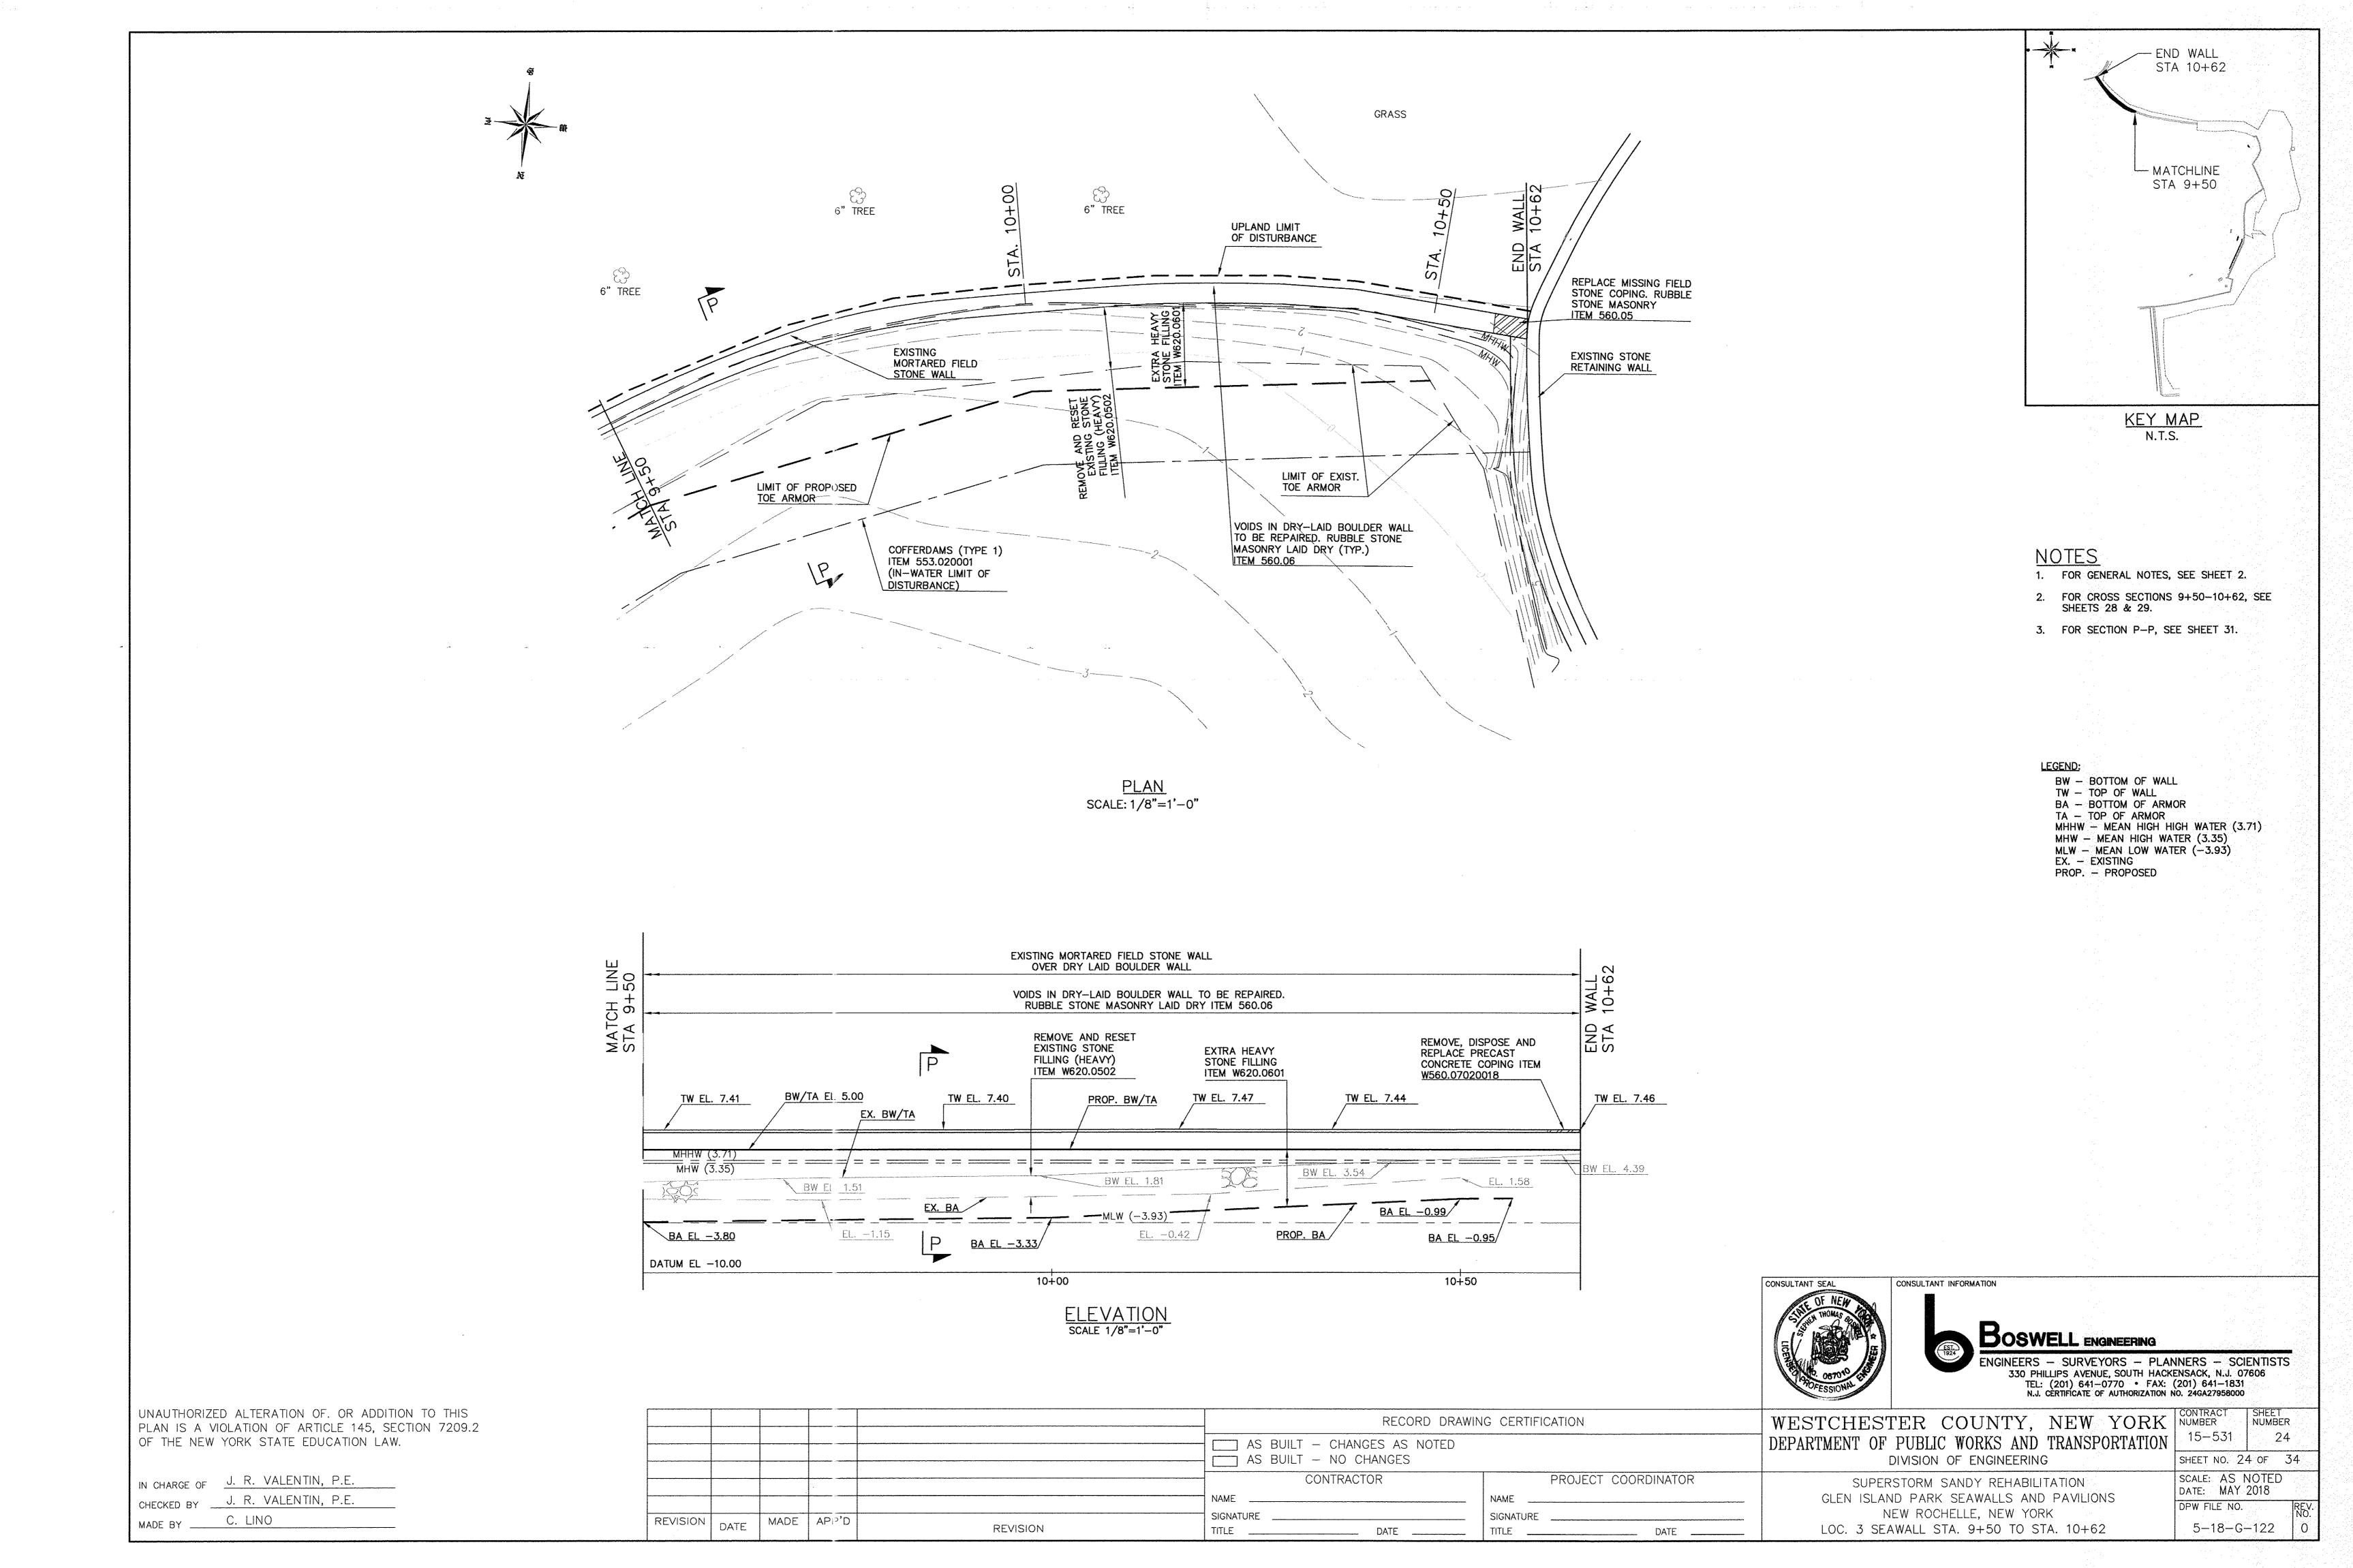


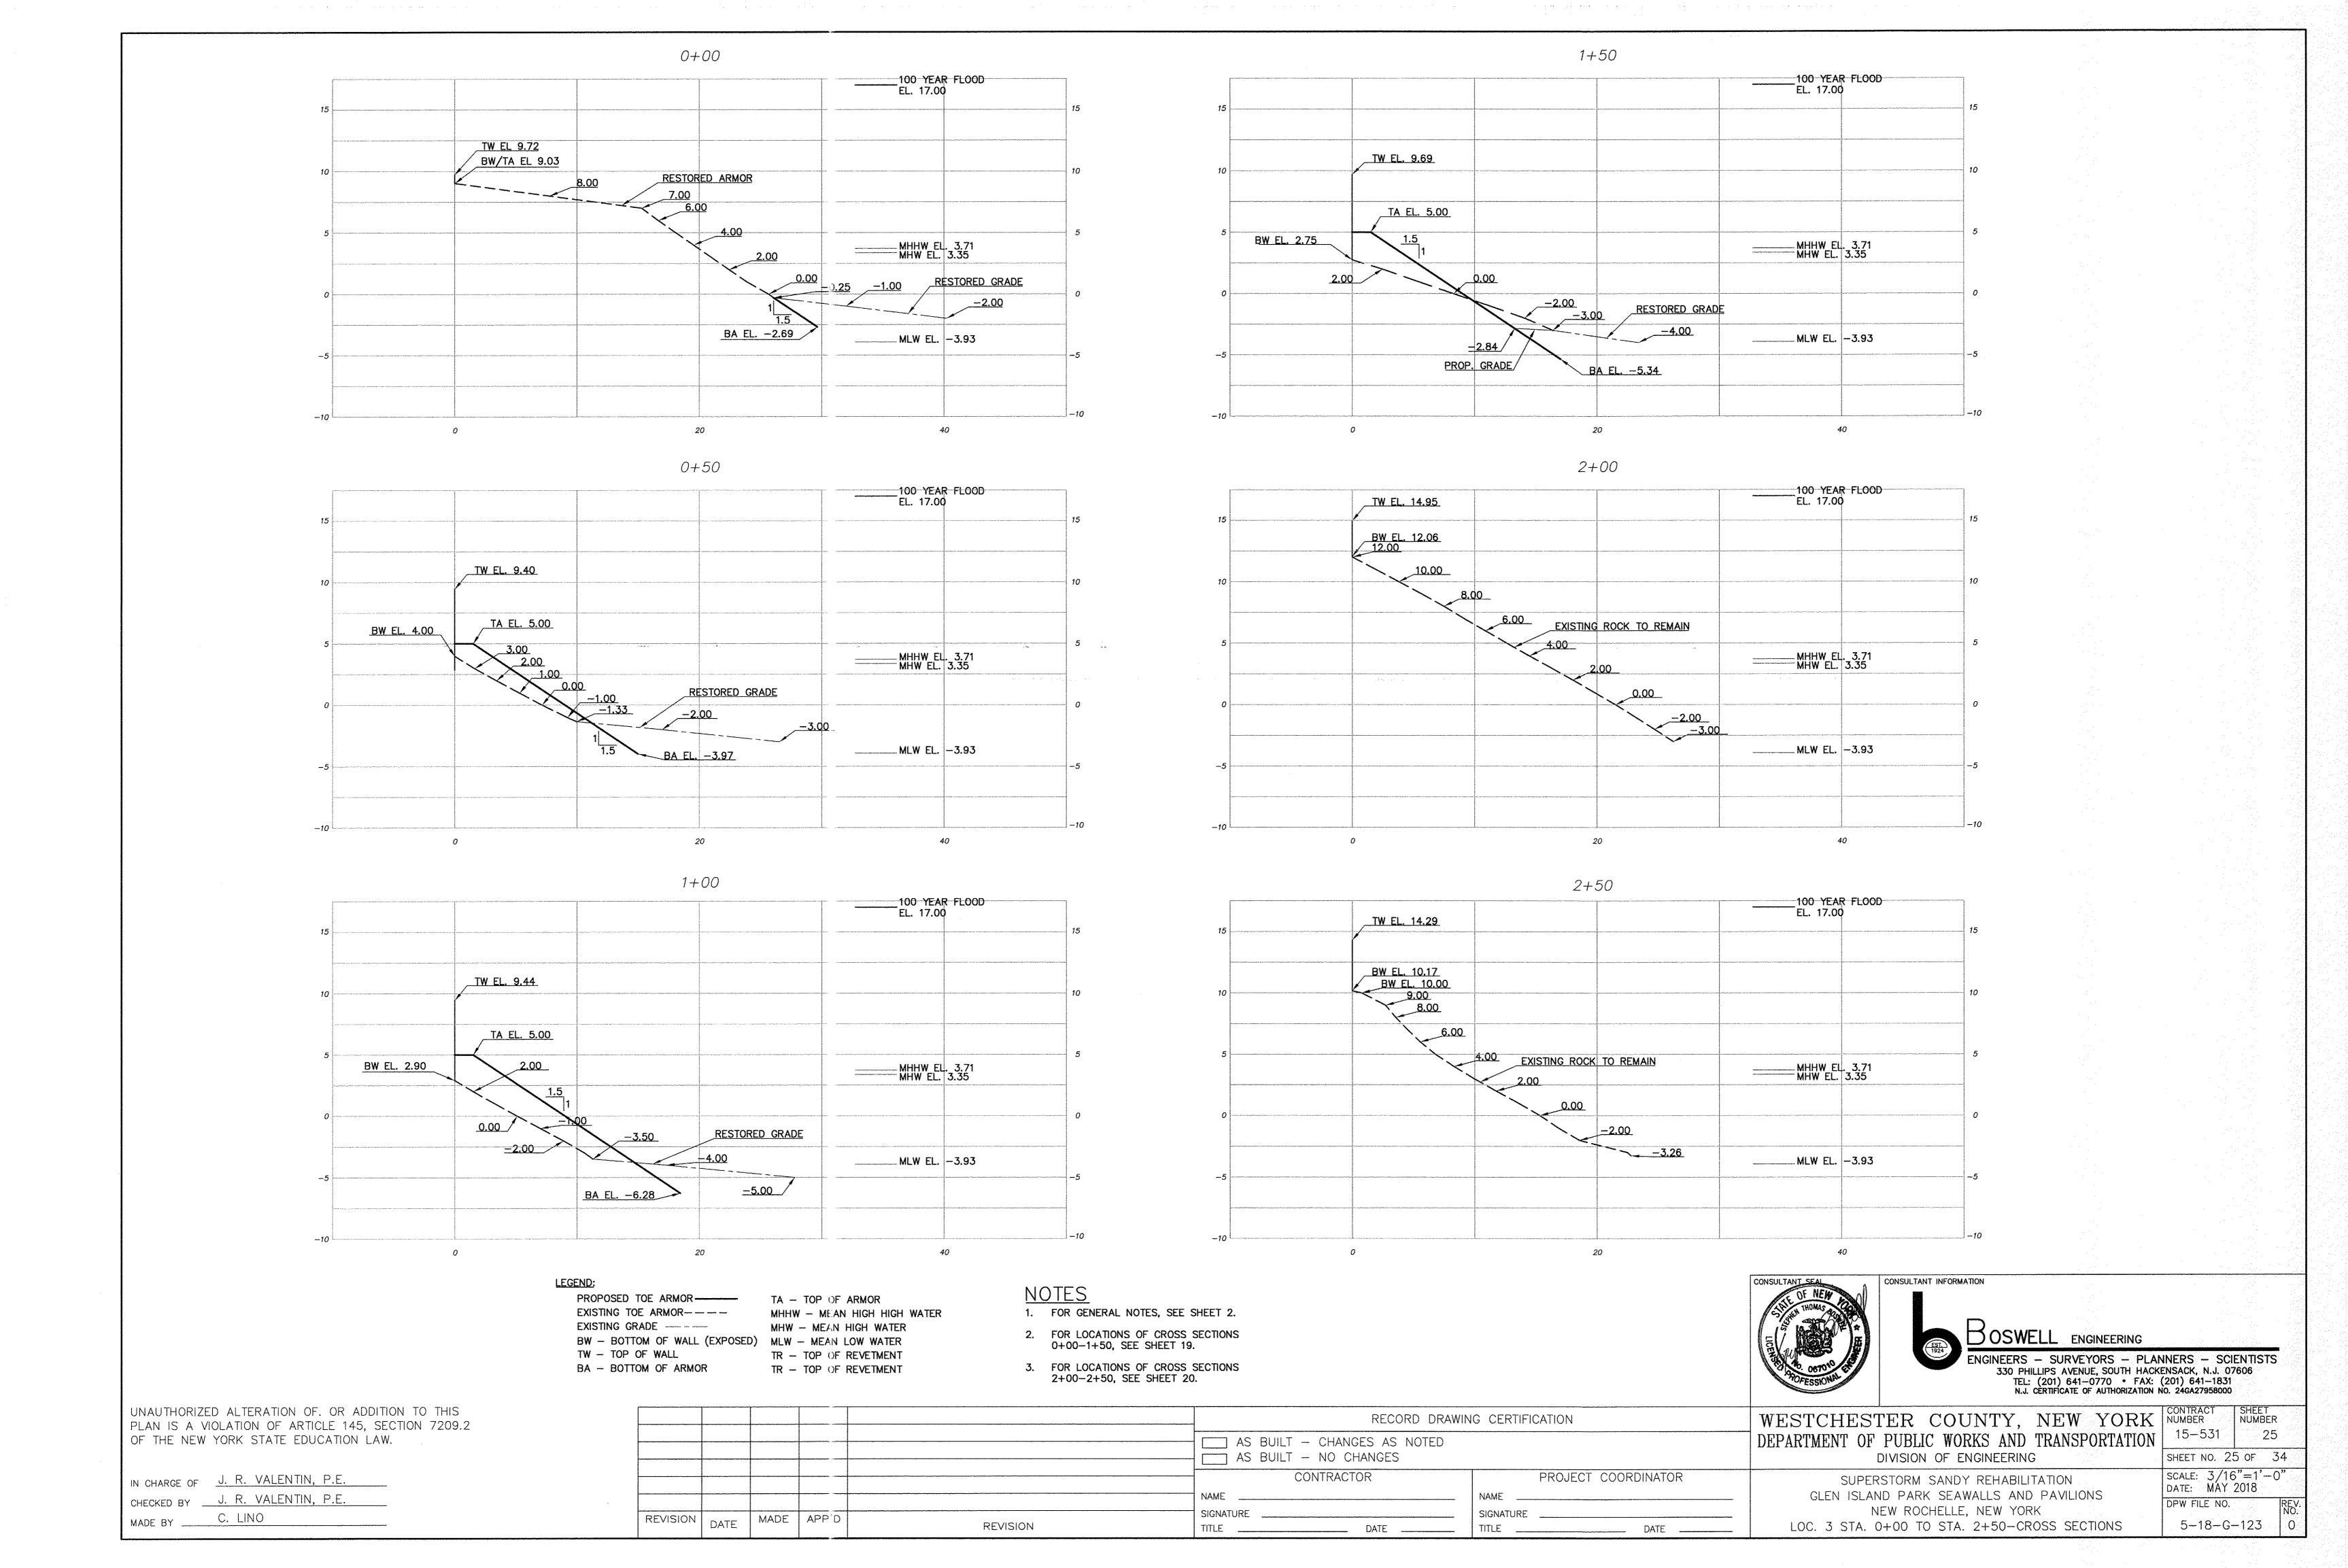

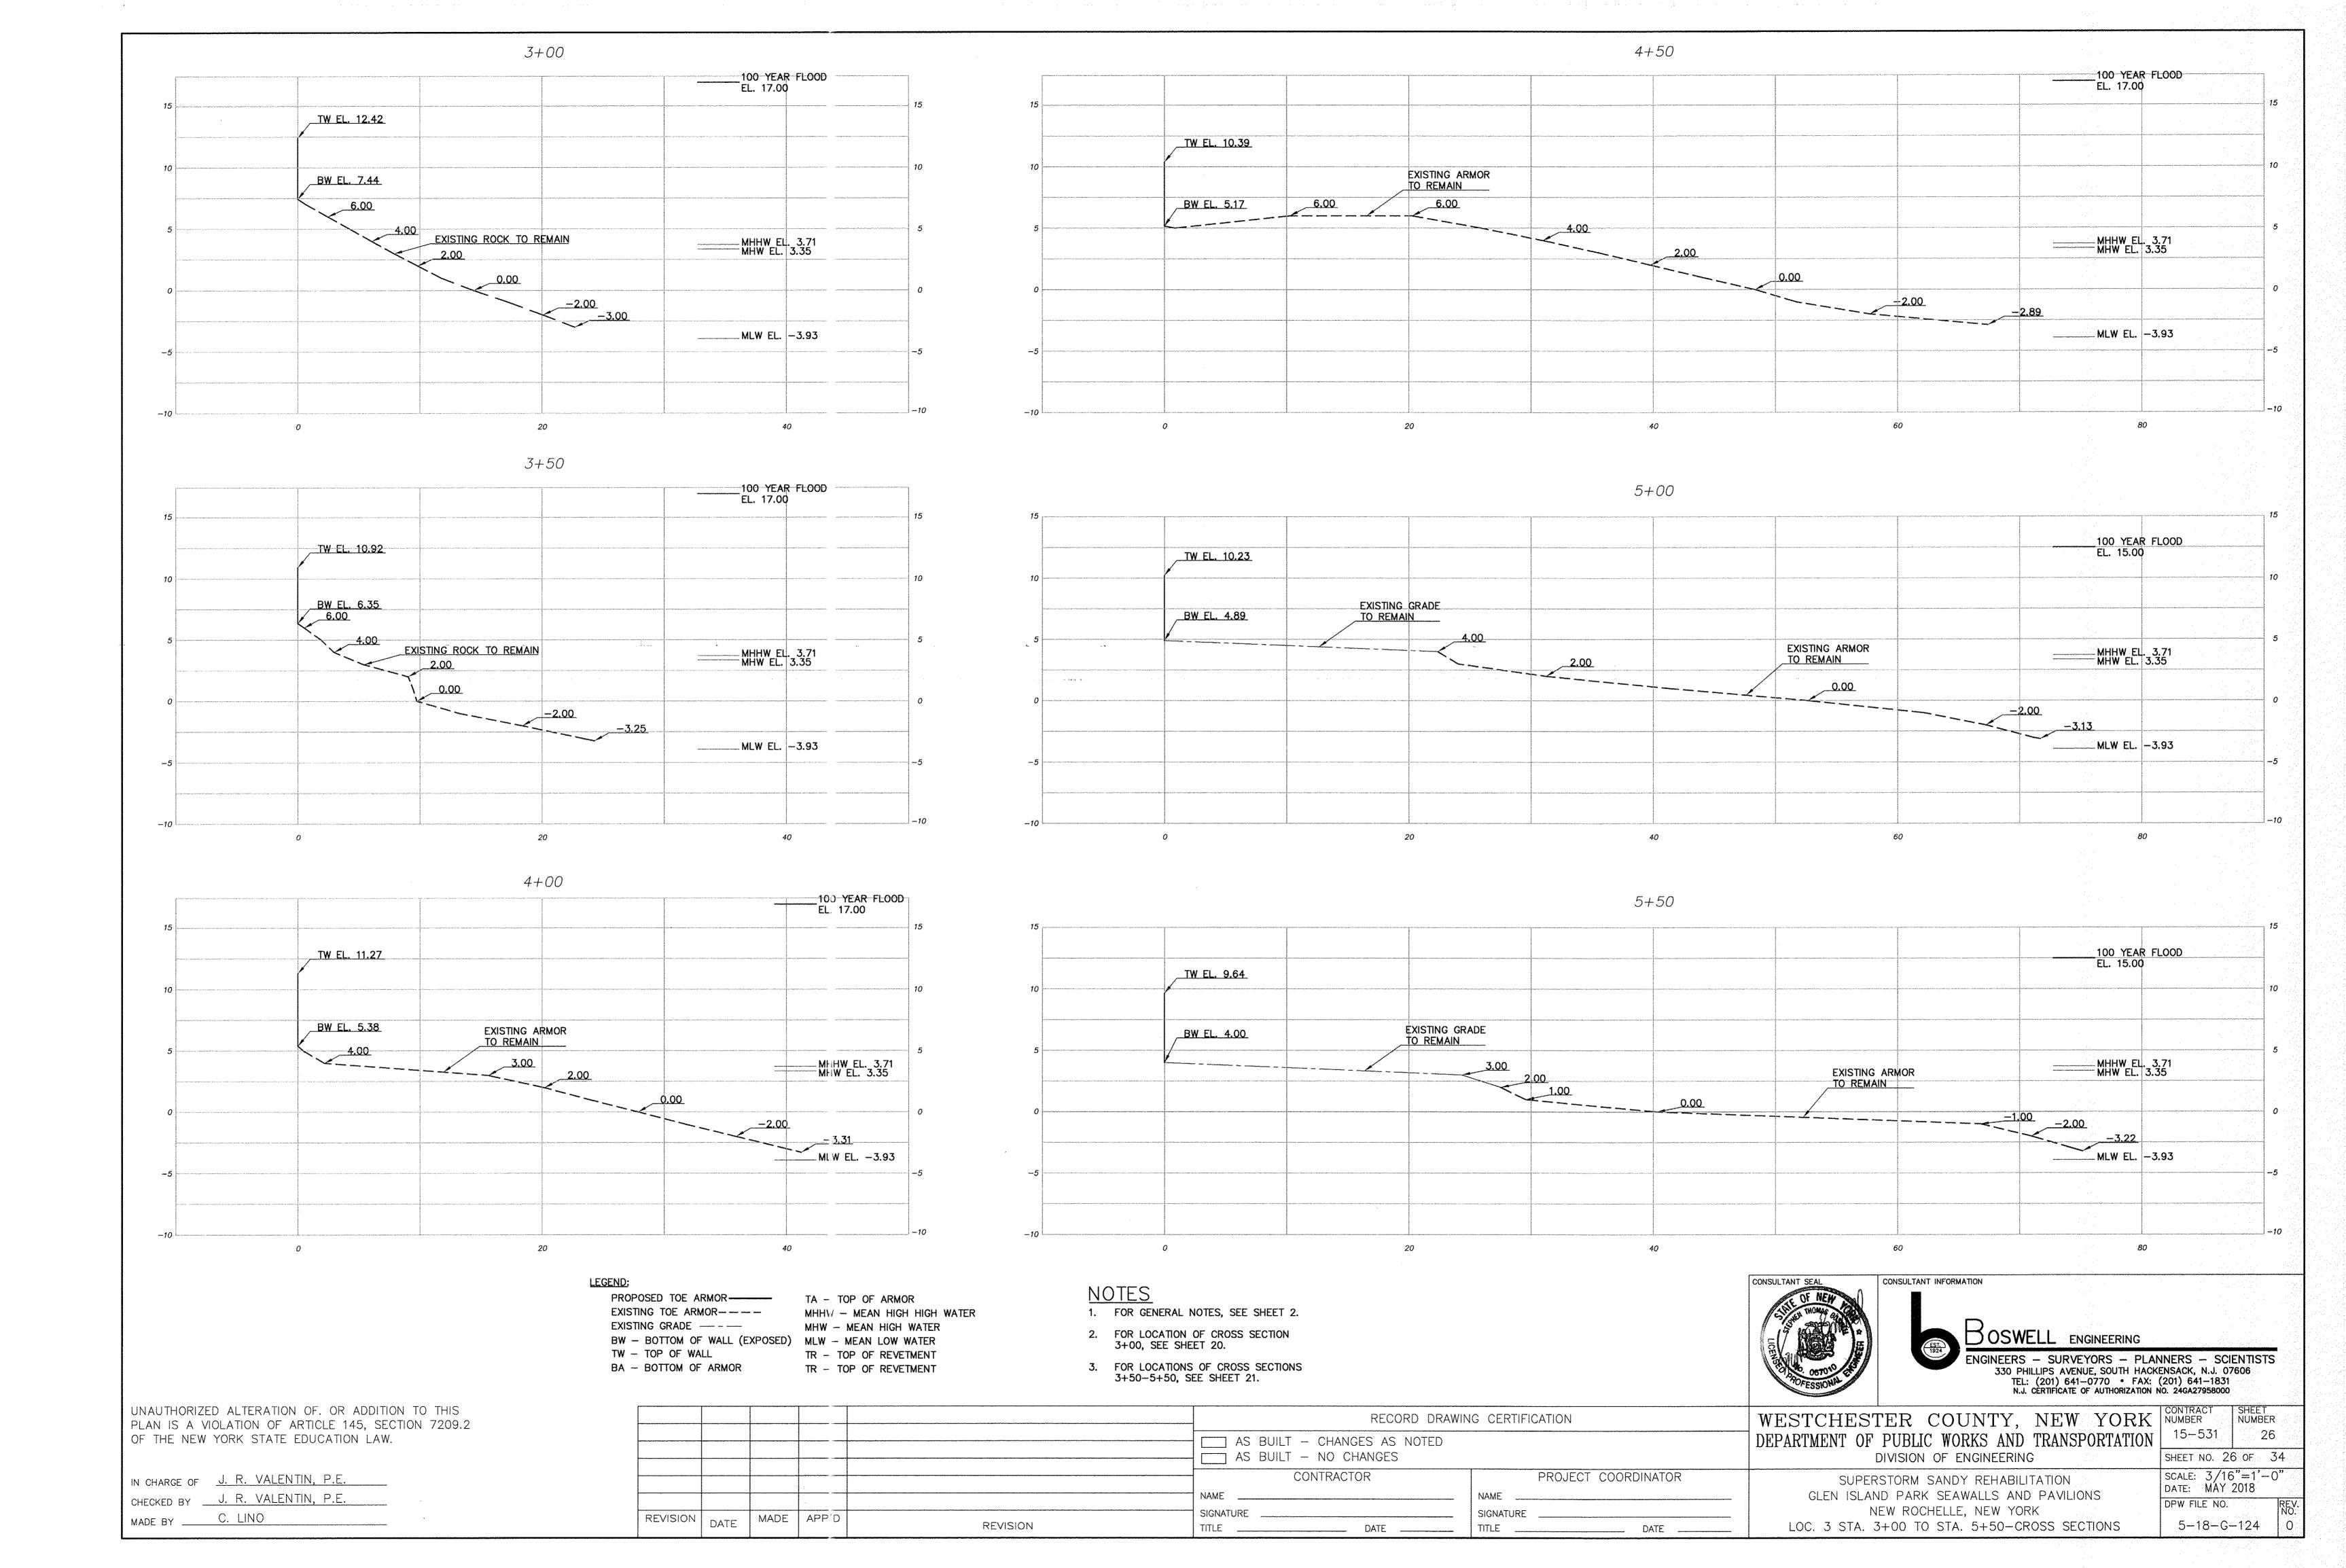

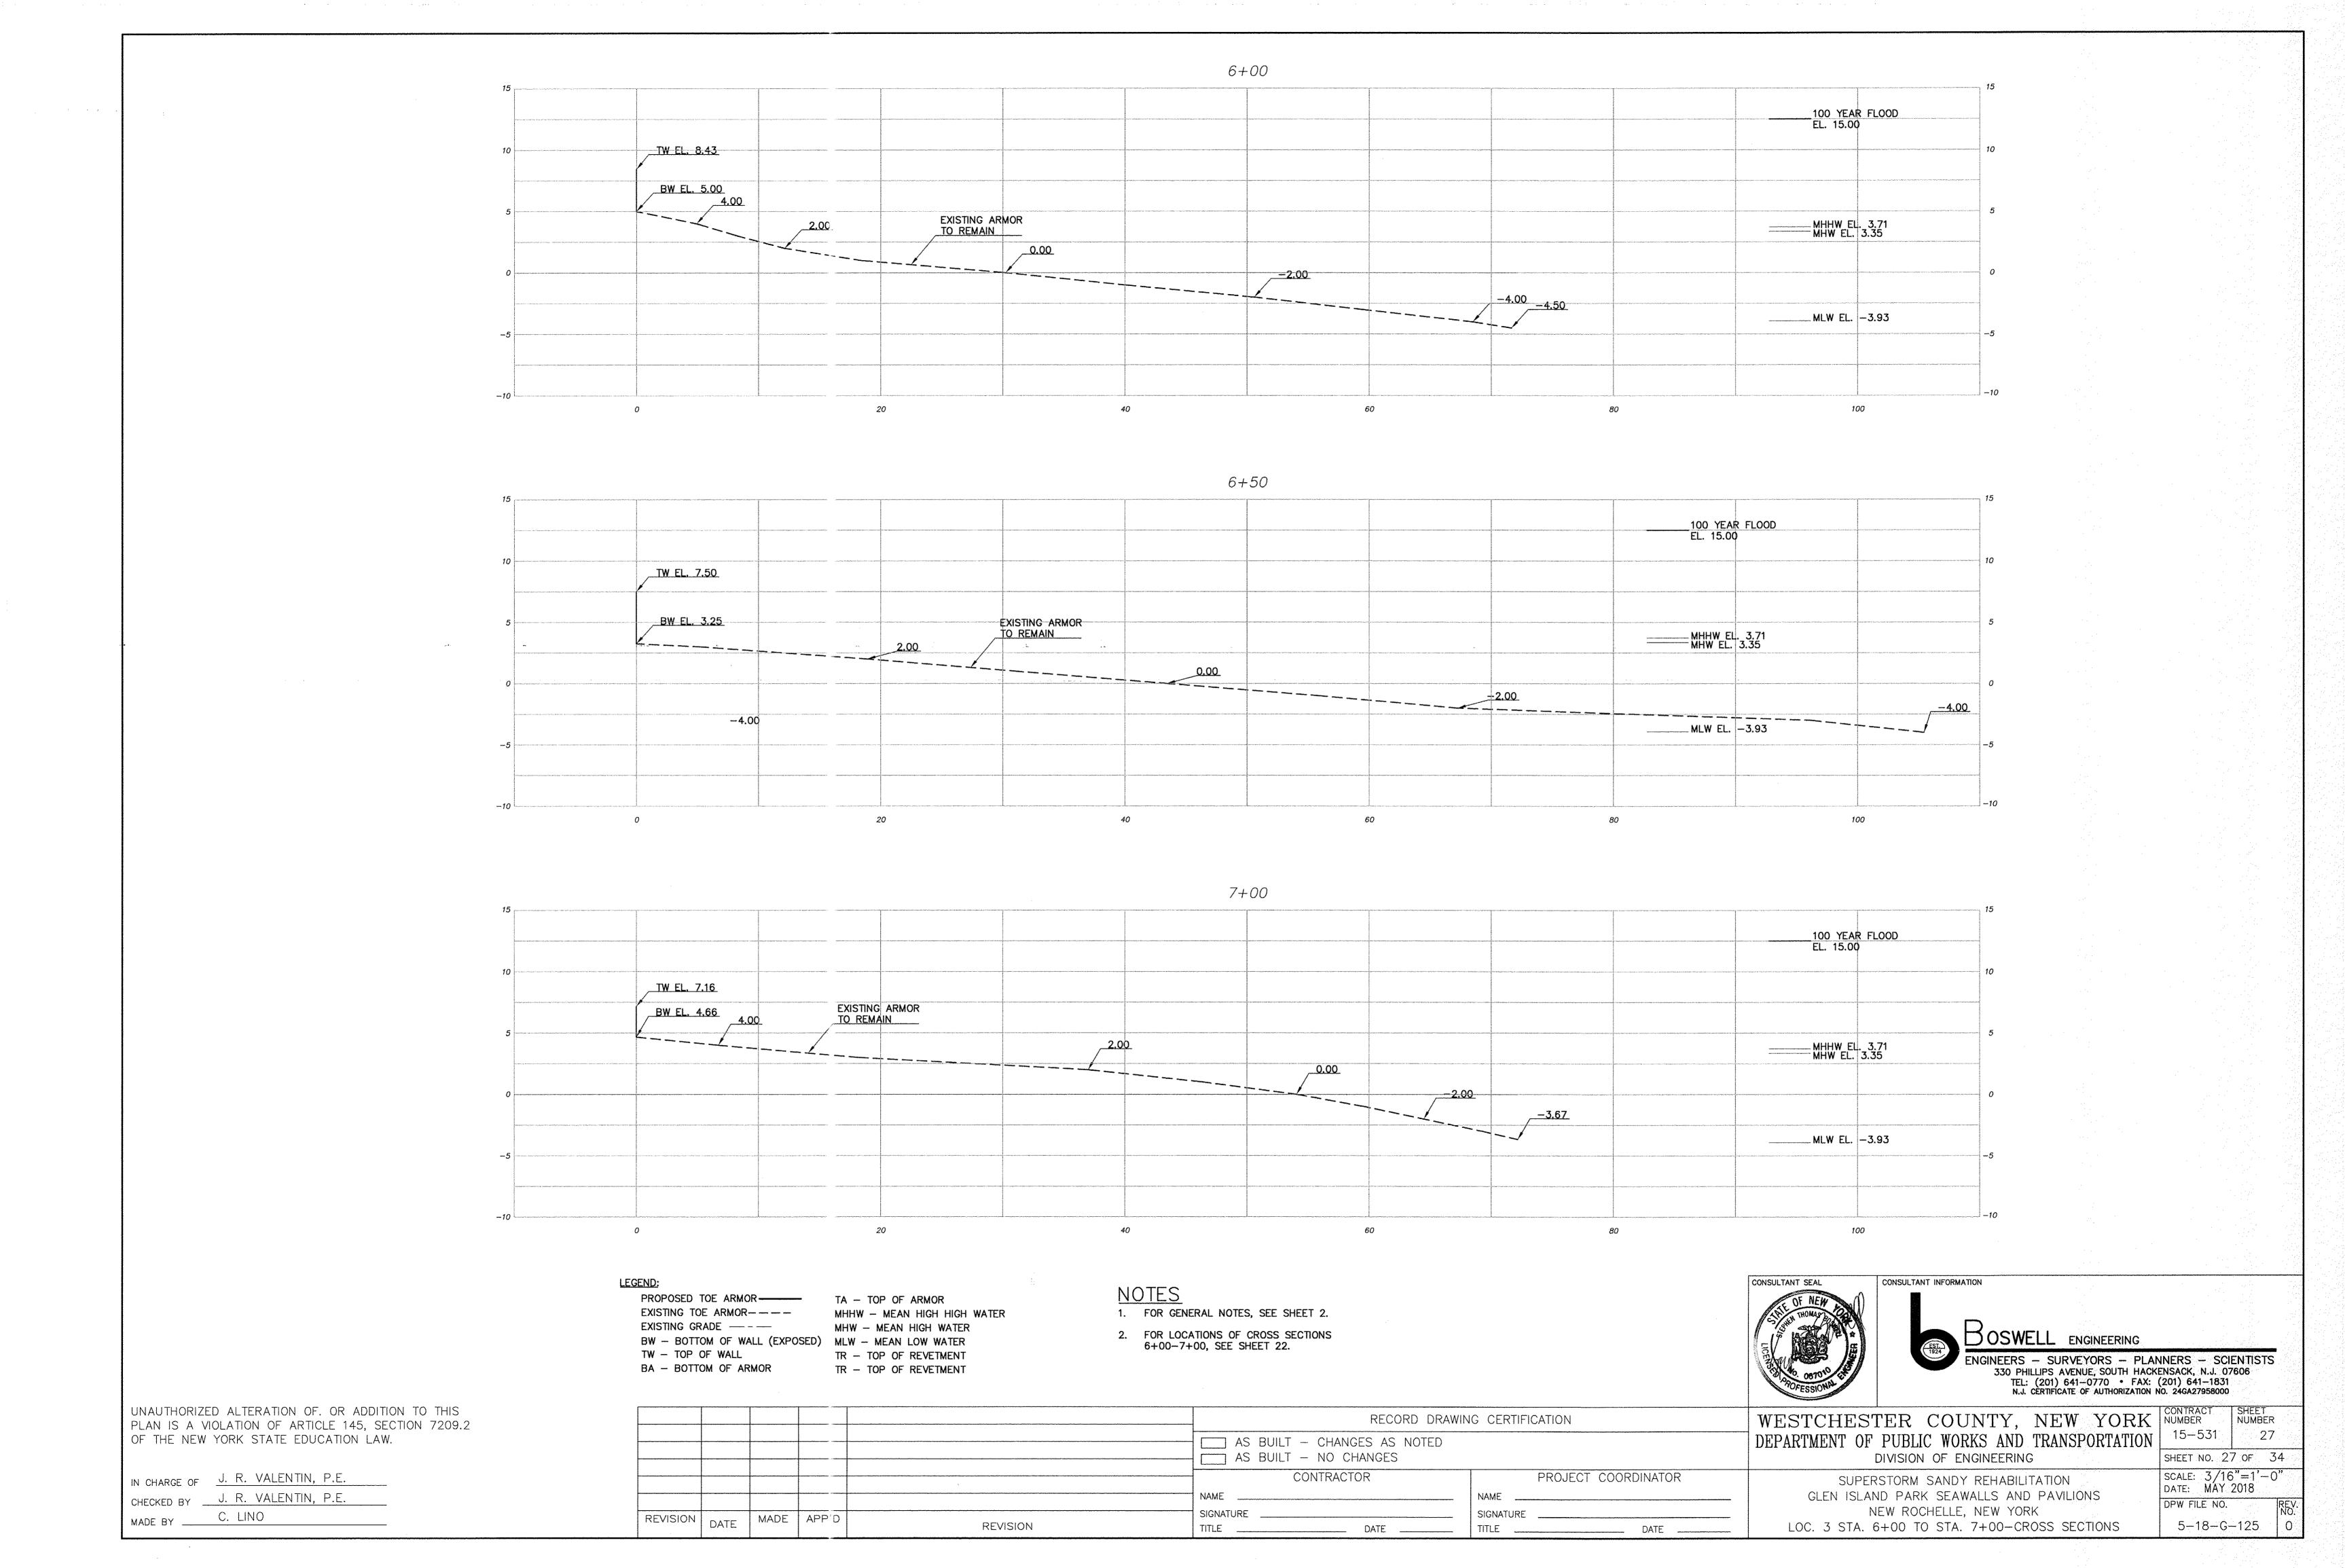

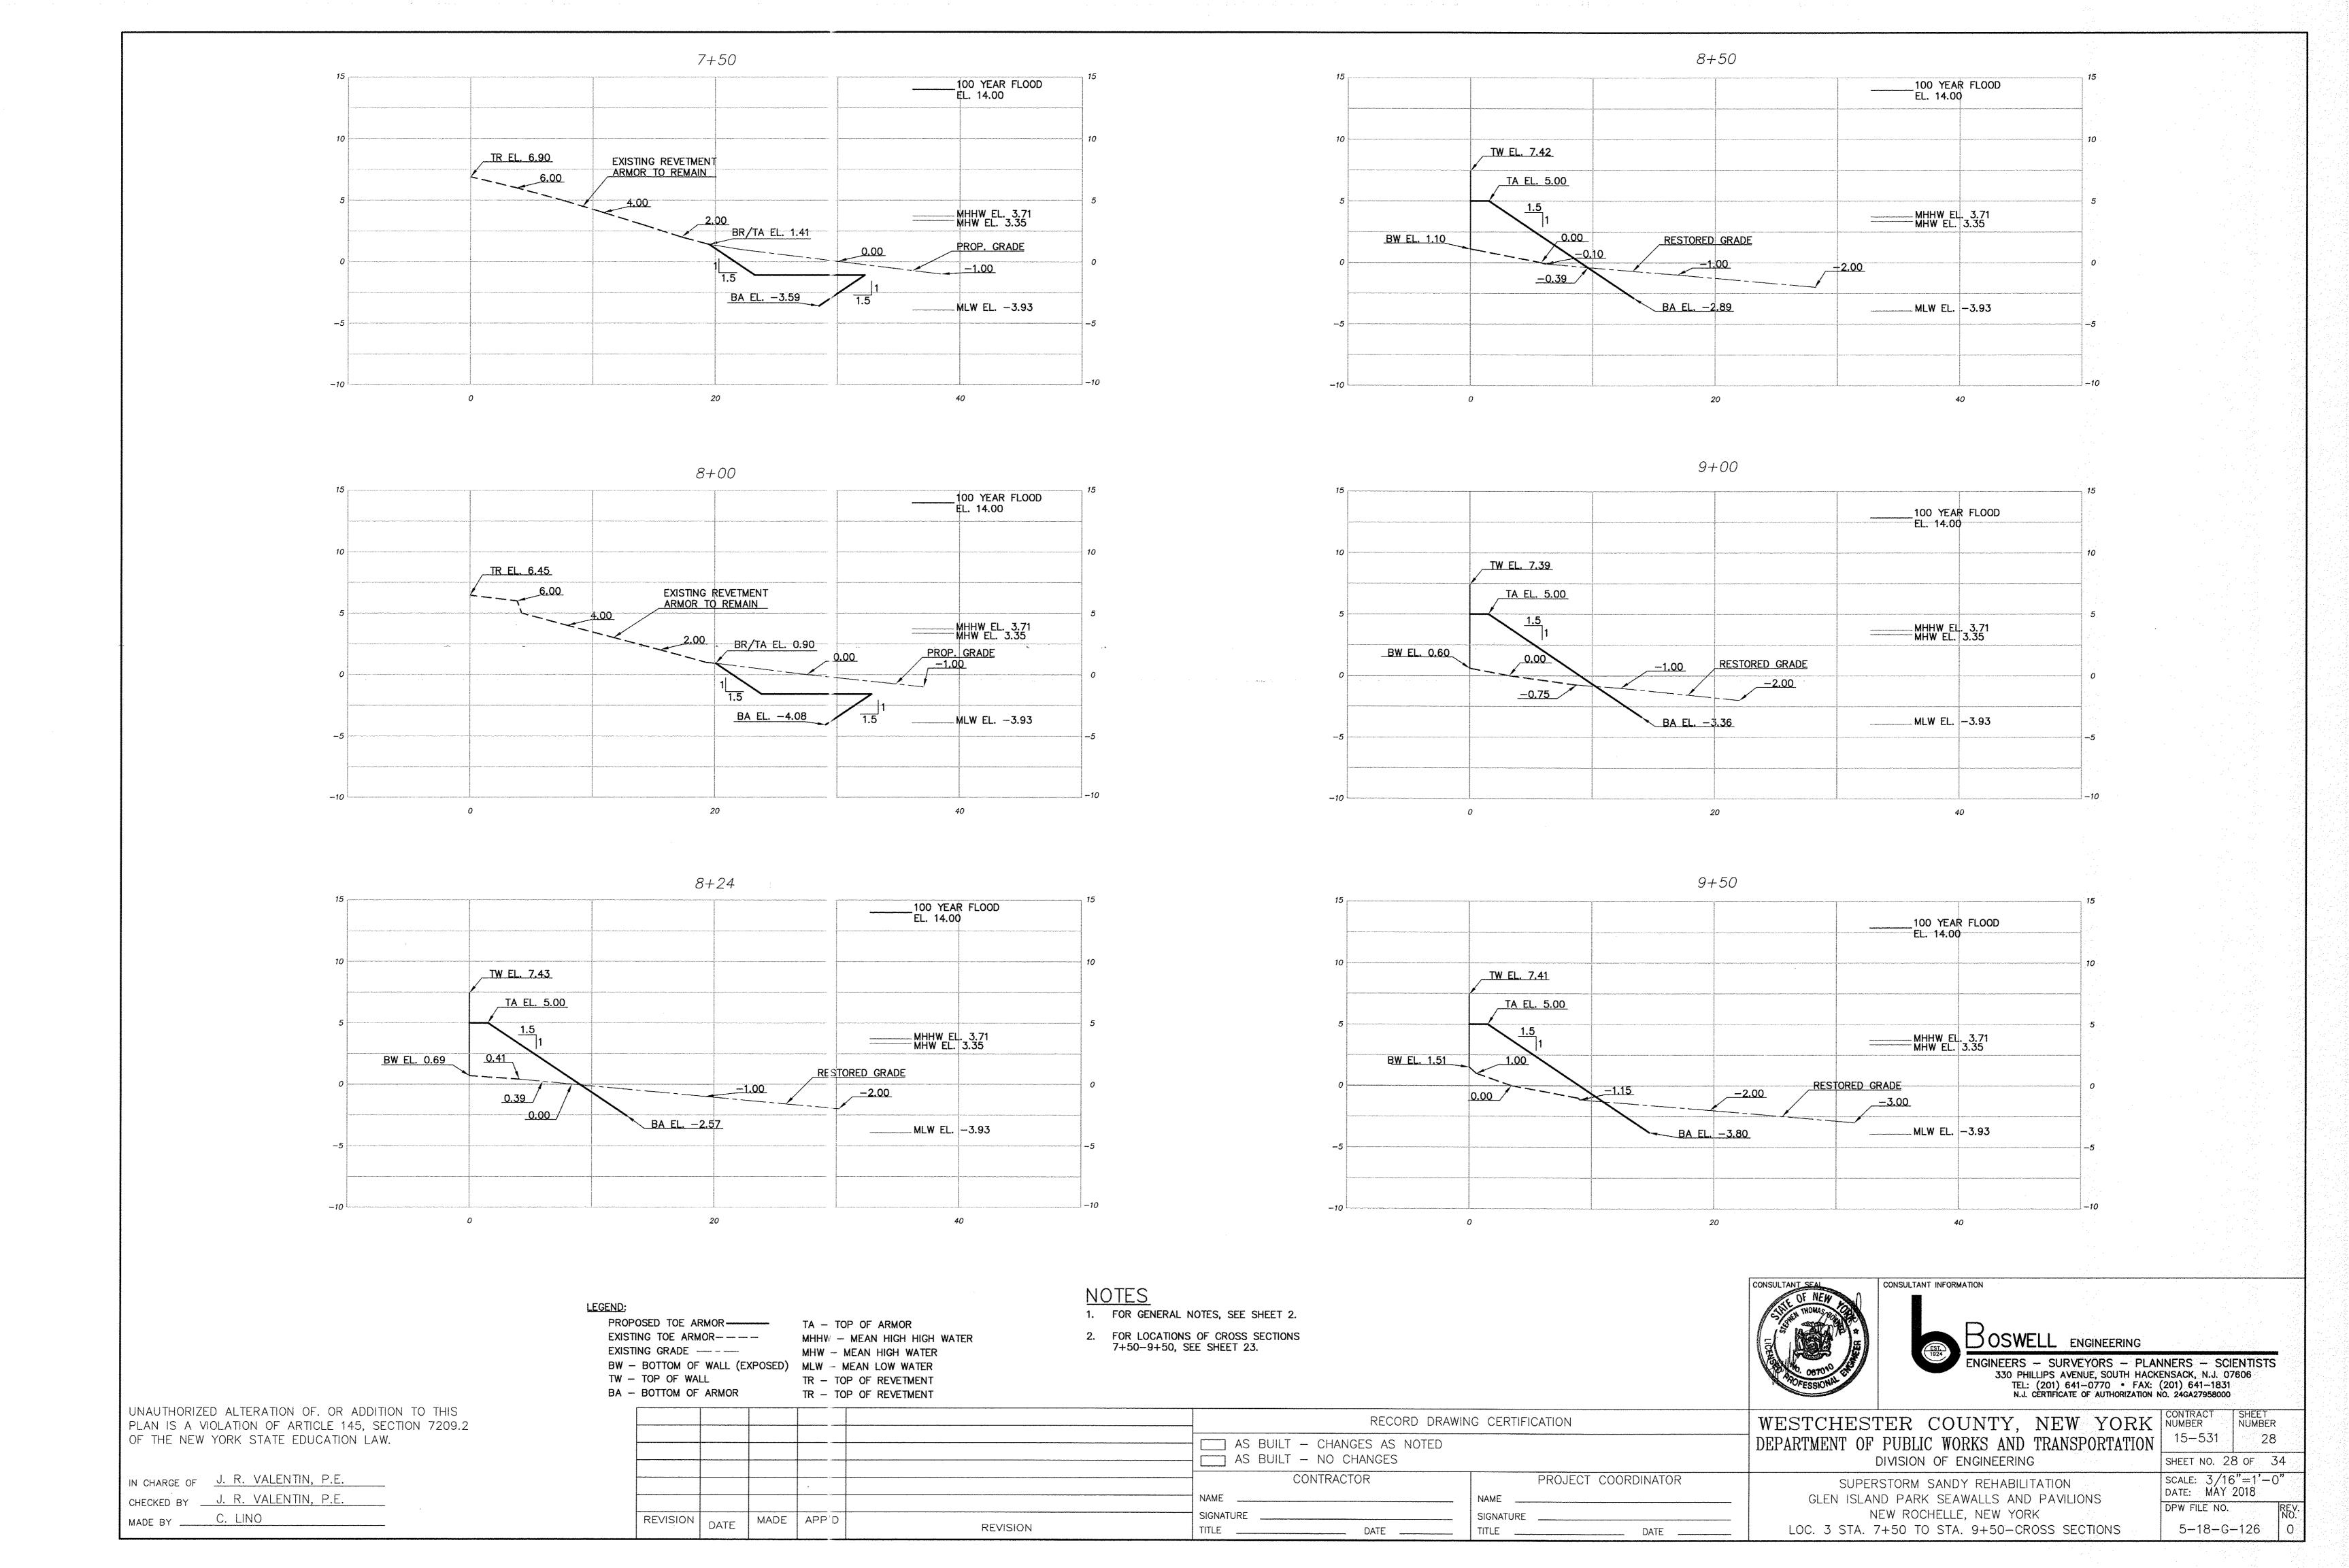

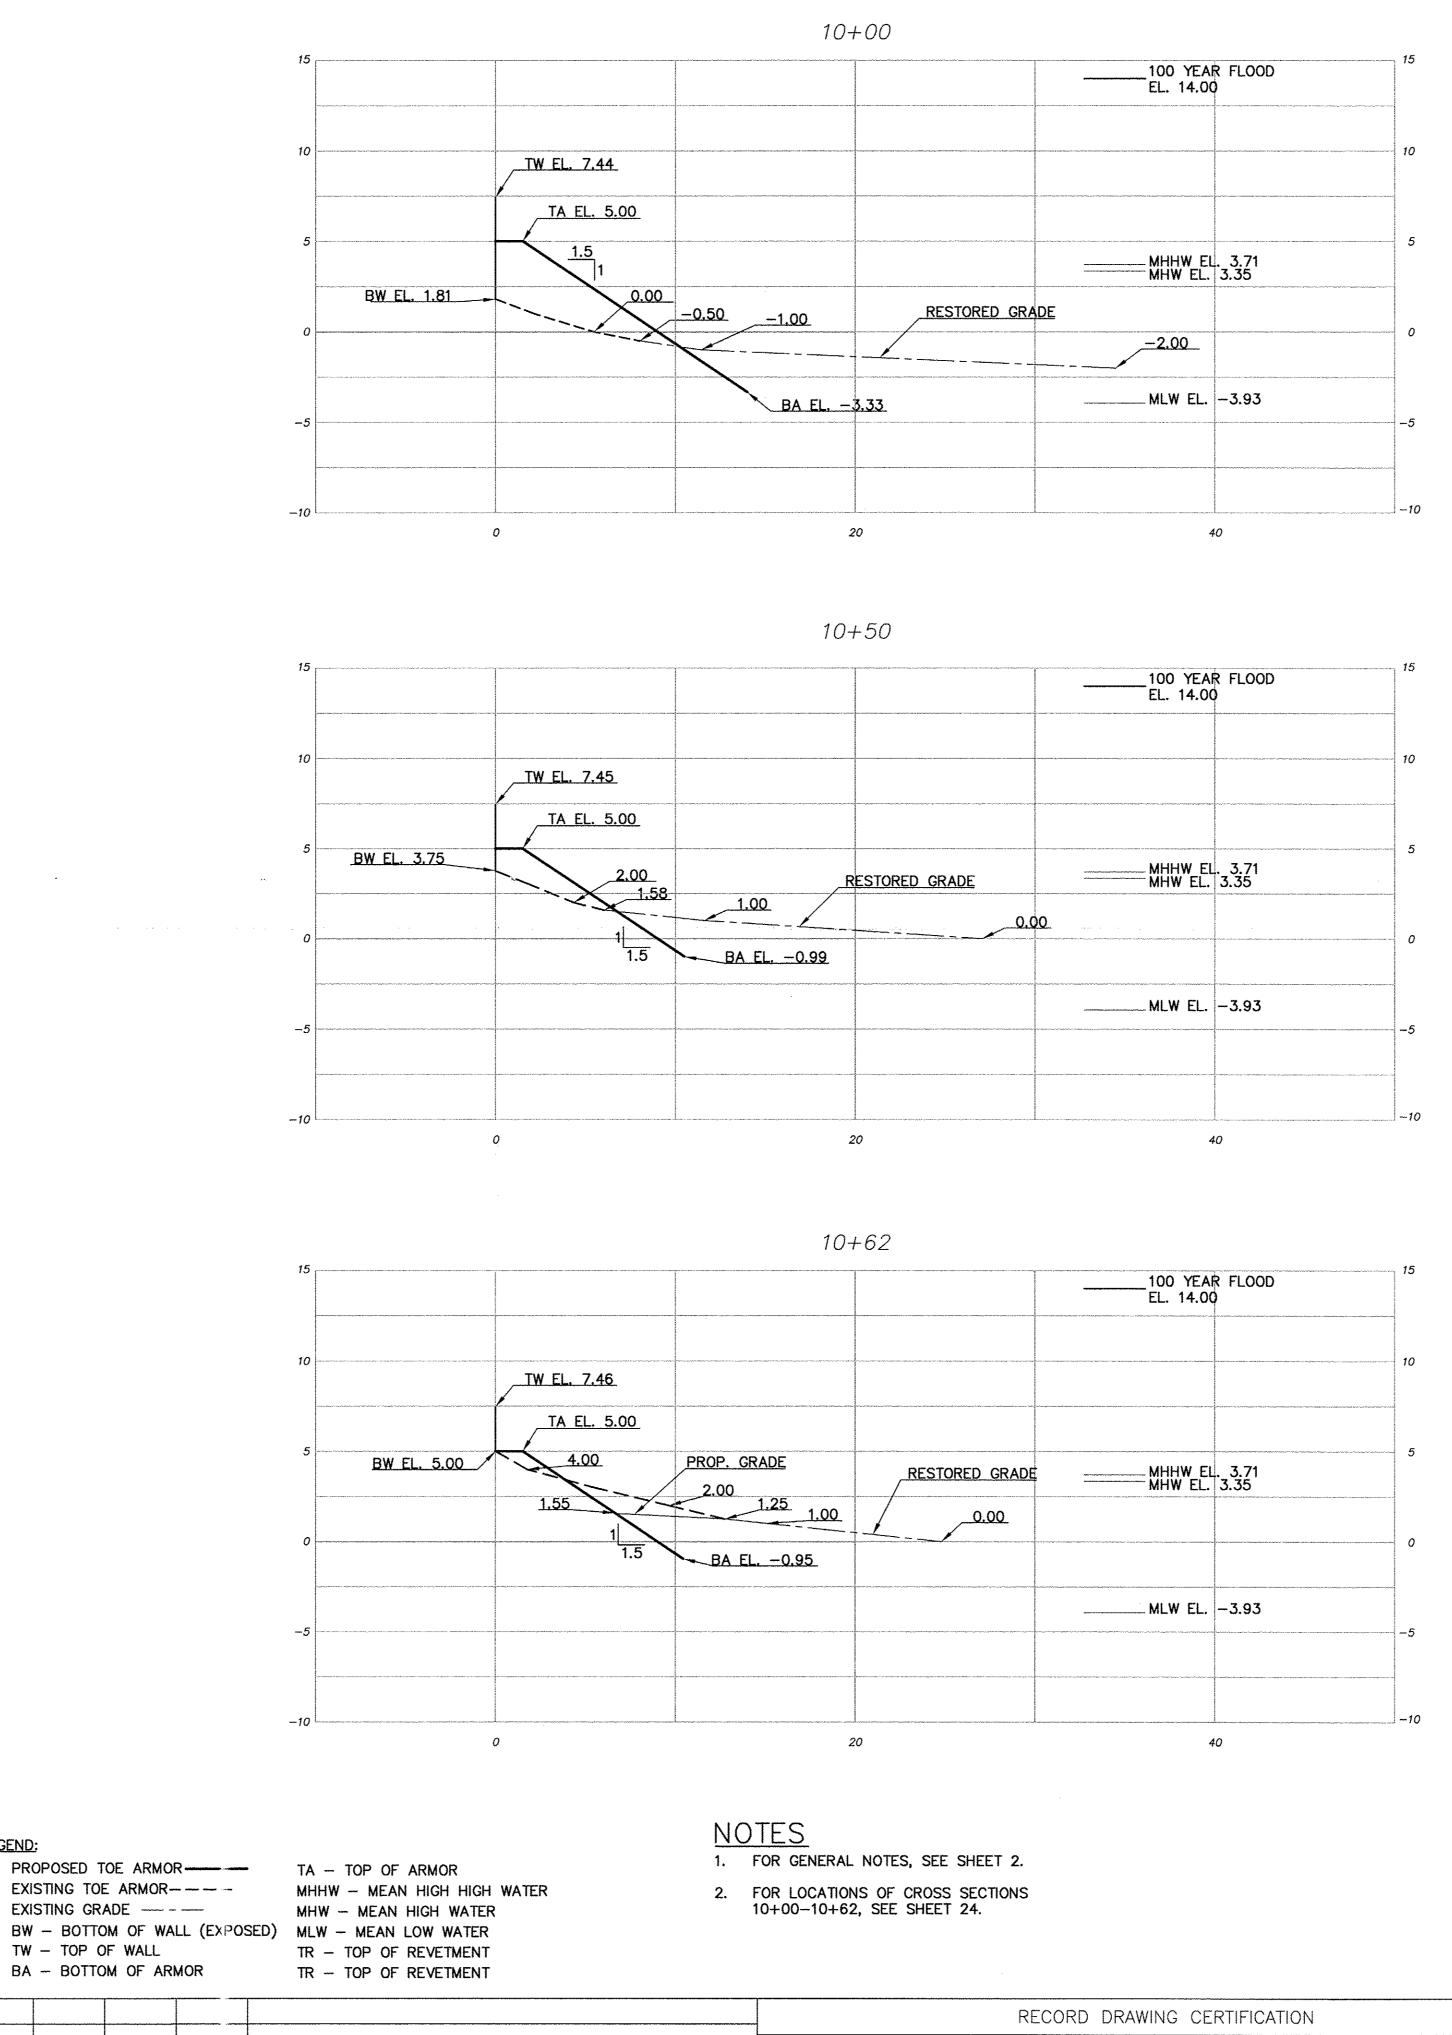

UNAUTHORIZED ALTERATION OF. OR ADDITION TO THIS PLAN IS A VIOLATION OF ARTICLE 145, SECTION 7209.2 OF THE NEW YORK STATE EDUCATION LAW.

LEGEND;

TW - TOP OF WALL

IN CHARGE OF J. R. VALENTIN, P.E. CHECKED BY J. R. VALENTIN, P.E. MADE BY _____ C. LINO

Boswell engineering

ENGINEERS — SURVEYORS — PLANNERS — SCIENTISTS

330 PHILLIPS AVENUE, SOUTH HACKENSACK, N.J. 07606

TEL: (201) 641—0770 • FAX: (201) 641—1831

N.J. CERTIFICATE OF AUTHORIZATION NO. 24GA27958000

WESTCHESTER COUNTY, NEW YORK CONTRACT NUMBER DEPARTMENT OF PUBLIC WORKS AND TRANSPORTATION DIVISION OF ENGINEERING

SHEET NO. 29 OF 34 SCALE: 3/16"=1'-0" SUPERSTORM SANDY REHABILITATION DATE: MAY 2018 GLEN ISLAND PARK SEAWALLS AND PAVILIONS DPW FILE NO. NEW ROCHELLE, NEW YORK


SHEET NUMBER

29

15-531

5-18-G-127

AS BUILT - CHANGES AS NOTED ____ AS BUILT - NO CHANGES CONTRACTOR PROJECT COORDINATOR REVISION DATE MADE APP'D LOC. 3 STA. 10+00 TO STA. 10+62-CROSS SECTIONS REVISION ___ DATE ___

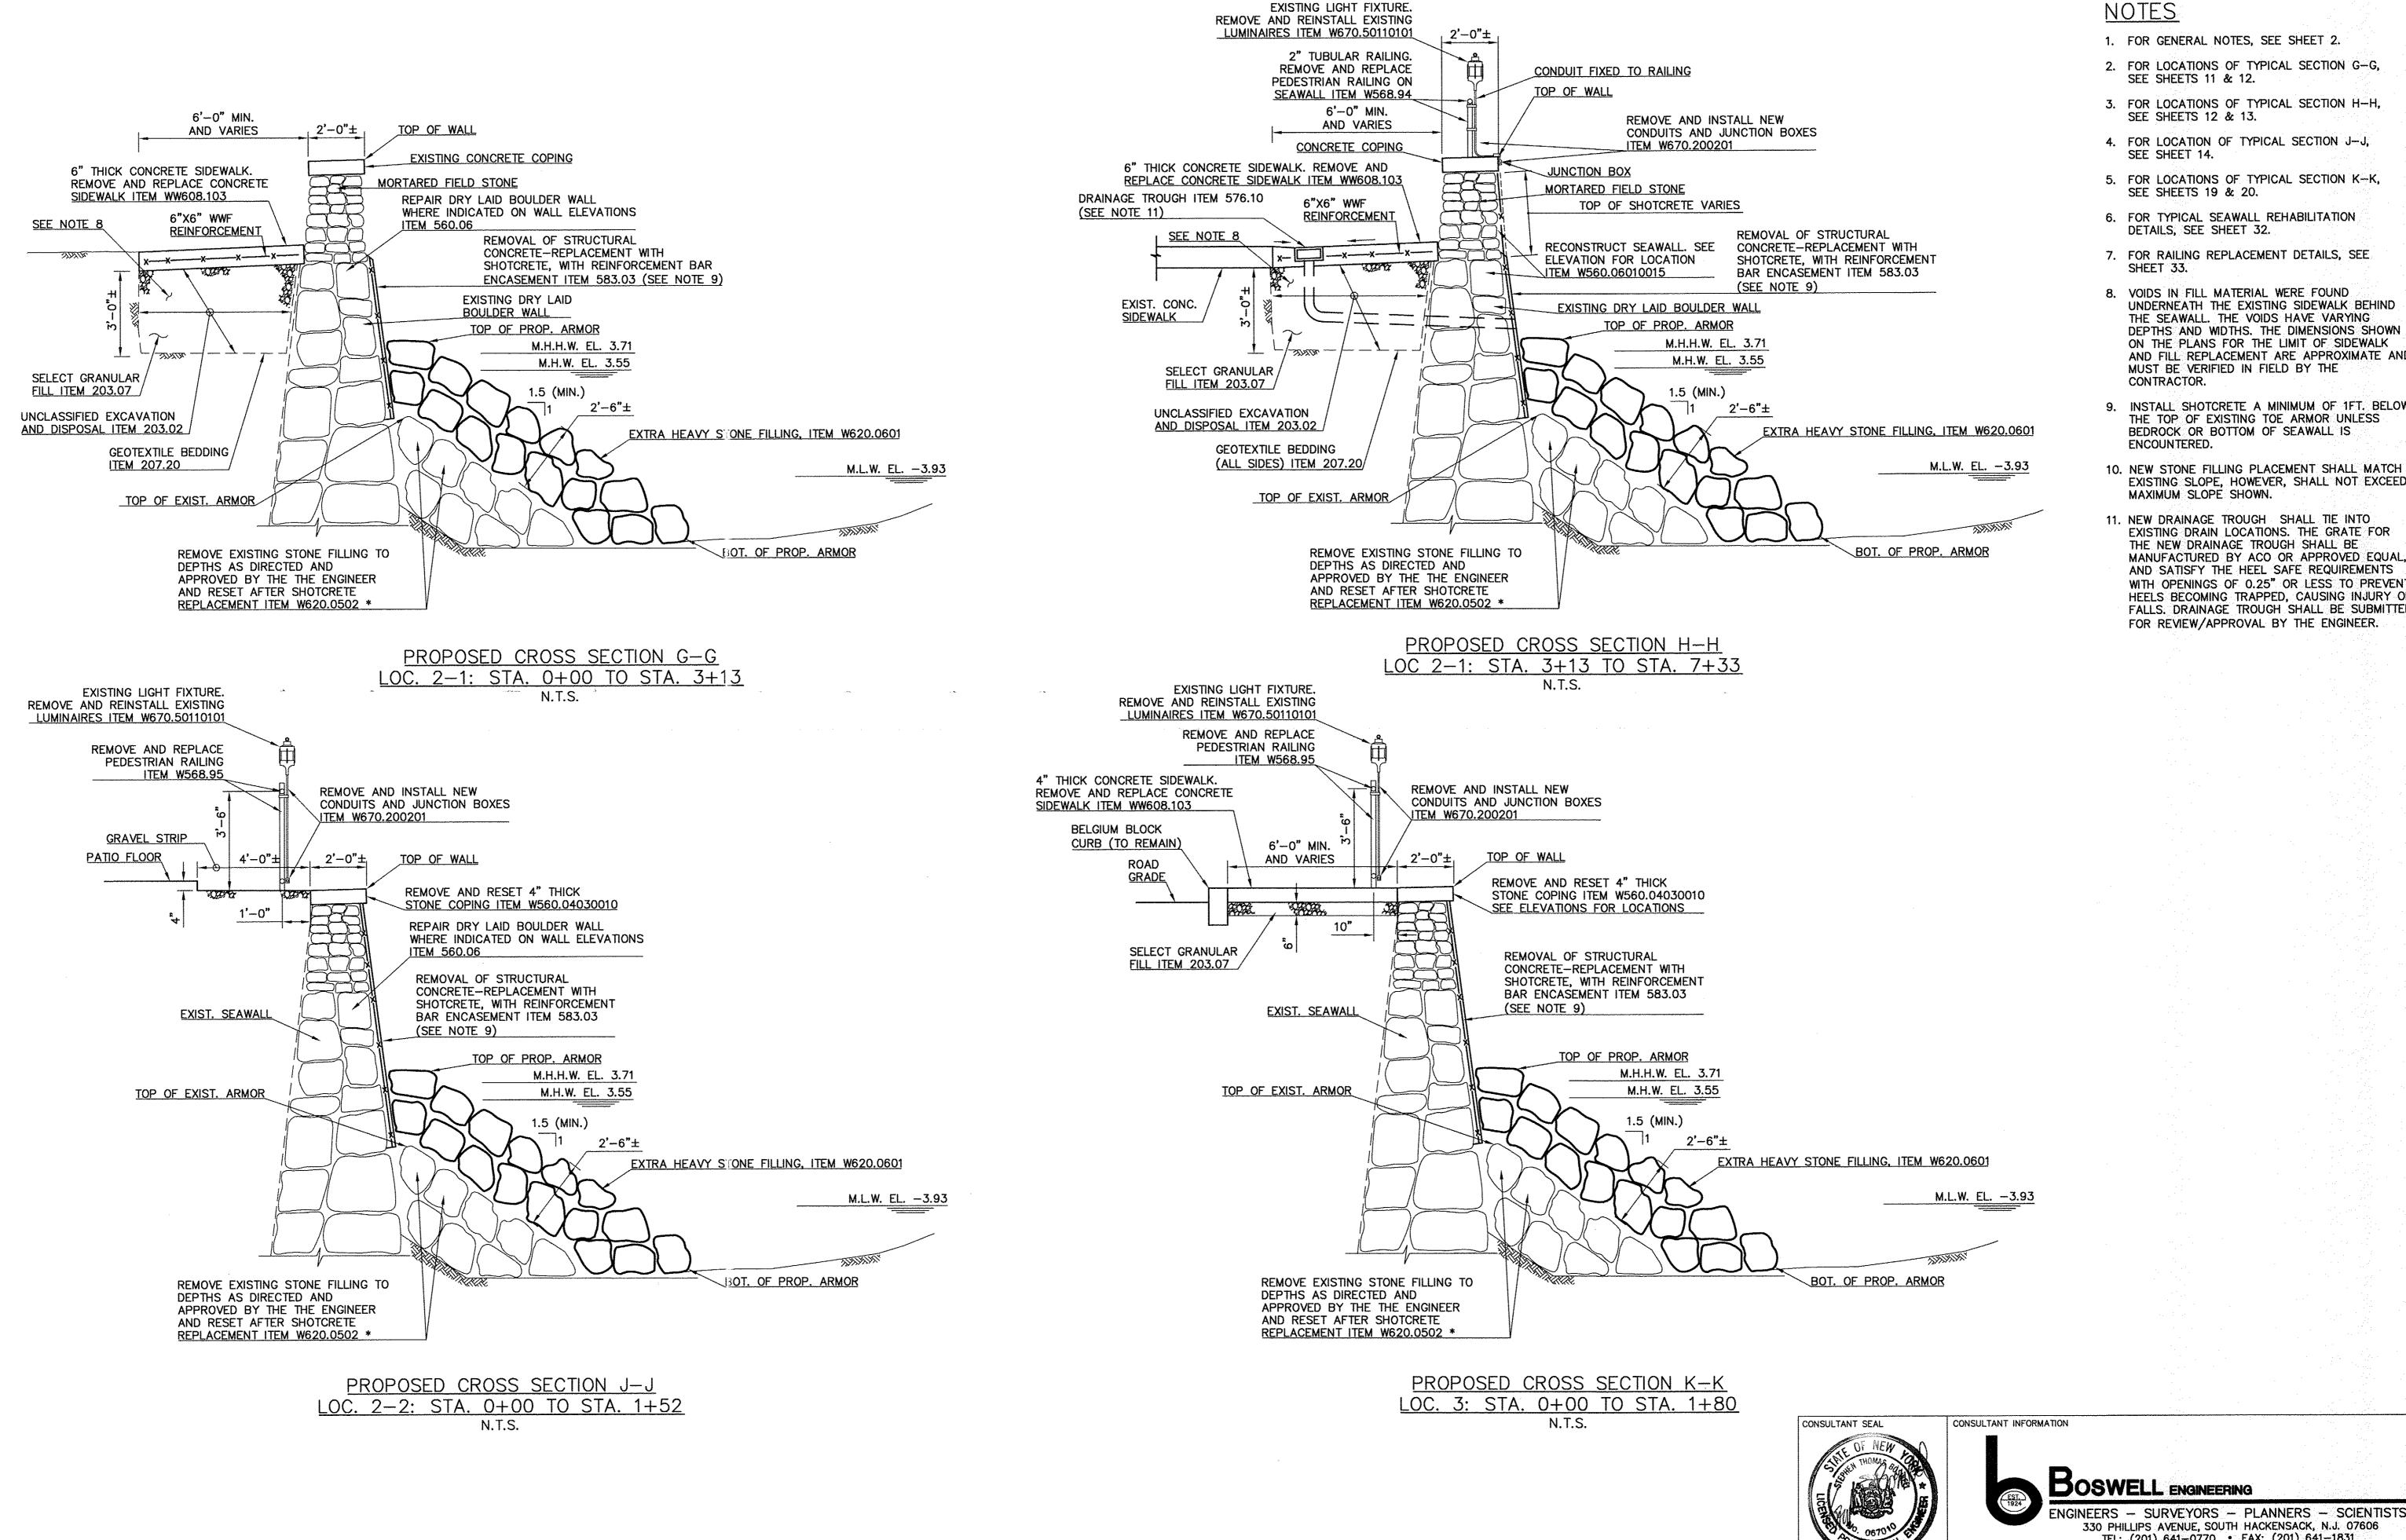

UNAUTHORIZED ALTERATION OF. OR ADDITION TO THIS

OF THE NEW YORK STATE EDUCATION LAW.

C. LINO

MADE BY

J. R. VALENTIN, P.E.

J. R. VALENTIN, P.E.

PLAN IS A VIOLATION OF ARTICLE 145, SECTION 7209.2

330 PHILLIPS AVENUE, SOUTH HACKENSACK, N.J. 07606
TEL: (201) 641-0770 • FAX: (201) 641-1831
N.J. CERTIFICATE OF AUTHORIZATION NO. 24GA27958000 WESTCHESTER COUNTY, NEW YORK CONTRACT NUMBER RECORD DRAWING CERTIFICATION DEPARTMENT OF PUBLIC WORKS AND TRANSPORTATION AS BUILT - CHANGES AS NOTED SHEET NO. 30 OF 34 AS BUILT - NO CHANGES DIVISION OF ENGINEERING SCALE: AS NOTED CONTRACTOR PROJECT COORDINATOR SUPERSTORM SANDY REHABILITATION DATE: MAY 2018 GLEN ISLAND PARK SEAWALLS AND PAVILIONS DPW FILE NO. NEW ROCHELLE, NEW YORK **SIGNATURE** REVISION MADE APP'D 5-18-G-128 DATE TYPICAL SEAWALL SECTIONS A-A TO D-D **REVISION** DATE

NOTES

1. FOR GENERAL NOTES, SEE SHEET 2.

SEE SHEETS 11 & 12.

SEE SHEETS 12 & 13.

SEE SHEETS 19 & 20.

DETAILS, SEE SHEET 32.

SEE SHEET 14.

SHEET 33.

CONTRACTOR.

ENCOUNTERED.

MAXIMUM SLOPE SHOWN.

2. FOR LOCATIONS OF TYPICAL SECTION G-G,

3. FOR LOCATIONS OF TYPICAL SECTION H-H,

4. FOR LOCATION OF TYPICAL SECTION J-J.

5. FOR LOCATIONS OF TYPICAL SECTION K-K,

6. FOR TYPICAL SEAWALL REHABILITATION

7. FOR RAILING REPLACEMENT DETAILS, SEE

UNDERNEATH THE EXISTING SIDEWALK BEHIND

DEPTHS AND WIDTHS. THE DIMENSIONS SHOWN ON THE PLANS FOR THE LIMIT OF SIDEWALK

9. INSTALL SHOTCRETE A MINIMUM OF 1FT. BELOW

THE TOP OF EXISTING TOE ARMOR UNLESS

10. NEW STONE FILLING PLACEMENT SHALL MATCH

EXISTING DRAIN LOCATIONS. THE GRATE FOR THE NEW DRAINAGE TROUGH SHALL BE

MANUFACTURED BY ACO OR APPROVED EQUAL,

WITH OPENINGS OF 0.25" OR LESS TO PREVENT

HEELS BECOMING TRAPPED, CAUSING INJURY OF

FALLS. DRAINAGE TROUGH SHALL BE SUBMITTED

FOR REVIEW/APPROVAL BY THE ENGINEER.

AND SATISFY THE HEEL SAFE REQUIREMENTS

EXISTING SLOPE, HOWEVER, SHALL NOT EXCEED

BEDROCK OR BOTTOM OF SEAWALL IS

11. NEW DRAINAGE TROUGH SHALL TIE INTO

AND FILL REPLACEMENT ARE APPROXIMATE AND


THE SEAWALL. THE VOIDS HAVE VARYING

8. VOIDS IN FILL MATERIAL WERE FOUND


MUST BE VERIFIED IN FIELD BY THE

REMOVE VEGETATION & TREE STUMPS ITEM 201.06 SEE WALL ELEVATIONS FOR LOCATIONS TOP OF WALL EXISTING TOP OF REPLACE STONE COPING, ITEMS 560.05 & WALL GRADE 560.06. SEE ELEVATION SHTS. FOR LOCATIONS RECONSTRUCT WALL ITEM W560.06010015 AND REPAIR VOIDS IN WALL ITEM 560.06 WHERE INDICATED ON WALL ELEVATIONS EXISTING DRY LAID BOULDER WALL M.H.H.W. EL. 3.71 M.H.W. EL. 3.55 BOT. OF WALL EXIST. BOT. OF CHANNEL M.L.W. EL. -3.93


PROPOSED CROSS SECTION L-L LOCATION 3: STA. 1+80 TO STA. 4+73 & STA. 5+82 TO 7+08 N.T.S.

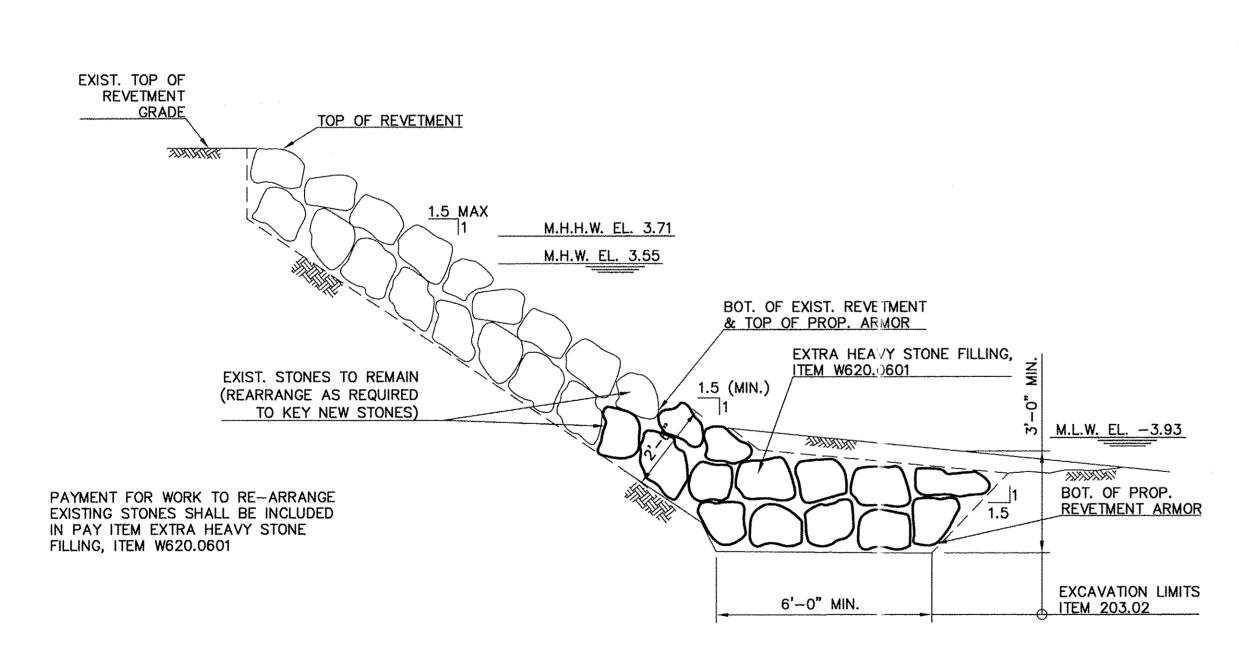


PROPOSED CROSS SECTION N-N LOCATION 3: STA. 7+08 TO 8+24 N.T.S.

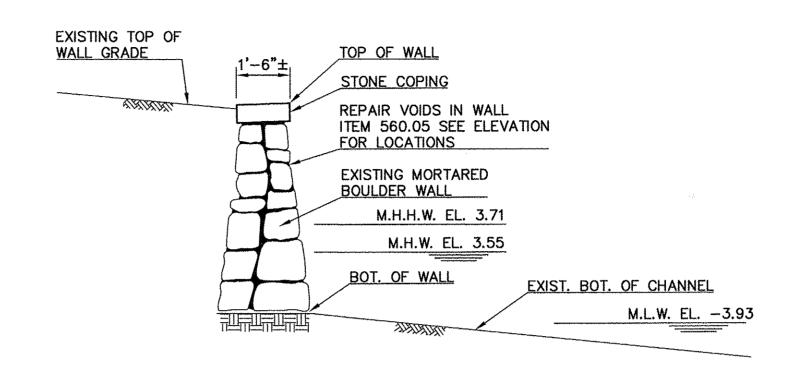

PROPOSED CROSS SECTION M-M LOCATION 3: STA. 4+73 TO 5+82 N.T.S.

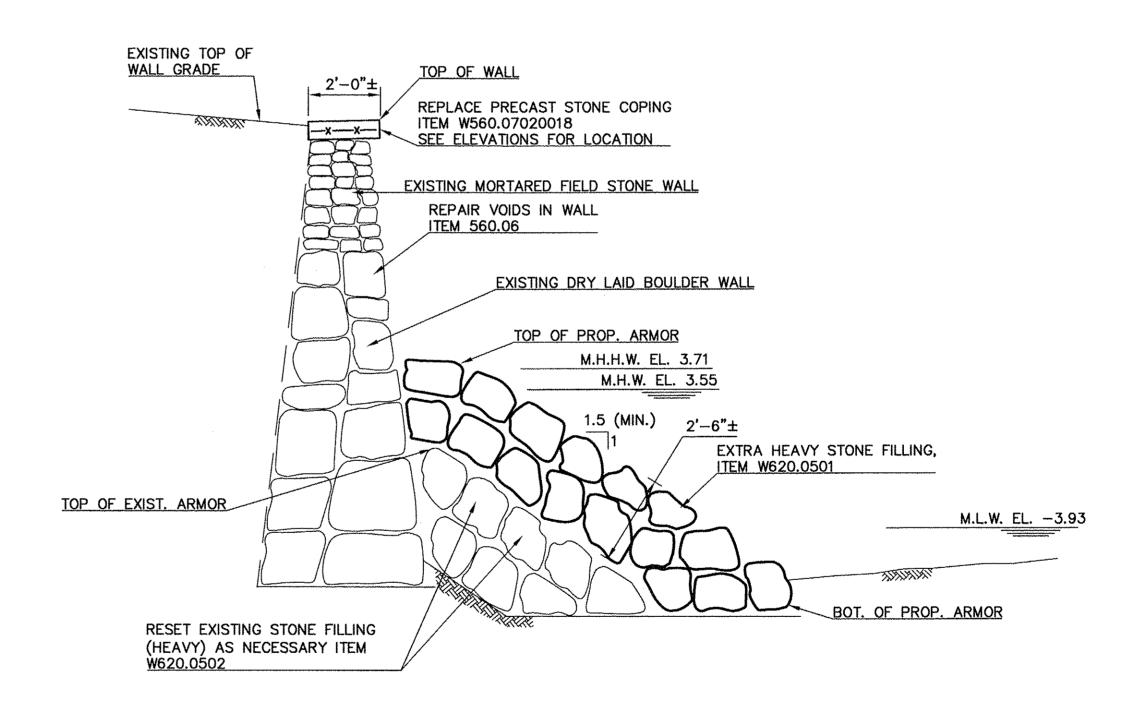

PROPOSED CROSS SECTION P-P LOCATION 3: STA. 8+24 TO 10+62 N.T.S.

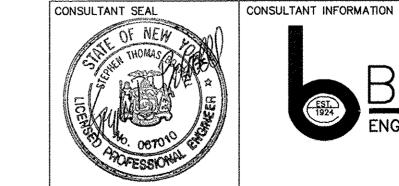

BOSWELL ENGINEERING

NOTES

1. FOR GENERAL NOTES, SEE SHEET 2.

SEE SHEETS 20, 21, & 22.

SEE SHEETS 21 & 22.

SEE SHEETS 22 & 23.

SEE SHEETS 23 & 24.

DETAILS, SEE SHEET 32.

2. FOR LOCATIONS OF TYPICAL SECTION L-L,

3. FOR LOCATIONS OF TYPICAL SECTION M-M,

4. FOR LOCATIONS OF TYPICAL SECTION N-N,

5. FOR LOCATIONS OF TYPICAL SECTION P-P,

6. FOR TYPICAL SEAWALL REHABILITATION

ENGINEERS — SURVEYORS — PLANNERS — SCIENTISTS
330 PHILLIPS AVENUE, SOUTH HACKENSACK, N.J. 07606
TEL: (201) 641—0770 • FAX: (201) 641—1831
N.J. CERTIFICATE OF AUTHORIZATION NO. 24GA27958000

WESTCHESTER COUNTY, NEW YORK
DEPARTMENT OF PUBLIC WORKS AND TRANSPORTATION
DIVISION OF ENGINEERING

CONTRACT NUMBER
15-531
SHEET NO.

10N 15-531 31

SHEET NO. 31 OF 34

SCALE: AS NOTED DATE: MAY 2018

5-18-G-129

DPW FILE NO.

SHEET NUMBER

SUPERSTORM SANDY REHABILITATION

GLEN ISLAND PARK SEAWALLS AND PAVILIONS

NEW ROCHELLE, NEW YORK


TYPICAL SEAWALL SECTIONS E-E TO H-H


UNAUTHORIZED ALTERATION OF. OR ADDITION TO THIS PLAN IS A VIOLATION OF ARTICLE 145, SECTION 7209.2 OF THE NEW YORK STATE EDUCATION LAW.


IN CHARGE OF J. R. VALENTIN, P.E.

CHECKED BY J. R. VALENTIN, P.E.


MADE BY C. LINO

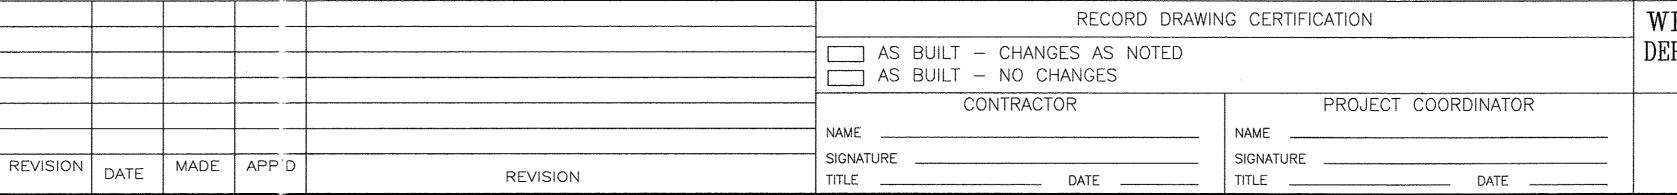

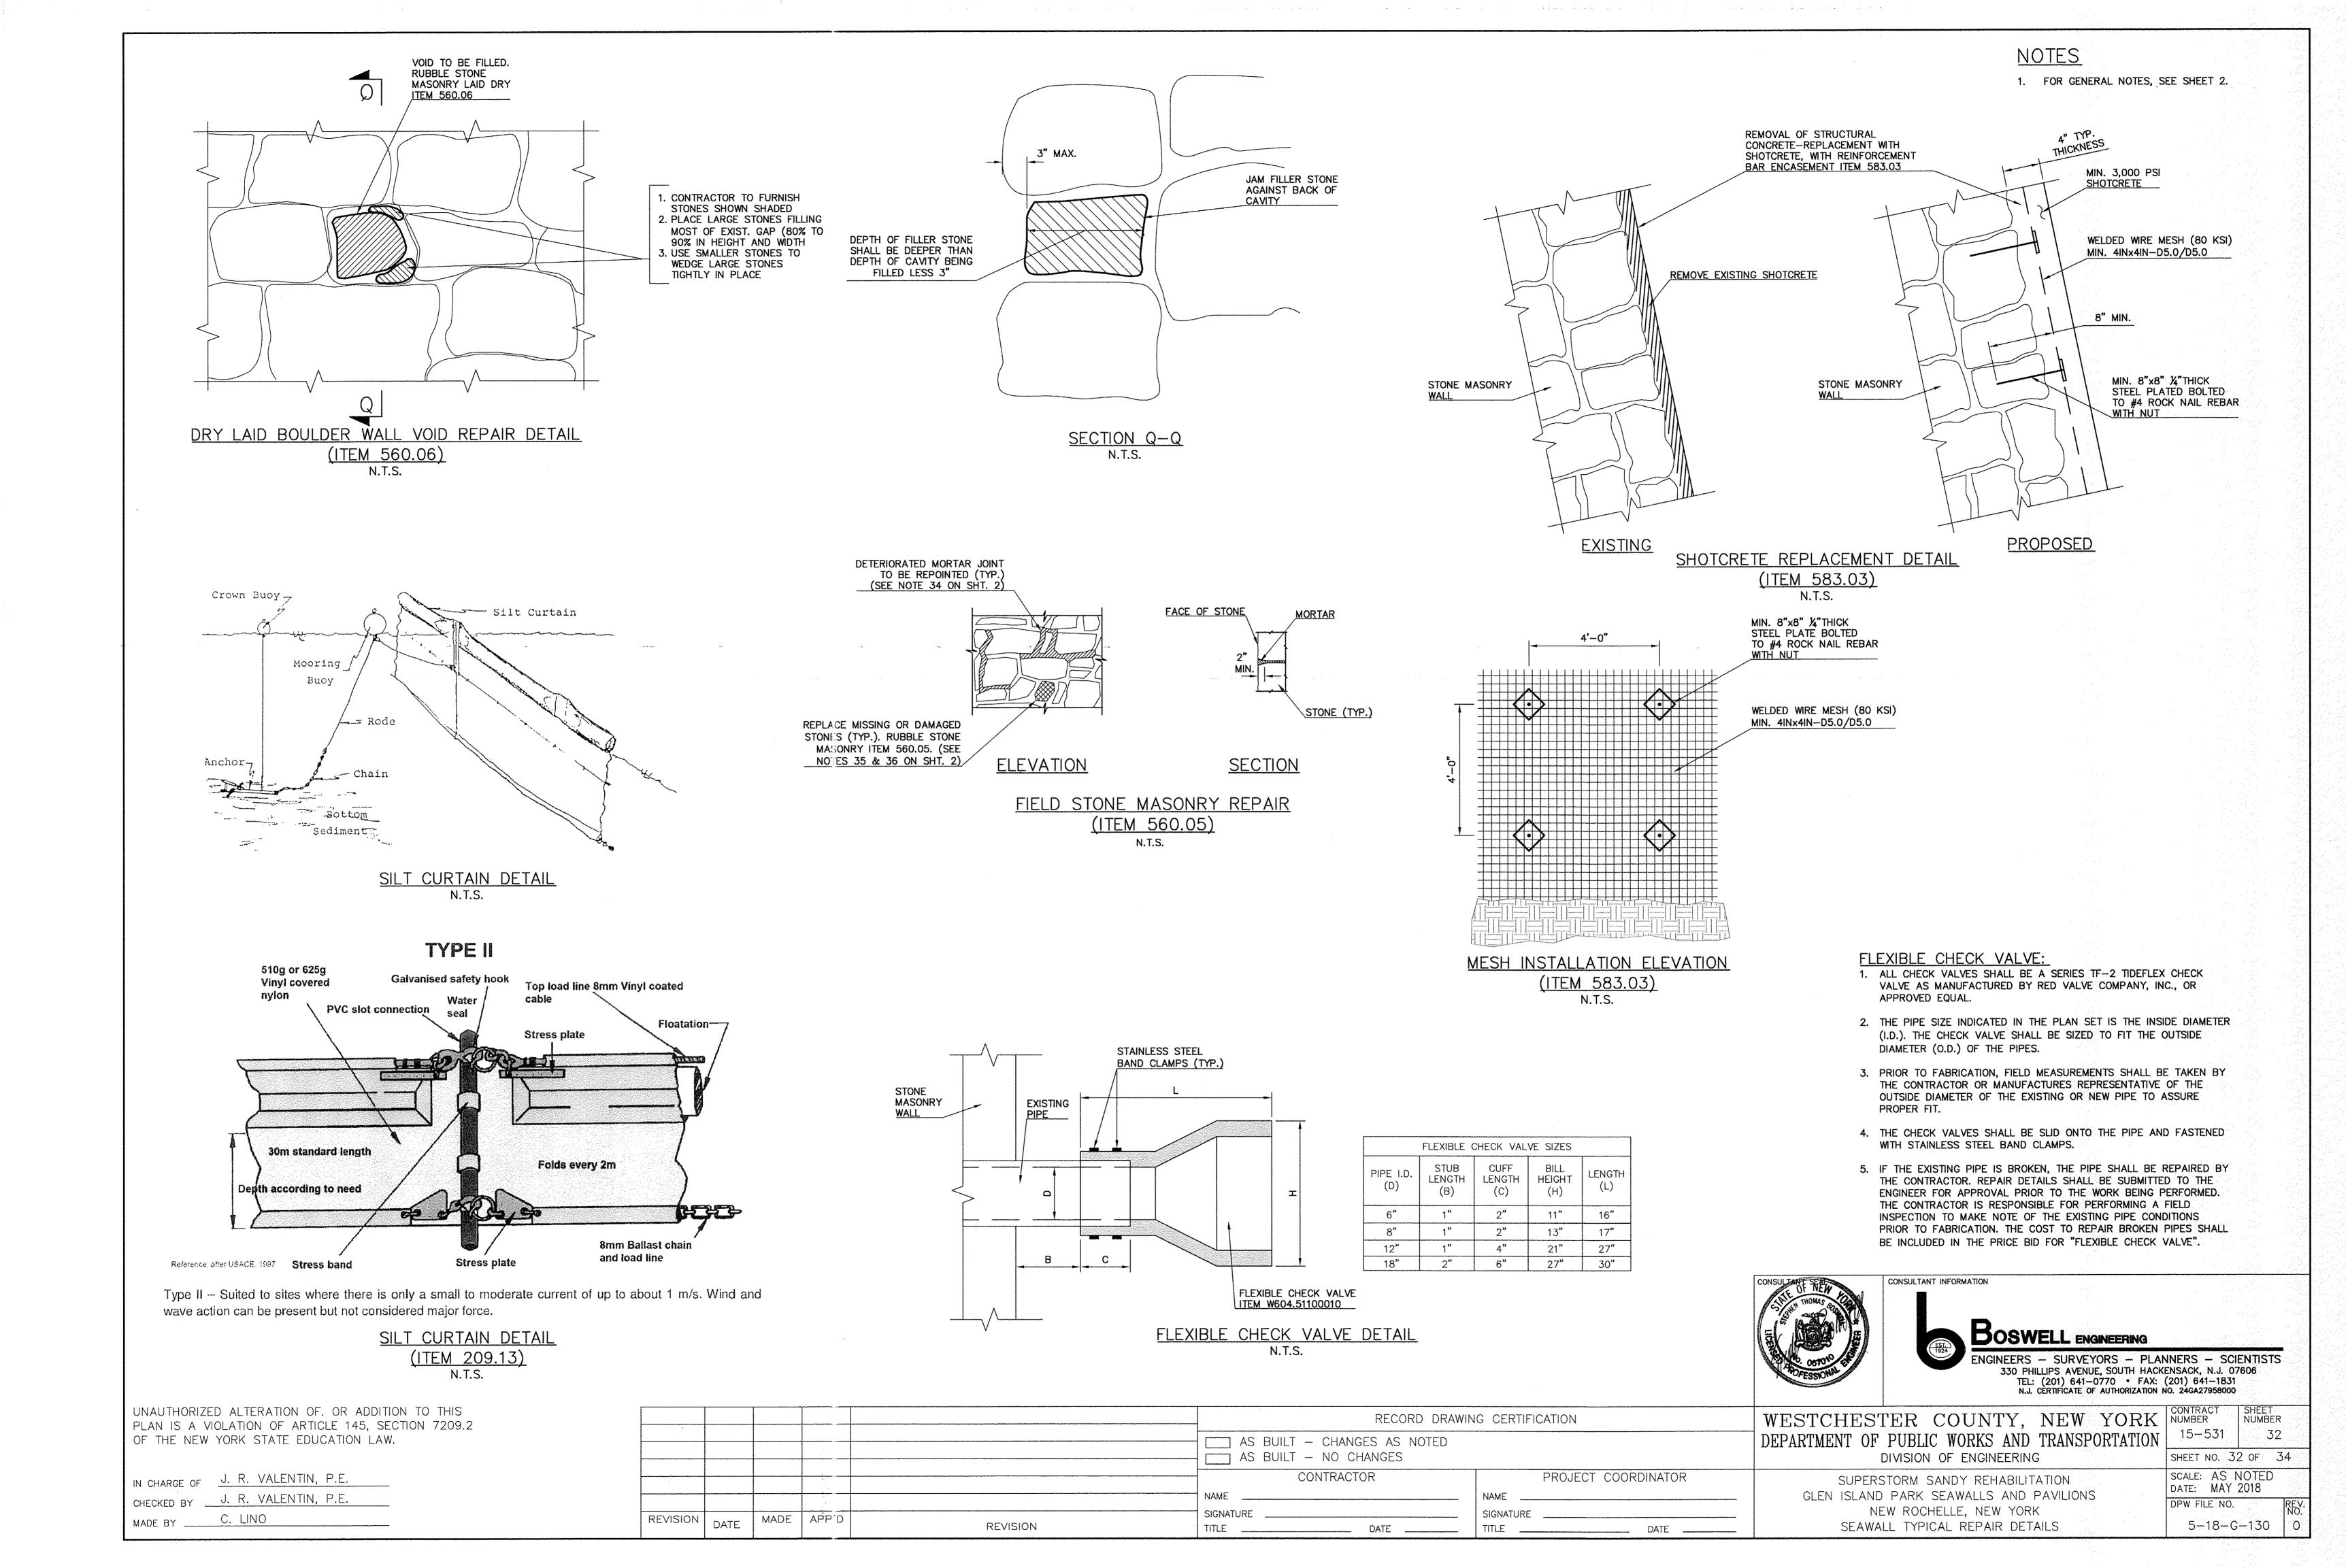


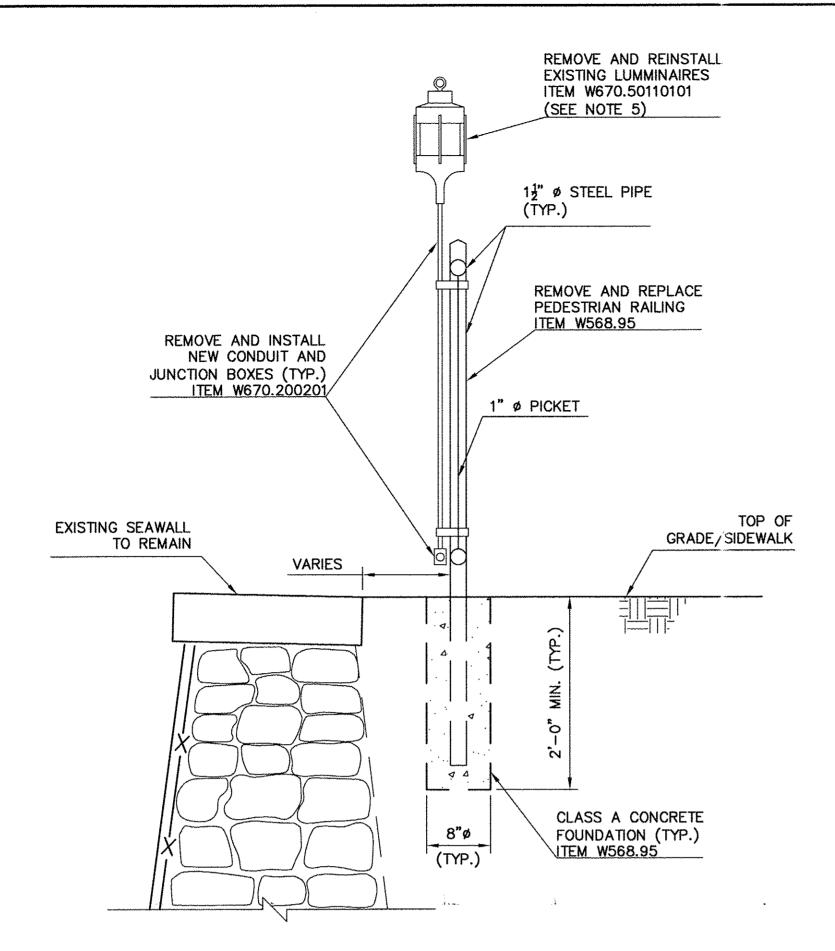


PROPOSED PEDESTRIAN RAILING BEHIND SEAWALL SECTION SCALE 1"=1'-0"

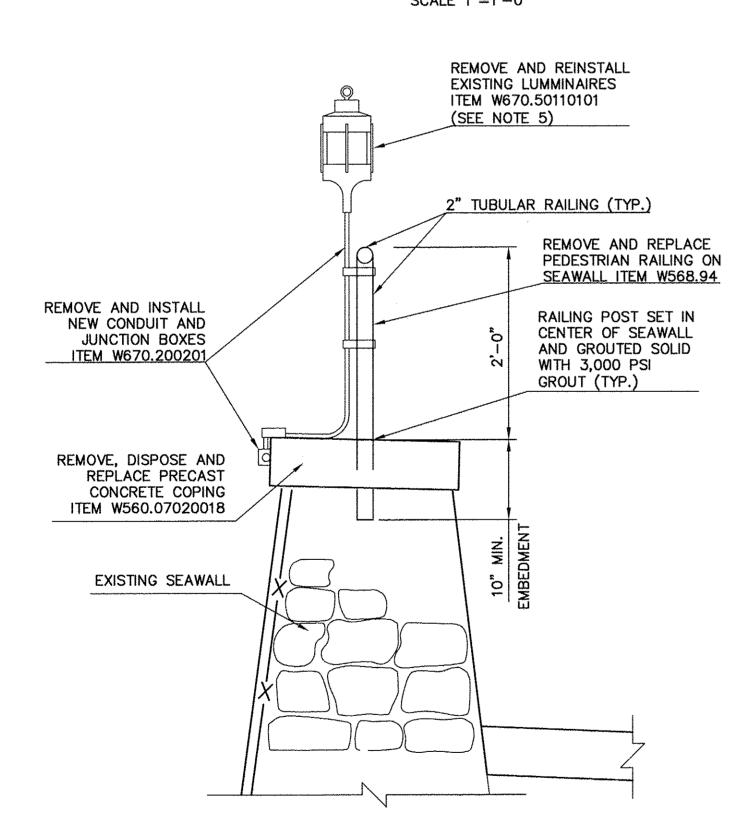

PROPOSED PEDESTRIAN RAILING ON SEAWALL

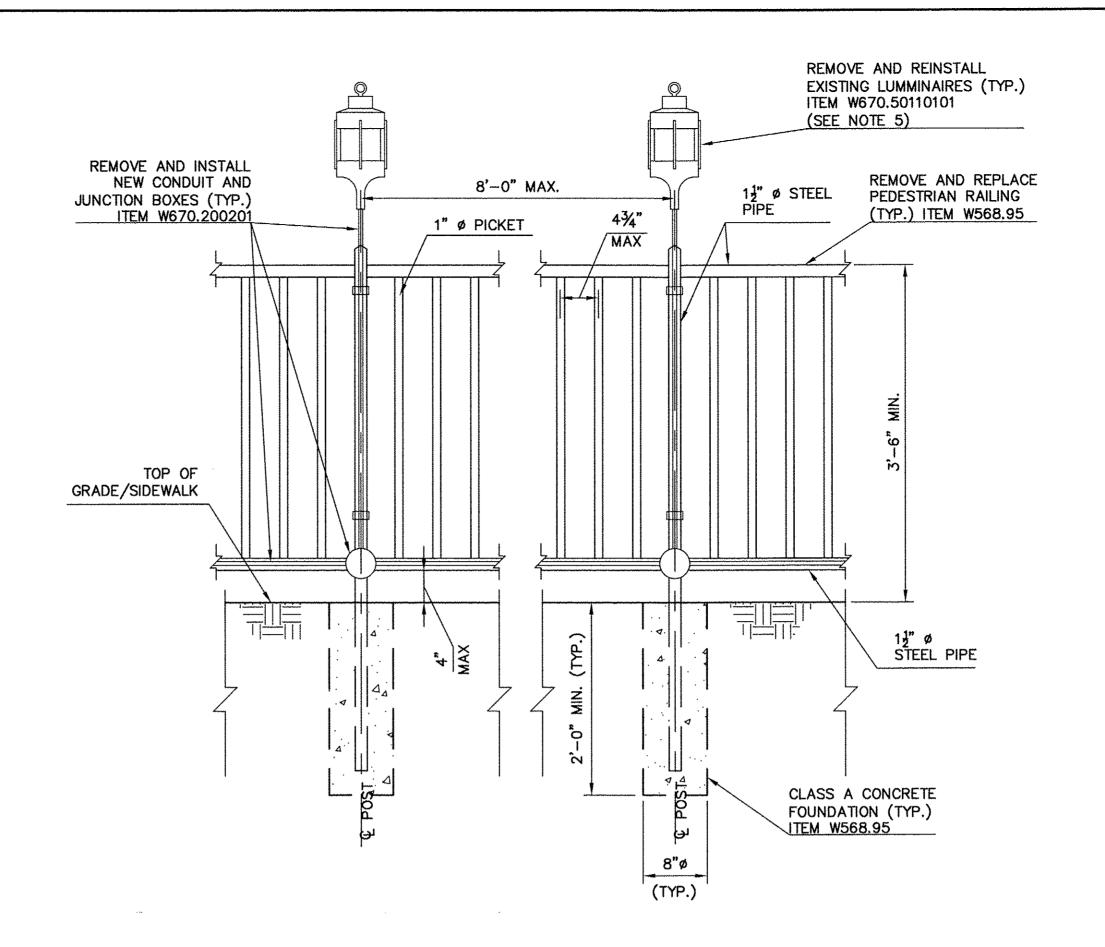

PROPOSED PEDESTRIAN RAILING BEHIND SEAWALL **ELEVATION**

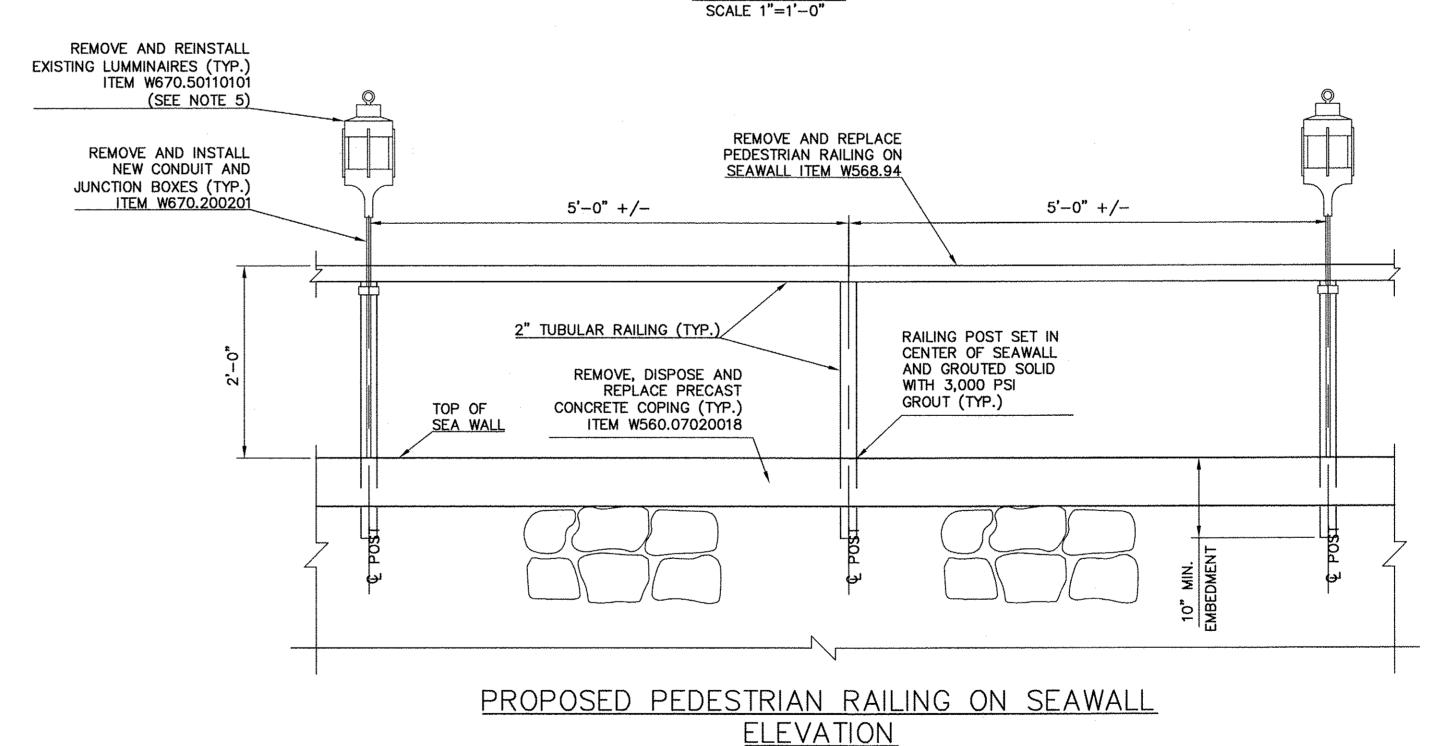

SCALE 1"=1'-0"

SOSWELL ENGINEERING

NOTES

K–K).

(SECTION H-H).

1. FOR GENERAL NOTES, SEE SHEET 2.

STEEL PIPE TO MATCH EXISTING.

5. PROPOSED PEDESTRIAN RAILING SHALL BE

PEDESTRIAN RAILING ON SEAWALL LOCATED IN LOCATION 2-1, STA. 3+13 TO STA. 7+33

PEDESTRIAN RAILING LOCATED IN LOCATION 2-2,

STA. 0+00 TO STA. 1+52 (SECTION J-J), AND IN

LOCATION 3, STA. 0+00 TO STA. 1+80 (SECTION

PROPOSED PEDESTRIAN RAILING ON SEAWALL SHALL BE 2" O.D. SCHEDULE 40 GALVANIZED

"OCEANSIDE ALUMINUM ORNAMENTAL PICKET" AS MANUFACTURED BY WALPOLE OUTDOORS OR

APPROVED EQUAL. FINISH TO BE POWDER COATED

PERFORM A SURVEY OF THE EXISTING LUMINAIRES

ORDER AND ITS PHYSICAL CONDITION. THIS SURVEY SHALL BE SUBMITTED TO THE ENGINEER FOR THE RECORD. ANY LUMINAIRE THAT IS DAMAGED

SUBSEQUENTLY SHALL BE REPAIRED OR REPLACED

BY THE CONTRACTOR AT NO COST TO THE OWNER.

AND DOCUMENT WHETHER EACH IS IN WORKING

OF COLOR TO BE APPROVED BY THE OWNER.

6. PRIOR TO ANY WORK THE CONTRACTOR SHALL

7. CONTRACTOR SHALL DISCONNECT AND REMOVE EXISTING LUMINAIRES AND ALL ASSOCIATED CONDUIT AND WIRING BACK TO SOURCE OF

8. EXTERIOR JUNCTION BOXES SHALL BE UV RATED POLYVINYL CHLORIDE (PVC) WEATHERPROOF AND NON-METALLIC. BOXES SHALL BE EQUIPPED WITH

THREADED CONDUIT HUBS AND GASKETED CORROSION RESISTANT WEATHERPROOF COVERS. ALL FASTENERS SHALL BE CORROSION RESISTANT.

AND SHALL BE SOLVENT WELD TYPE.

RADIUS FOR SIZES 2" AND LARGER.

SIZE SHALL BE #12AWG.

9. CONDUIT SHALL BE SCHEDULE 80 NON-METALLIC

UV RATED PVC, ELECTRICAL GRADE, CONFORMING

MATCH CONDUIT MATERIAL AND WALL THICKNESS,

FOR SIZES #10AWG AND SMALLER. MINIMUM WIRE

PREFABRICATED ELBOWS SHALL BE STANDARD RADIUS FOR SIZES 11/2" AND SMALLER, AND LONG

10. ALL WIRE SHALL BE COPPER CONDUCTOR WITH 600V TYPE THHN/THWN OR XHHW INSULATION RATED 90 DEG. C. CONDUCTOR SHALL BE SOLID

TO NEMA STANDARDS PUB. TC-2. FITTINGS SHALL

ORIGIN/JUNCIOTN BOX.

ENGINEERS - SURVEYORS - PLANNERS - SCIENTISTS 330 PHILLIPS AVENUE, SOUTH HACKENSACK, N.J. 07606
TEL: (201) 641-0770 • FAX: (201) 641-1831
N.J. CERTIFICATE OF AUTHORIZATION NO. 24GA27958000

WESTCHESTER COUNTY, NEW YORK CONTRACT NUMBER DEPARTMENT OF PUBLIC WORKS AND TRANSPORTATION DIVISION OF ENGINEERING

CONSULTANT INFORMATION

15-531 SHEET NO. 33 OF 34 SCALE: AS NOTED

SHEET

SUPERSTORM SANDY REHABILITATION GLEN ISLAND PARK SEAWALLS AND PAVILIONS NEW ROCHELLE, NEW YORK RAILING DETAILS

DATE: MAY 2018 DPW FILE NO. 5-18-G-131

UNAUTHORIZED ALTERATION OF. OR ADDITION TO THIS PLAN IS A VIOLATION OF ARTICLE 145, SECTION 7209.2 OF THE NEW YORK STATE EDUCATION LAW.

IN CHARGE OF J. R. VALENTIN, P.E. J. R. VALENTIN, P.E. C. LINO

MADE BY

NAME DATE

RECORD DRAWING CERTIFICATION AS BUILT - CHANGES AS NOTED AS BUILT - NO CHANGES CONTRACTOR PROJECT COORDINATOR NAME SIGNATURE MADE APP'D REVISION TITLE DATE DATE

