





WESTCHESTER COUNTY, NEW YORK DEPARTMENT OF PUBLIC WORKS AND TRANSPORTATION DIVISION OF ENGINEERING

CONTRACT No. 15-528 SUPERSTORM SANDY REHABILITATION NORTH BOARDWALK RECONSTRUCTION PLAYLAND PARK RYE, NEW YORK

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APPROVED FOR CONSTRUCTION

KATHLEEN O'CONNOR

AND CONSERVATION

DEPARTMENT OF PARKS, RECREATION

COMMISSIONER


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DIRECTOR OF PROJECT MANAGEMENT


DEPARTMENT OF PUBLIC WORKS

R. SCOTT DONNELLY, P.E.

AND TRANSPORTATION

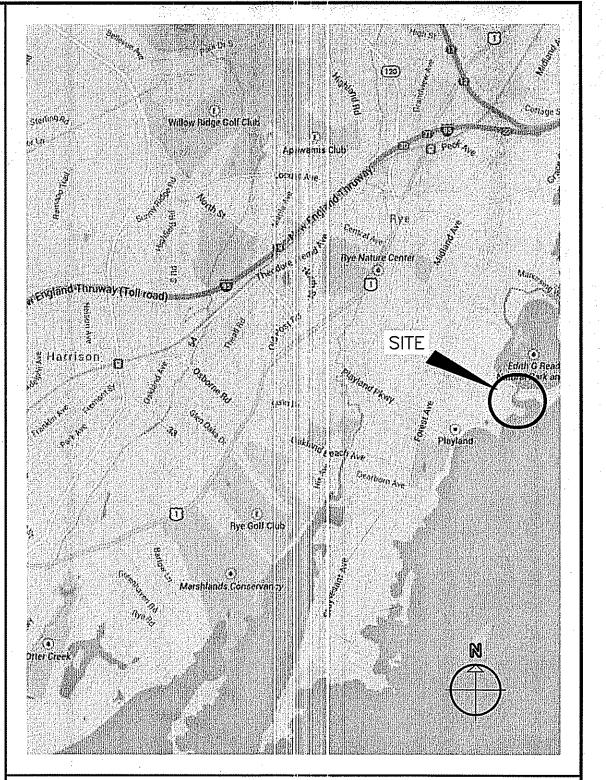

LOCATION MAP

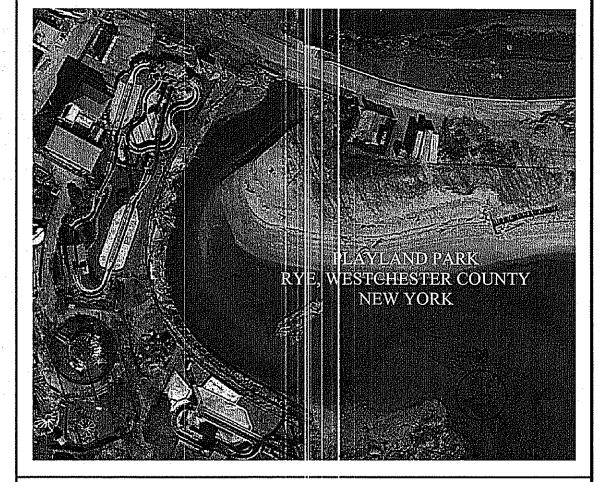

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THOMAS J. LAURO, P.E.,

DEPARTMENT OF PUBLIC WORKS

ACTING COMMISSIONER

AND TRANSPORTATION

APPROVED FOR CONSTRUCTION

/ DATE

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PROJECT COORDINATOR

WESTCHESTER COUNTY, NEW YORK DEPARTMENT OF PUBLIC WORKS AND TRANSPORTATION DIVISION OF ENGINEERING

SUPERSTORM SANDY REHABILITATION NORTH BOARDWALK RECONSTRUCTION PLAYLAND PARK RYE, NEW YORK

SHEET NO. 1 OF 21 SCALE: N.T.S. DATE: 09/22/16 DPW FILE NO. TITLE SHEET 1-08-T-142

IN CHARGE OF J. V. GREEN P.E. S. E. THORVALDSEN

DESIGN CRITERIA:

- 1. BUILDING CODE: THESE PLANS HAVE BEEN PREPARED IN ACCORDANCE WITH THE 2010 NEW YORK STATE BUILDING CODE. ALL WORK SHALL BE PERFORMED IN ACCORDANCE WITH THIS CODE AND LOCAL REQUIREMENTS.
- 2. SERVICE CONDITION DENOTES THE MAXIMUM ALLOWABLE ENVIRONMENTAL CONDITIONS WITHIN WHICH THE STRUCTURE IS DESIGNED TO OPERATE. FACTOR OF SAFETY IS IN ACCORDANCE WITH CODE. EXTREME CONDITION DENOTES THE MAXIMUM ALLOWABLE ENVIRONMENTAL CONDITIONS WITHIN WHICH THE STRUCTURE IS DESIGNED TO MAINTAIN ITS STRUCTURAL INTEGRITY. FACTOR OF SAFETY = 1.15 AGAINST YIELD OF STEEL OR FAILURE OF CONCRETE.

= 98 MPH

= II

= 0.85

= 11.52'

(PER NYC BUILDING CODE)

= 0.8 (EXPOSURE C)

- 3. DESIGN LOADS A. LIVE LOAD:
 - LIVE LOAD ON PEDESTRIAN PLATFORMS = 100 psf
 - SNOW LOAD = 50 psf
- B. SUPERIMPOSED DEAD LOAD:
- C. WIND LOAD: (ASCE 7-10) WIND SPEED
- FORCE COEFFICIENT
- RISK CATEGORY
- GUST EFFECT FACTOR D. WAVE ANALYSIS:
- EXTREME DESIGN WAVE HEIGHT
- = 9.94'SERVICE DESIGN WAVE HEIGHT WAVE PRESSURE ANALYSIS ASSUMES A STANDING WAVE PRESSURE DIAGRAM AND SAINFLOU DISTRIBUTION = 433 PSF
- 4. CONTRACTOR SHALL REVIEW SPECIFICATIONS LOCATED IN THE CONTRACT DOCUMENTS. IF THERE ARE DISCREPANCIES NOTIFY THE ENGINEER.
- 5. CONTRACTOR SHALL VERIFY ALL MEASUREMENTS AND EXISTING SITE CONDITIONS PRIOR TO CONSTRUCTION.

GENERAL NOTES:

- 1. ALL WORK SHALL CONFORM WITH ALL FEDERAL, STATE, COUNTY, OR LOCAL CODES HAVING JURISDICTION OVER SUCH WORK. ANY DISCREPANCY SHALL BE BROUGHT TO THE ATTENTION OF THE ENGINEER BEFORE PROCEEDING WITH THAT PORTION OF THE WORK.
- 2. PLAYLAND PARK IS LISTED ON THE NATIONAL REGISTER OF HISTORIC PLACES AND IS A NATIONAL HISTORIC LANDMARK (NHL). THE PROJECT'S CONSTRUCTION DOCUMENTS HAVE BEEN DEVELOPED IN COMPLIANCE WITH THE SECRETARY OF THE INTERIOR'S STANDARD FOR THE TREATMENT OF HISTORIC PROPERTIES. ANY DEVIATION FROM THE PROJECT'S CONSTRUCTION DOCUMENTS OR SPECIFICATIONS MUST BE REVIEWED BY THE COUNTY TO VERIFY THE PROJECT'S CONTINUED COMPLIANCE WITH THE STANDARDS.
- 3. CONTRACTOR IS SOLELY RESPONSIBLE FOR MEANS, METHODS, AND SAFETY OF WORK.
- 4. DIMENSIONS SHOWN ON THESE CONTRACT PLANS HAVE BEEN OBTAINED FROM LIMITED FIELD SURVEY AND MAY NOT ACCURATELY REFLECT PRESENT FIELD CONDITIONS. ACCORDINGLY, THE CONTRACTOR WILL BE RESPONSIBLE FOR MAKING FIELD MEASUREMENTS OF ALL EXISTING STRUCTURES IMPACTED BY THE PROJECT TO ASSURE CONSISTENCY WITH THE PROPOSED CONSTRUCTION PLANS; THAT IS, THE CONTRACTOR SHALL FIELD VERIFY ACTUAL CONDITIONS, DIMENSIONS, CLEARANCES, ELEVATIONS, AND OTHER INFORMATION INDICATED IN THE DOCUMENTS PRIOR TO ORDERING ANY MATERIALS, COMMENCING ANY FABRICATIONS, OR PERFORMING ANY WORK. THE CONTRACTOR SHALL NOTIFY THE OWNERS REPRESENTATIVE OF ANY FIELD CONDITIONS WHICH MAY DIFFER FROM THAT REPRESENTED PRIOR TO COMMENCING WORK.
- 5. PRIOR TO COMMENCING WORK, THE CONTRACTOR SHALL VISIT THE SITE AND SHALL NOTIFY THE OWNER'S REPRESENTATIVE OF ANY ADDITIONAL UTILITIES. STRUCTURES, OR ANY OTHER ELEMENTS WHICH MAY IMPEDE WORK. UTILITY AND/OR STRUCTURE RELOCATIONS, IF NECESSARY, SHALL BE COORDINATED THROUGH THE OWNER'S REPRESENTATIVE AT NO ADDITIONAL COST.
- 6. PRIOR TO COMMENCING ANY WORK, THE CONTRACTOR SHALL SCHEDULE AND COORDINATE ALL WORK THROUGH THE OWNER'S REPRESENTATIVE AND ANY OTHER OCCUPYING TENANT WHO WILL BE AFFECTED BY CONSTRUCTION OPERATIONS. THE CONTRACTOR SHALL COORDINATE THE WORK SO AS TO MINIMIZE INTERRUPTIONS IN FACILITY OPERATIONS. (ACCESS AND EGRESS).
- 7. THE CONTRACTOR SHALL COMPLY WITH ALL APPLICABLE OSHA REGULATIONS AND SAFETY PROCEDURES TO ENSURE PERSONNEL HEALTH AND SAFETY. THE CONTRACTOR MUST MAINTAIN A SAFE AND CLEAN WORKING ENVIRONMENT AND SHALL ASSURE PROPER PERSONAL PROTECTIVE EQUIPMENT AT ALL TIMES. IN AREAS WHERE PEDESTRIAN AND/OR VEHICULAR TRAFFIC MAY BE AFFECTED BY THE WORK, THE CONTRACTOR SHALL CORDON OFF THE WORK AREA.
- 8. THE CONTRACTOR IS SOLELY RESPONSIBLE FOR COMPLIANCE WITH THE TERMS AND CONDITIONS OF ALL PERMITS ISSUED BY ANY REGULATING AGENCY HAVING JURISDICTION OVER THE WORK OF THIS PROJECT.
- 9. THE CONTRACTOR SHALL EXERCISE EXTREME CARE TO PREVENT DAMAGE TO EXISTING STRUCTURES BY OR AS A RESULT OF HIS OPERATIONS. ANY DAMAGE RESULTING FROM THE CONTRACTOR'S OPERATIONS SHALL BE REPAIRED AS DIRECTED BY THE OWNER'S REPRESENTATIVE AT NO ADDITIONAL COST.
- 10. ALL DEBRIS AS A RESULT OF OR IN THE IMMEDIATE VICINITY OF THE WORK SHALL BE RECOVERED AND PROPERLY DISPOSED OF BY THE CONTRACTOR AT NO ADDITIONAL COST.
- 11. THE CONTRACTOR SHALL TAKE ALL NECESSARY PRECAUTIONS TO PREVENT ALL CONSTRUCTION DEBRIS OR WASTE FROM FALLING INTO THE WATER. ANY DEBRIS FALLING INTO THE WATER SHALL BE RECOVERED AND PROPERLY DISPOSED.
- 12. CONTRACTORS WILL COORDINATE WITH WESTCHESTER COUNTY DEPARTMENT OF PUBLIC WORKS AND TRANSPORTATION FOR MATERIAL LAYDOWN AREAS.
- 13. SLOPE OF DECK 1/8" PER FOOT (1/8"/FT).

- 14. CONTRACTOR TO COMPLETE MINIMUM OF FOUR (4) PULL-OUT TESTS OF CONCRETE PLANK ANCHORS AT LOCATIONS TO BE DETERMINED BY THE ENGINEER AT NO ADDITIONAL COST TO THE OWNER. CONTRACTOR TO SUBMIT ALL TEST RESULTS TO ENGINEER FOR ACCEPTANCE.
- 15. ASPHALT REMOVAL, EXCAVATION, AND GRADING WILL BE REQUIRED AT NORTH AND SOUTH TERMINALS. THIS INCLUDES PLACEMENT OF NEW BASE, SUBBASE AND ASPHALT TO PROVIDE A SMOOTH GRADE AND TRANSITION TO THE NEW BOARDWALK.
- 16. WORK TO BE SCHEDULED AROUND TIDES DUE TO PROXIMITY OF TIDE GATES FROM LAKE, CONTRACTOR TO COORDINATE WITH PLAYLAND PARK PERSONNEL.

COMPLIANCE WITH ENVIRONMENTAL PERMITS:

1. THE PERMIT CONDITIONS OUTLINED IN THESE NOTES ARE FOR INFORMATION PURPOSES ONLY. THE CONTRACTOR IS RESPONSIBLE FOR READING AND COMPLYING WITH ALL CONDITIONS STIPULATED IN THE PERMITS ISSUED BY THE REGULATORY AGENCIES. PERMITS OBTAINED INCLUDE:

USACE NAN-2016-00172 NYSDEC 3-5514-00023 3-5514-00026 3-5514-00027 3-5514-00028

F-2016-0142

- 2. THE PLANS CONTAINED HEREIN WERE PREPARED IN ACCORDANCE WITH THE ENVIRONMENTAL PERMIT(S). THE CONTRACTOR SHALL NOTIFY THE ENGINEER IMMEDIATELY OF ANY DISCREPANCIES BETWEEN THE PLANS AND PERMIT(S). WORK PERFORMED BY CONTRACTOR WHICH IS FOUND NONCOMPLIANT WITH PERMIT CONDITIONS SHALL BE REMOVED BY THE CONTRACTOR AT NO ADDITIONAL COST.
- 3. CONTRACTOR IS RESPONSIBLE FOR CONSPICUOUSLY POSTING THE PERMIT SIGN ENCLOSED WITH THE PERMIT(S) IN A PUBLICLY ACCESSIBLE LOCATION AND MAINTAINING A COPY OF THE ENVIRONMENTAL PERMIT(S) ON SITE AT ALL TIMES.
- 4. MORATORIUM FOR IN-WATER WORK: IN-WATER WORK IS PROHIBITED FROM APRIL 15 TO AUGUST 30.
- 5. NOTICE TO COMMENCE WORK: THE OWNER IS RESPONSIBLE FOR NOTIFYING THE REGULATORY AGENCIES AT LEAST SEVEN (7) DAYS PRIOR TO START OF WORK. CONTRACTOR SHALL PROVIDE OWNER WITH AN INTENDED WORK COMMENCEMENT SCHEDULE PER CONTRACT REQUIREMENTS.
- ALL NECESSARY PRECAUTIONS SHALL BE TAKEN TO PRECLUDE CONTAMINATION OF ANY WETLAND OR WATERWAY BY SUSPENDED SOLIDS, SEDIMENTS, FUELS, SOLVENTS, LUBRICANTS, EPOXY COATINGS. PAINTS. CONCRETE, LEACHATE OR ANY OTHER ENVIRONMENTALLY DELETERIOUS MATERIALS ASSOCIATED WITH THE PROJECT.
- 7. NO SITE PREPARATION WORK SHALL BE UNDERTAKEN UNTIL ALL REQUIRED EROSION CONTROL MEASURES HAVE BEEN INSTALLED.
- 8. NOTICE OF PROJECT COMPLETION: THE CONTRACTOR SHALL NOTIFY THE REGULATORY AGENCIES UPON COMPLETION OF WORK.

SUBMITTALS:

THE CONTRACTOR SHALL SUPPLY ALL SUBMITTALS STATED BELOW AND THOSE LISTED IN THE PROJECT SPECIFICATIONS:

- 1. DEMOLITION PLAN SHOWING ALL PROPOSED REMOVALS AND EXCAVATIONS. PLAN SHALL INCLUDE TEMPORARY SHORING AS NEEDED.
- 2. SHOP DRAWINGS/ERECTION DRAWINGS
- 3. PRODUCT DATA
- 4. TESTING RESULTS CERTIFICATES
- 6. CONSTRUCTION SCHEDULE

SCOPE OF WORK:

THE SCOPE OF WORK OF THIS PACKAGE SHALL INCLUDE FURNISHING ALL LABOR, MATERIALS, EQUIPMENT, AND SERVICES NECESSARY TO COMPLETELY FURNISH, FABRICATE, TRANSPORT, AND INSTALL THE ITEMS SHOWN ON THE CONTRACT DRAWINGS AND SPECIFIED HEREIN. THE BASIC SCOPE OF WORK INCLUDES, BUT IS NOT LIMITED TO, THE FOLLOWING ITEMS:

- REMOVAL OF ALL DAMAGED PORTIONS OF EXISTING HISTORIC PLATFORM. 2. REMOVAL, STORAGE AND REINSTALLATION OF EXISTING INSHORE FENCE ON
- NEW RETAINING WALL.
- 3. INSTALLATION OF PLATFORM PILES. 4. INSTALLATION OF PLATFORM CONCRETE PILE CAP.
- 5. INSTALLATION OF PLATFORM STRUCTURAL FRAMING (PLANKS).
- 6. INSTALLATION OF TIMBER DECKING AND FACADE. 7. INSTALLATION OF WALKWAY ARCHITECTURAL AND ELECTRICAL FEATURES INCLUDING, BUT NOT LIMITED TO BENCHES, RAILINGS, LAMP POSTS, AND

ALL ADDITIONAL WORK REQUIRED TO COMPLETE THE BASIC SCOPE OF WORK, IS INCLUDED IN THE SCOPE OF WORK OF THIS PACKAGE, EVEN IF NOT MENTIONED EXPLICITLY.

REFERENCE STANDARDS:

490 BOLTS

SPEAKERS.

ALL WORK WILL BE PERFORMED IN COMPLIANCE WITH THE FOLLOWING PUBLICATIONS OR STANDARDS:

- 1. AMERICAN INSTITUTE OF STEEL CONSTRUCTION (AISC) A. CODE OF STANDARD PRACTICE FOR STEEL BUILDINGS AND BRIDGES B. SPECIFICATIONS FOR STRUCTURAL STEEL BUILDINGS C. SPECIFICATION FOR STRUCTURAL JOINTS USING ASTM A 325 OR ASTM A
- 2. AMERICAN SOCIETY FOR TESTING AND MATERIALS (ASTM) A. ASTM A6 STANDARD SPECIFICATION FOR GENERAL REQUIREMENTS FOR ROLLED STRUCTURAL STEEL BARS, PLATES, SHAPES, AND SHEET PILING B. ASTM A325 STANDARD SPECIFICATIONS FOR STRUCTURAL STEEL BOLTS,
- HEAT TREATED, 830 N/MM2, MINIMUM TENSILE STRENGTH C. ASTM A572 OR ASTM A992 HIGH STRENGTH LOW ALLOY STRUCTURAL
- D. ASTM F941 STANDARD PRACTICE FOR INSPECTION OF MARINE SURFACE PREPARATION AND COATING APPLICATION

- AMERICAN SOCIETY FOR NONDESTRUCTIVE TESTING (ASNT) SNT-TC-1A RECOMMENDED PRACTICE
- 4. AMERICAN CONCRETE INSTITUTE (ACI) A. ACI 318 BUILDING CODE REQUIREMENTS FOR STRUCTURAL CONCRETE B. ACI 304R GUIDE FOR MEASURING, MIXING, TRANSPORTING, AND PLACING
- C. ACI 211.1 STANDARD PRACTICE FOR SELECTING PROPORTIONS FOR NORMAL, HEAVYWEIGHT, AND MASS CONCRETE
- 5. AMERICAN WOOD COUNCIL (AWC) A. NATIONAL DESIGN SPECIFICATION FOR WOOD CONSTRUCTION (NDS)

QUALITY ASSURANCE:

MATERIALS WILL NOT BE ACCEPTED WHICH CANNOT BE IDENTIFIED WITH APPROPRIATE CERTIFICATES OF CONFORMANCE AND CERTIFIED TEST REPORTS. TEST REPORTS FOR MATERIAL TESTS AND ANALYSES SHALL BE IDENTIFIED WITH SPECIFIC LOTS AND ITEMS PRIOR TO INSTALLATION.

SHOP DRAWINGS:

- 1. THE SHOP DRAWINGS SHALL CONTAIN ALL DIMENSIONAL AND GEOMETRIC INFORMATION. MATERIALS SHALL NOT BE ORDERED, FABRICATED, OR DELIVERED BEFORE THE SHOP DRAWINGS HAVE BEEN APPROVED.
- 2. PRIOR TO REVIEW OF THE SHOP DRAWINGS BY THE ENGINEER, SUCH SHOP DRAWINGS SHALL HAVE BEEN REVIEWED AND APPROVED BY THE CONTRACTOR AND SHALL BE STAMPED TO INDICATE THIS BY THE CONTRACTOR. SUCH APPROVAL BY THE CONTRACTOR SHALL CONSTITUTE THE CONTRACTOR'S REPRESENTATION THAT THE CONTRACTOR HAS VERIFIED ALL QUANTITIES, DIMENSIONS, SPECIFIED PERFORMANCE CRITERIA, INSTALLATION REQUIREMENTS, MATERIALS, CATALOG NUMBERS AND SIMILAR DATA WITH RESPECT THERETO AND HAS REVIEWED OR COORDINATED EACH SHOP DRAWING WITH OTHER SHOP DRAWINGS AND SAMPLES AND WITH THE REQUIREMENTS OF THE WORK AND THE CONTRACT DRAWINGS AND SPECIFICATIONS.
- 3. SHOP DRAWINGS SHALL INCLUDE LAYOUTS AND DETAILS SHOWING THE TYPE OF STEEL FOR EACH MEMBER, SIZES OF MEMBERS, CONNECTIONS, CUTS, AND OTHER PERTINENT DATA.
- 4. SHOP DRAWINGS SHALL BE SUBMITTED IN COMPLETE PACKAGES SO THAT INDIVIDUAL PARTS AND THE ASSEMBLED UNIT MAY BE REVIEWED TOGETHER.
- 5. THE REVIEW OF SHOP DRAWINGS BY THE ENGINEER SHALL NOT IN ANY WAY RELIEVE THE CONTRACTOR FROM THE RESPONSIBILITY FOR THE ADEQUACY OF THE DESIGN OF THE CONNECTIONS AND ALL REQUIRED DETAILING, THE RESPONSIBILITY FOR THE PROPER FITTING OF THE WORK IN STRICT CONFORMANCE WITH THE CONTRACT REQUIREMENTS AND FROM THE NECESSITY OF FURNISHING MATERIAL AND WORKMANSHIP REQUIRED BY CONTRACT DRAWINGS AND SPECIFICATIONS IN ADDITION TO THAT INDICATED ON THE SHOP DRAWINGS.
- THE CONTRACTOR SHALL KEEP A COMPLETE SET OF SHOP DRAWINGS BEARING THE ENGINEER'S ACCEPTANCE STAMP ON THE JOB SITE AT ALL TIMES SUBSEQUENT TO SUCH ACCEPTANCE.

DELIVERY, STORAGE & HANDLING:

- DELIVER MATERIALS TO THE CONSTRUCTION SITE AT APPROPRIATE INTERVALS SO AS TO ENSURE UNINTERRUPTED PROGRESS OF WORK.
- 2. MATERIAL SHALL BE STORED OFFSITE IN AN AREA DESIGNATED OR APPROVED BY THE OWNER. STRUCTURAL COMPONENTS SHALL BE DRAINED PROPERLY. ADEQUATE SHORING AND PROTECTION SHALL BE PROVIDED TO PREVENT DISTORTION AND OTHER DAMAGE. STRUCTURAL COMPONENTS SHALL BE STORED ON TIMBER AND NOT ON MUD OR CINDERS, AND OTHERWISE HANDLED SO AS NOT TO DAMAGE COMPONENTS. ALL COMPONENTS WHICH ARE TO BE PLACED IN GROUND STORAGE SHALL BE READILY ACCESSIBLE FOR INSPECTION.
- MATERIALS WHICH FAIL TO COMPLY WITH SPECIFIED REQUIREMENTS, EITHER AT THE SHOP OR CONSTRUCTION SITE, SHALL BE PROMPTLY REMOVED FROM THE SITE AND REPLACED WITH ACCEPTABLE MATERIAL, WITHOUT ADDITIONAL COST TO THE OWNER, AND WITHOUT CAUSING DELAY IN WORK.

DEMOLITION:

- 1. THE CONTRACTOR SHALL SUBMIT TO THE OWNERS REPRESENTATIVE, A REMOVAL SCHEDULE, AND A TEMPORARY SHORING PLAN AS MAY BE REQUIRED FOR DEMOLITION AND REMOVALS. THE TEMPORARY SHORING PLAN SHALL BE DESIGNED AND PREPARED BY A PROFESSIONAL ENGINEER, LICENSED IN THE STATE OF NEW YORK. THE CONTRACTOR SHALL NOT COMMENCE WORK WITHOUT APPROVAL FROM THE OWNER'S REPRESENTATIVE OF THE DEMOLITION AND REMOVAL SCHEDULE AND THE TEMPORARY SHORING
- 2. THE CONTRACTOR IS RESPONSIBLE FOR LOCATING, IDENTIFYING AND MARKOUT OF ALL UTILITIES PRIOR TO START OF DEMOLITION WORK.
- 3. THE CONTRACTOR IS RESPONSIBLE FOR COORDINATING AND STAGING DEMOLITION WORK WITH OTHER CONSTRUCTION ACTIVITIES AT THE SITE.
- 4. THE CONTRACTOR SHALL PERFORM ALL WORK WITH CARE SO THAT ANY MATERIALS WHICH ARE TO REMAIN IN PLACE, OR WHICH ARE TO REMAIN THE PROPERTY OF THE OWNER, WILL NOT BE DAMAGED. IF CONTRACTOR DAMAGÉS ANY MATERIALS WHICH ARE TO REMAIN IN PLACE, OR WHICH ARE TO REMAIN THE PROPERTY OF THE OWNER, DAMAGED MATERIALS SHALL BE REPAIRED OR REPLACED IN A MANNER SATISFACTORY TO OWNER'S REPRESENTATIVE AT THE EXPENSE OF THE CONTRACTOR.
- WHENEVER ITEMS IN THE CONTRACT REQUIRE MATERIALS TO BE REMOVED AND DISPOSED, THE COST OF SUPPLYING A DISPOSAL AREA AND TRANSPORTATION TO THAT AREA SHALL BE INCLUDED IN THE PRICE BID FOR THOSE ITEMS.
- 6. ALL DEBRIS AS A RESULT OF, OR IN THE IMMEDIATE VICINITY OF THE WORK SHALL BE RECOVERED AND PROPERLY DISPOSED OF BY THE CONTRACTOR AT NO ADDITIONAL COST TO THE OWNER.
- 7. THE CONTRACTOR SHALL TAKE ALL NECESSARY PRECAUTIONS TO PREVENT ALL CONSTRUCTION DEBRIS OR WASTE FROM FALLING INTO THE WATER. ANY DEBRIS FALLING INTO THE WATER SHALL BE RECOVERED AND LEGALLY DISPOSED OF AT NO ADDITIONAL COST TO THE OWNER.

EXCAVATION AND BACKFILL:

- 1. THE CONTRACTOR SHALL SUBMIT TO THE OWNERS REPRESENTATIVE, A REMOVAL SCHEDULE, AND A TEMPORARY SHORING PLAN AS MAY BE REQUIRED FOR DEMOLITIONS AND REMOVALS. THE TEMPORARY SHORING PLAN SHALL BE DESIGNED AND PREPARED BY A LICENSED PROFESSIONAL ENGINEER. THE CONTRACTOR SHALL NOT COMMENCE WORK WITHOUT APPROVAL FROM THE OWNERS REPRESENTATIVE OF THE DEMOLITION AND REMOVAL SCHEDULE AND THE TEMPORARY SHORING PLAN.
- 2. WHENEVER ITEMS IN THE CONTRACT REQUIRE MATERIALS TO BE REMOVED AND DISPOSED, THE COST OF SUPPLYING A DISPOSAL AREA AND TRANSPORTATION TO THAT AREA SHALL BE INCLUDED IN THE LUMP SUM PRICE BID FOR THOSE ITEMS.
- 3. EXCAVATION SHALL INCLUDE REMOVAL OF PAVEMENTS, FOUNDATIONS, AND ALL OTHER MATERIALS INCLUDING ROCK, IF ENCOUNTERED.
- 4. EXCAVATIONS SHALL BE TO ELEVATIONS REQUIRED FOR INSTALLATION OF PERMANENT CONSTRUCTION WITHOUT DISTURBANCE TO SUBGRADE BELOW SUCH ELEVATIONS.
- 5. BACKFILLING SHALL INCLUDE FILLING OF EXCAVATIONS MADE FOR CONSTRUCTION PURPOSES, EXTENDING TO EXISTING OR DESIGN GRADE.
- 6. ALL TRUCKS USED TO TRANSPORT EXCAVATED MATERIALS SHALL BE TARPED PURSUANT TO THE APPLICABLE NYSDOT REQUIREMENTS OR APPLICABLE REGULATORY AGENCY REQUIREMENTS.
- 7. BACKFILL SHALL BE PLACED IN EIGHT INCH MAXIMUM LOOSE LIFTS AND COMPACTED TO PROVIDE 95% OF MAXIMUM DRY DENSITY PER ASTM. D-1556. MOISTURE CONTENT SHALL BE MAINTAINED WITHIN A RANGE OF PLUS OR MINUS 2% OF OPTIMUM.

PILE DRILLING:

- 1. PILES SHALL BE DRILLED TO CAPACITIES INDICATED ON PLANS.
- 2. STEEL PIPE PILES SHALL BE DRILLED TO AN ALLOWABLE AXIAL CAPACITY OF 40 TONS AND A MINIMUM EMBEDMENT OF 10 FEET INTO ROCK.
- 3. LOAD TESTING OF ONE PILE AT INBOARD PIER SECTION, ONE PILE AT OUTBOARD PIER SECTION AND ONE PILE AT FUTURE PIER EXTENSION AT THE TIME OF CONSTRUCTION SHALL BE CONDUCTED TO VERIFY PILE CAPACITY, PER CODE SECTION 1808.2.8.3.
- 4. PILE DRILLING OPERATIONS SHALL BE OBSERVED, INSPECTED, MONITORED, LOGGED, SIGNED, AND REVIEWED BY A PROFESSIONAL ENGINEER LICENSED IN THE STATE OF NEW YORK.

1. ALL TIMBER SHALL BE IPE UNLESS OTHERWISE NOTED, ALL IPE SHALL BE SOLID. ROUGH SAWN TIMBER WITH A MINIMUM STRESS RATING OF 4500 PSI.



INFORMATION

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WESTCHESIER COUNTY, NEW YORK 15-528 DEPARTMENT OF PUBLIC WORKS AND TRANSPORTATION

RYE, NEW YORK

GENERAL NOTES - 1

DIVISION OF ENGINEERING SUPERSTORM SANDY REHABILITATION NORTH BOARDWALK RECONSTRUCTION PLAYLAND PARK

SHEET NO. 2 OF 21 SCALE: AS NOTED DATE: 09/22/16 DPW FILE NO. 1-08-G-143

G-001

MADE BY B. G. MARQUEZ

IN CHARGE OF J. V. GREEN P.E.

CHECKED BY S. E. THORVALDSEN

STEEL PIPE PILES:

- 1. STEEL PIPE PILES SHALL CONFORM TO ASTM A252 GRADE 3 WITH A MINIMUM YIELD STRESS OF 45 KSI AND SHALL BE FREE OF GREASE, MILL SCALE AND OTHER SUBSTANCES.
- 2. STEEL PIPE PILES SHALL HAVE MAXIMUM CAMBER OF 2" OVER THE LENGTH OF THE PILE AS DELIVERED ON SITE.
- 3. STEEL PIPE PILES SHALL HAVE MAXIMUM SWEEP OF 1" OVER THE LENGTH OF THE PILE AS DELIVERED ON SITE
- 4. STEEL PILES SHALL BE COATED WITH ONE OF THE FOLLOWING SYSTEMS: A. SHERWIN WILLIAMS TAR-GARD. 2 CTS @ 8-16 MILS/COAT DFT. B. SHERWIN WILLIAMS DURAPLATE BY SPLASH ZONE 1 CT @ 15-30 MILS/COAT DFT.
- C. HEMPEL HEMPADUE MULTI-STRENGTH 45751 2 CTS @ 8 MILS/COAT DFT. D. TNEMEC HI-BUILD TNEME-TAR 46H-413 2 CTS @ 8-10 MILS/CT DFT. E. CARBOLINE BITUMASTIC 300M 2 CTS @ 8-16 MILS/CT DFT. F. APPROVED EQUAL
- 5. DAMAGED COATINGS SHALL BE REPAIRED BY THE CONTRACTOR IN ACCORDANCE WITH MANUFACTURER'S INSTRUCTIONS AT HIS OWN EXPENSE.
- 6. CONTRACTOR OR FABRICATOR SHALL TEST FOR CONTINUITY OF COATING ON 100% OF SURFACES WITH A LOW VOLTAGE HOLIDAY TESTER AND REPAIR ALL HOLIDAYS DETECTED TO MEET SUCH TEST.
- MATERIAL DATA SHEET FOR COATINGS SHALL BE SUBMITTED TO THE OWNER FOR APPROVAL

CONCRETE:

- 1. ALL CONCRETE WORK SHALL CONFORM TO REQUIREMENTS OF THE ACI BUILDING CODE REQUIREMENT FOR STRUCTURAL CONCRETE (318-11).
- 2. ALL CONCRETE SHALL BE AIR ENTRAINED, 6% ± 1.5% BY VOLUME, FOR 3/4" COARSE AGGREGATE. NO CARBONACEOUS AGGREGATES SHALL BE USED.
- 3. ALL CONCRETE SHALL BE MIXED, TRANSPORTED AND PLACED IN ACCORDANCE WITH ACI STANDARDS 318 AND 304.
- 4. FOLLOW ACI STANDARD 211.1 FOR MIXING WATER REQUIREMENTS.
- 5. ALL CONCRETE SHALL HAVE COMPRESSIVE STRENGTH Fc' = 5000 PSI AT 28 DAYS WITH A MAXIMUM W/C RATIO OF 0.38 UNLESS NOTED OTHERWISE ON SCHEDULES OR NOTES.
- 6. MAXIMUM CONCRETE SLUMP SHALL BE 4", PRIOR TO THE ADDITION OF PLASTICIZING ADMIXTURES.
- 7. TEST CYLINDERS SHALL BE TAKEN FROM THE MIXER IN ACCORDANCE WITH ASTM C172.
- 8. CONSTRUCTION JOINTS SHALL BE NO MORE THAN 40 FT. ON CENTER, UNLESS OTHERWISE NOTED.

REINFORCING:

- 1. CONCRETE COVER MEASURED TO THE FACE OF THE REINFORCING BAR (INCLUDING TIES AND STIRRUPS) SHALL BE 3" UNLESS OTHERWISE INDICATED IN THE PLANS.
- 2. ALL REINFORCING BARS SHALL BE NEW BILLET STEEL CONFORMING TO ASTM A615, GRADE 60.
- 3. ALL REINFORCING BARS SHALL BE EPOXY COATED IN CONFORMANCE WITH ASTM A775.
- 4. ALL CRACKED AND/OR CHIPPED EPOXY COATING SHALL BE RECOATED ACCORDING TO MANUFACTURER'S RECOMMENDATIONS.
- 5. ALL SPLICE LENGTHS SHALL BE MINIMUM OF 27" (U.O.N.)
- 6. USE TENSION SPLICE FOR ALL SPLICES (U.O.N.)
- 7. THE CONTRACTOR MAY SUBMIT LESSER SPLICE LENGTHS FOR REVIEW AND APPROVAL TO THE ENGINEER OF RECORD AT THE SAME TIME PROVIDING THE
- FOLLOWING INFORMATION: A. DETAILS PREPARED AND SUBMITTED BY THE CONTRACTOR INDICATING LOCATION AND PROPOSED LAYOUT OF REBARS AND LENGTHS OF SPLICES. B. WHERE THE SIZE AND NUMBER OF TIES PERMIT THE REDUCTION OF LAP LENGTH. THOSE BARS SHALL BE INDICATED ON THE DETAILS. C. WHERE COMPUTED STRESS VALUES PERMIT THE REDUCTION OF LAP LENGTH, COMPUTATIONS SHALL BE SUBMITTED FOR REVIEW. D. THE APPLICABLE SECTION OF THE ACI-318-05 CODE PERMITTING THE LESSER SPLICE LENGTH SHALL BE INDICATED ON THE SUBMITTED
- 8. WHERE BARS OF DIFFERENT SIZES ARE TO BE SPLICED. THE SPLICE LENGTH FOR ALL BARS SHALL BE THAT REQUIRED FOR THE LARGEST.
- 9. ALL SPLICE LENGTHS SHALL BE GREATER THAN OR EQUAL TO 36 X REINFORCING BAR DIAMETER FOR NO.6 BARS AND SMALLER. ALL SPLICE LENGTHS SHALL BE GREATER THAN OR EQUAL TO 45 X REINFORCING BAR DIAMETER FOR NO.7 BARS AND LARGER.
- 10. ALL WELDED WIRE MESH SHALL CONFORM TO ASTM 185.

GROUT:

MATERIAL.

- 1. HIGH STRENGTH, NON-SHRINK CEMENTITIOUS GROUT SHALL BE USED.
- 2. ACCEPTABLE GROUTS ARE SIKAGROUT 212 BY SIKADUR; MASTER FLOW 928 BY CHEMREX; HI-FLOW GROUT BY EUCLID; OR APPROVED EQUIVALENTS.
- 3. ALUMINUM BASE PLATES SHALL BE PROPERLY COATED ON ALL SIDES.

PRECAST PRESTRESSED CONCRETE PLANKS:

- 1. PRESTRESSING STEEL SHALL CONFORM TO ASTM A416.
- 2. THE PRESTRESSING STRANDS SHALL BE LOW RELAXATION 0.5 INCH DIAMETER WITH A GUARANTEED ULTIMATE STRENGTH OF 270 KSI. JACKING FORCE = 33 KIP PER STRAND.
- 3. THE LOCATION AND TYPE OF ALL PERMANENT INSERTS (e.g. BOTTOM ANCHOR PLATE FOR RAILING, INSERTS FOR UTILITY HANGERS, ETC.) AND DETAILED ON THE PRESTRESSED CONCRETE "SHOP DRAWINGS", SHALL BE SUBMITTED FOR APPROVAL.
- 4. BAR REINFORCEMENT SHALL BE ASTM A615 GRADE 60. MINIMUM CONCRETE COVER TO MILD STEEL SHALL BE 2½" OR AS SHOWN ON THE DRAWINGS.
- THE TOPS OF PRESTRESSED UNITS SHALL RECEIVE A TRANSVERSE STIFF BROOM FINISH.
- 6. ALL EXPOSED CORNERS, EXCEPT THE TOP, SHALL BE CHAMFERED 3/4 INCH.
- 7. REQUIRED MINIMUM CONCRETE COMPRESSIVE STRENGTH AT TRANSFER f'c=3,500 PSI. REQUIRED MINIMUM CONCRETE COMPRESSIVE STRENGTH AT 28 DAYS, f'c=6,000 KSI.
- 8. THE ALLOWABLE TENSION IN THE PRESTRESSED CONCRETE UNITS AT TRANSFER, fti=177 PSI, AT 28 DAY STRENGTH, ft=232 PSI.
- 9. ALL PRESTRESSED AND CONVENTIONAL REINFORCING STEEL SHALL HAVE A MINIMUM 3" CONCRETE COVER.

BONDING AGENTS FOR CONCRETE:

- 1. WHERE FRESH CONCRETE IS TO BE POURED AGAINST PREVIOUSLY CURED CONCRETE, THE SURFACE OF THE EXISTING CONCRETE SHALL BE COATED WITH AN EPOXY RESIN/PORTLAND CEMENT BONDING AGENT, SUCH AS A SIKADUR ARMATEC 110, OR APPROVED EQUIVALENT.
- 2. PRIOR TO APPLYING THE BONDING AGENT, PREPARE THE EXISTING CONCRETE SURFACE BY JET-BLASTING THE IMMEDIATE SURFACE TO REMOVE OIL, DEBRIS AND LOOSE CONCRETE. FOLLOW THE MANUFACTURER'S RECOMMENDATIONS FOR ADDITIONAL SURFACE PREPARATION REQUIREMENTS.
- BONDING AGENT NOT REQUIRED FOR CONSTRUCTION JOINTS BUILT PER STANDARD DETAILS.
- 4. A MAXIMUM CURING TIME OF 3 HRS BETWEEN APPLICATION OF THE BONDING AGENT AND THE CONCRETE POUR IS REQUIRED.

WELDING:

- 1. ALL WELDING AND FABRICATION SHALL CONFORM WITH THE AMERICAN WELDING SOCIETY (AWS) REQUIREMENTS AND GUIDELINES.
- 2. ALL WELDERS SHALL BE CERTIFIED BY AWS GUIDELINES.
- 3. UNLESS OTHERWISE INDICATED, ALL FILLET WELDS SHALL BE CONTINUOUS AND DOUBLE SIDED. ALL BUTT WELDS SHALL BE COMPLETE PENETRATIONS WELDS.
- 4. ALL WELDS SHALL BE SUBJECT TO NON DESTRUCTIVE TESTING AT THE DISCRETION OF THE ENGINEER OF RECORD AND AT THE CONTRACTOR'S
- 5. ALL ELECTRODES USED SHALL COMPLY WITH ABS OR AWS SPECIFICATION AND SHALL BE E70XX LOW HYDROGEN.
- 6. ANY DEFECTS SHALL BE CORRECTED IN ACCORDANCE WITH AWS RULES AT NO ADDITIONAL COST TO THE OWNER.
- 7. ALL PIPE PILE SPLICES SHALL BE COMPLETE PENETRATION BUTT WELDS.

STEEL HARDWARE:

SQUARE FOOT.

- 1. STEEL FOR TIMBER CONNECTIONS SHALL CONFORM TO THE FOLLOWING ASTM
- SPECIFICATIONS: THREADED ROD ASTM A36 ASTM A307 GRADE A BOLTS NUTS ASTM A563 ASTM F436 WASHERS MISCELLANEOUS ASTM A36 HOT ROLLED STEEL ASTM A36 PLATES
- 2. GALVANIZING: ALL TIMBER CONNECTING HARDWARE SHALL BE HOT-DIPPED GALVANIZED, AFTER FABRICATION, IN ACCORDANCE WITH THE REQUIREMENTS OF THE APPLICABLE SPECIFICATIONS AND OTHER REQUIREMENTS LISTED
- A. SPECIFICATIONS FOR ZINC (HOT-GALVANIZED) COATINGS ON PRODUCTS FABRICATED FROM ROLLED, DRESSED AND FORGED STEEL SHAPES, PLATES AND STRIP - ASTM A123.
- B. SPECIFICATION FOR ZINC COATING (HOT-DIPPED GALVANIZED) ON IRON AND STEEL HARDWARE - ASTM A153.
- C. SPECIFICATION FOR ZINC COATING (HOT-DIP) ON ASSEMBLED STEEL
- PRODUCTS ASTM A386. D. THE ZINC COATING SHALL WEIGH NOT LESS THAN 2 OUNCES PER
- E. ZINC DUST-ZINC OXIDE PRIMER CONFORMING TO MILITARY SPECIFICATION MIL-P-21035 SHALL BE APPLIED IN 2 COATS FOR REPAIRS TO DAMAGED SURFACES AFTER REMOVAL OF LOOSE OR CRACKED ZINC COATING.
- F. PRIOR TO GALVANIZING, ALL WELDED CONNECTIONS SHALL BE SEALED ALL AROUND WITH A SEAL WELD. BOLTED CONNECTIONS SHALL NOT BE MADE PRIOR TO GALVANIZING.

LAG SCREWS:

- 1. LAG SCREWS SHALL CONFORM TO ANSI/ASME STANDARD B18.2.1-1981 AND SHALL BE HOT-DIPPED GALVANIZED.
- 2. LEAD HOLES FOR LAG SCREWS SHALL BE BORED AS FOLLOWS: A. THE CLEARANCE HOLE FOR THE SHANK SHALL HAVE THE SAME DIAMETER AS THE SHANK AND THE SAME DEPTH OF PENETRATION AS THE LENGTH OF UNTHREADED SHANK.
- B. THE LEAD HOLE FOR THE THREADED PORTION SHALL HAVE A DIAMETER EQUAL TO 70% OF THE BOLT DIAMETER AND A LENGTH EQUAL TO AT LEAST THE LENGTH OF THE THREADED PORTION
- 3. THE THREADED PORTION OF THE LAG SCREW SHALL BE INSERTED IN ITS LEAD HOLE BY TURNING WITH A WRENCH, NOT BY DRIVING WITH A HAMMER.
- 4. SOAP OR OTHER LUBRICANT SHALL BE USED ON THE LAG SCREWS OR IN THE LEAD HOLES TO FACILITATE INSERTION AND PREVENT DAMAGE TO THE LAG SCREW.

COMMERCIAL/MANUFACTURED COMPONENTS:

- 1. THESE COMPONENTS SHALL BE INSTALLED AND LOCATED IN ACCORDANCE WITH MANUFACTURER'S RECOMMENDATIONS, UNLESS OTHERWISE NOTED.
- 2. CONTRACTOR MUST SUBMIT SHOP DRAWINGS, MANUFACTURER'S SPECIFICATIONS AND SIGNED AND SEALED CALCULATIONS FOR APPROVAL BY ENGINEER FOR ALL COMMERCIAL/MANUFACTURER'S COMPONENTS.

EPOXY ADHESIVE ANCHORS:

1. EPOXY ADHESIVE ANCHORS SHALL BE INSTALLED WITH ONE OF THE FOLLOWING SYSTEMS OR APPROVED EQUAL: A. HILTI HIT-RE 500-SD ADHESIVE.

TIDAL DATA						
	NAVD88					
MEAN HIGHER-HIGH WATER (MHHW)	3.75					
MEAN HIGH WATER (MHW)	3.39					
NAVD88	0.0					
MEAN DIURNAL TIDE LEVEL (DTL)	-0.19					
MEAN SEA LEVEL (MSL)	-0.24					
MEAN TIDE LEVEL (MTL)	-0.25					
NGVD29	-1.11					
MEAN LOW WATER (MLW)	-3.90					
MEAN LOWER-LOW WATER (MLLW)	-4.14					

1. WATER ELEVATIONS SHOWN FOR PROJECT SITE BASED ON NOAA TIDE STATION 8518091, RYE BEACH AMUSEMENT PARK, NY.

- 2. ALL ELEVATIONS SHOWN REFERENCE NAVD88.
- 3. ELEVATIONS ARE IN FEET.

ABBREVIATIONS:

ADDITIONAL ALTERNATE BEAM BM. BOT. BOTTOM BEARING PLATE CLR. CLEAR CENTERLINE CONC. CONCRETE CONST. CONSTRUCTION DIA. OR Ø DIAMETER DWG. DRAWING DWL(S) DOWEL(S) EL. ÒŔ ELEV. ELEVATÌON EQUAL EQ. EXIST. EXISTING EXP. JT. **EXPANSION JOINT** FIN. FINISH F.L. FACADE LINE FT. OR FEET OR FOOT FOOTING YIELD STRESS GALVANIZED GR. GRADE HIGH POINT HIGH STRENGTH H.S. H.S.B. HIGH STRENGTH BOLT IN. OR " INCHES JOIST KIPS PER SQUARE INCHES KSI. LONGITUDINAL LONG. LLH LONG LEG HORIZONTAL LLV LONG LEG VERTICAL L.P. LOW POINT MAX. MAXIMUM MBD MANHATTAN BOROUGH DATUM MEAN HIGHER HIGH WATER MHHW MHW MEAN HIGH WATER MIN. MINIMUM MECH. **MECHANICAL** MISC MISCELLANEOUS MLLW MEAN LOWER LOW WATER MEAN LOW WATER MLW MSL MEAN SEA LEVEL MEAN TIDE LEVEL MTL NAVD88 NORTH AMERICAN VERTICAL DATUM NGVD29 NATIONAL GEODETIC VERTICAL DATUM N.T.S. NOT TO SCALE 0.C. ON CENTER PLATE PSI. POUNDS PER SQUARE INCH PSF. POUNDS PER SQUARE FOOT POLYVINYL CHLORIDE PVC RADIUS REINF. REINFORCING SECT. SECTION SIM. SIMILAR S.O.G. SLAB ON GRADE STAINLESS STEEL SS STIFF. STIFFENER STRUCT STRUCTURE SYMM. SYMMETRICAL THICK OR THICKNESS THK. OR THKNS. THROUGH OUT T.O.S. TOP OF STEEL TYP. **TYPICAL** U.O.N. UNLESS OTHERWISE NOTED VAR. VARIES VERT. VERTICAL V.I.F. VERIFY IN FIELD WORK POINT



INFORMATION

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PROJECT COORDINATOR

NUMBER

15-528

DPW FILE NO.

SHEET NO. 3 OF 21

SCALE: AS NOTED

DATE: 09/22/16

1-08-G-144

NUMBER

G-002

REVISION DATE MADE REVISION NUMBER BY

RECORD DRAWING CERTIFICATION

NAME

SIGNATURE

AS BUILT - CHANGES AS NOTED AS BUILT - NO CHANGES

CONTRACTOR NAME SIGNATURE

WESTCHESTER COUNTY, NEW YORK DEPARTMENT OF PUBLIC WORKS AND TRANSPORTATION DIVISION OF ENGINEERING

DATE

	SUPERSTORM SANDY REHABILITATION	
NORTH	BOARDWALK RECONSTRUCTION PLAYLAND PARK	
	RYE, NEW YORK	
	GENERAL NOTES - 2	

IN CHARGE OF J. V. GREEN P.E. CHECKED BY ____ S. E. THORVALDSEN MADE BY ______B. G. MARQUEZ



LEGEND: ---- CONTOUR LINE INDEX CONTOUR LINE **EDGE OF PAVEMENT** IRON FENCE EDGE OF CONCRETE STRUCTURE SPOT EL. GAS VALVE **UNKNOWN VALVE HYDRANT** EXISTING PILES DESTROYED PILES

CONSULTANT INFORMATION

applied ingenuity

M. G. McLAREN, P.C.

100 Snake Hill Road, West Nyack, NY 10994 Tel. (845) 353-6400 Fax. (845) 353-6509 www.mgmclaren.com

REVISION DATE MADE APP'D BY BY REVISION RECORD DRAWING CERTIFICATION

AS BUILT — CHANGES AS NOTED

AS BUILT — NO CHANGES

CONTRACTOR

NAME SIGNATURE DATE CONTRACT NUMBER

PROJECT COORDINATOR

15-528

SHEET NUMBER

G-003

WESTCHESTER COUNTY, NEW YORK DEPARTMENT OF PUBLIC WORKS AND TRANSPORTATION DIVISION OF ENGINEERING SHEET NO. 4 OF 21

SUPERSTORM SANDY REHABILITATION NORTH BOARDWALK RECONSTRUCTION PLAYLAND PARK

SCALE: AS NOTED DATE: 09/22/16 DPW FILE NO. RYE, NEW YORK SITE SURVEY 1-08-G-145 C

NOTES:


1. LANDMETRICS ENGINEERING AND LAND SURVEYING P.C., PERFORMED A HYDROGRAPHIC SURVEY ALONG THE NORTHSIDE OF RYE PLAYLAND BOARDWALK ON 5/13/2015.


2. HORIZONTAL DATUM: N.Y.S.P.C.S. NAD 1983 NEW YORK STATE PLANE.


3. ALL ELEVATIONS SHOWN IN FEET IN REFERENCE TO NAVD 88.


4. GIS MAP TAKEN FROM 2011.


IN CHARGE OF J. V. GREEN P.E. CHECKED BY S. E. THORVALDSEN MADE BY B. G. MARQUEZ

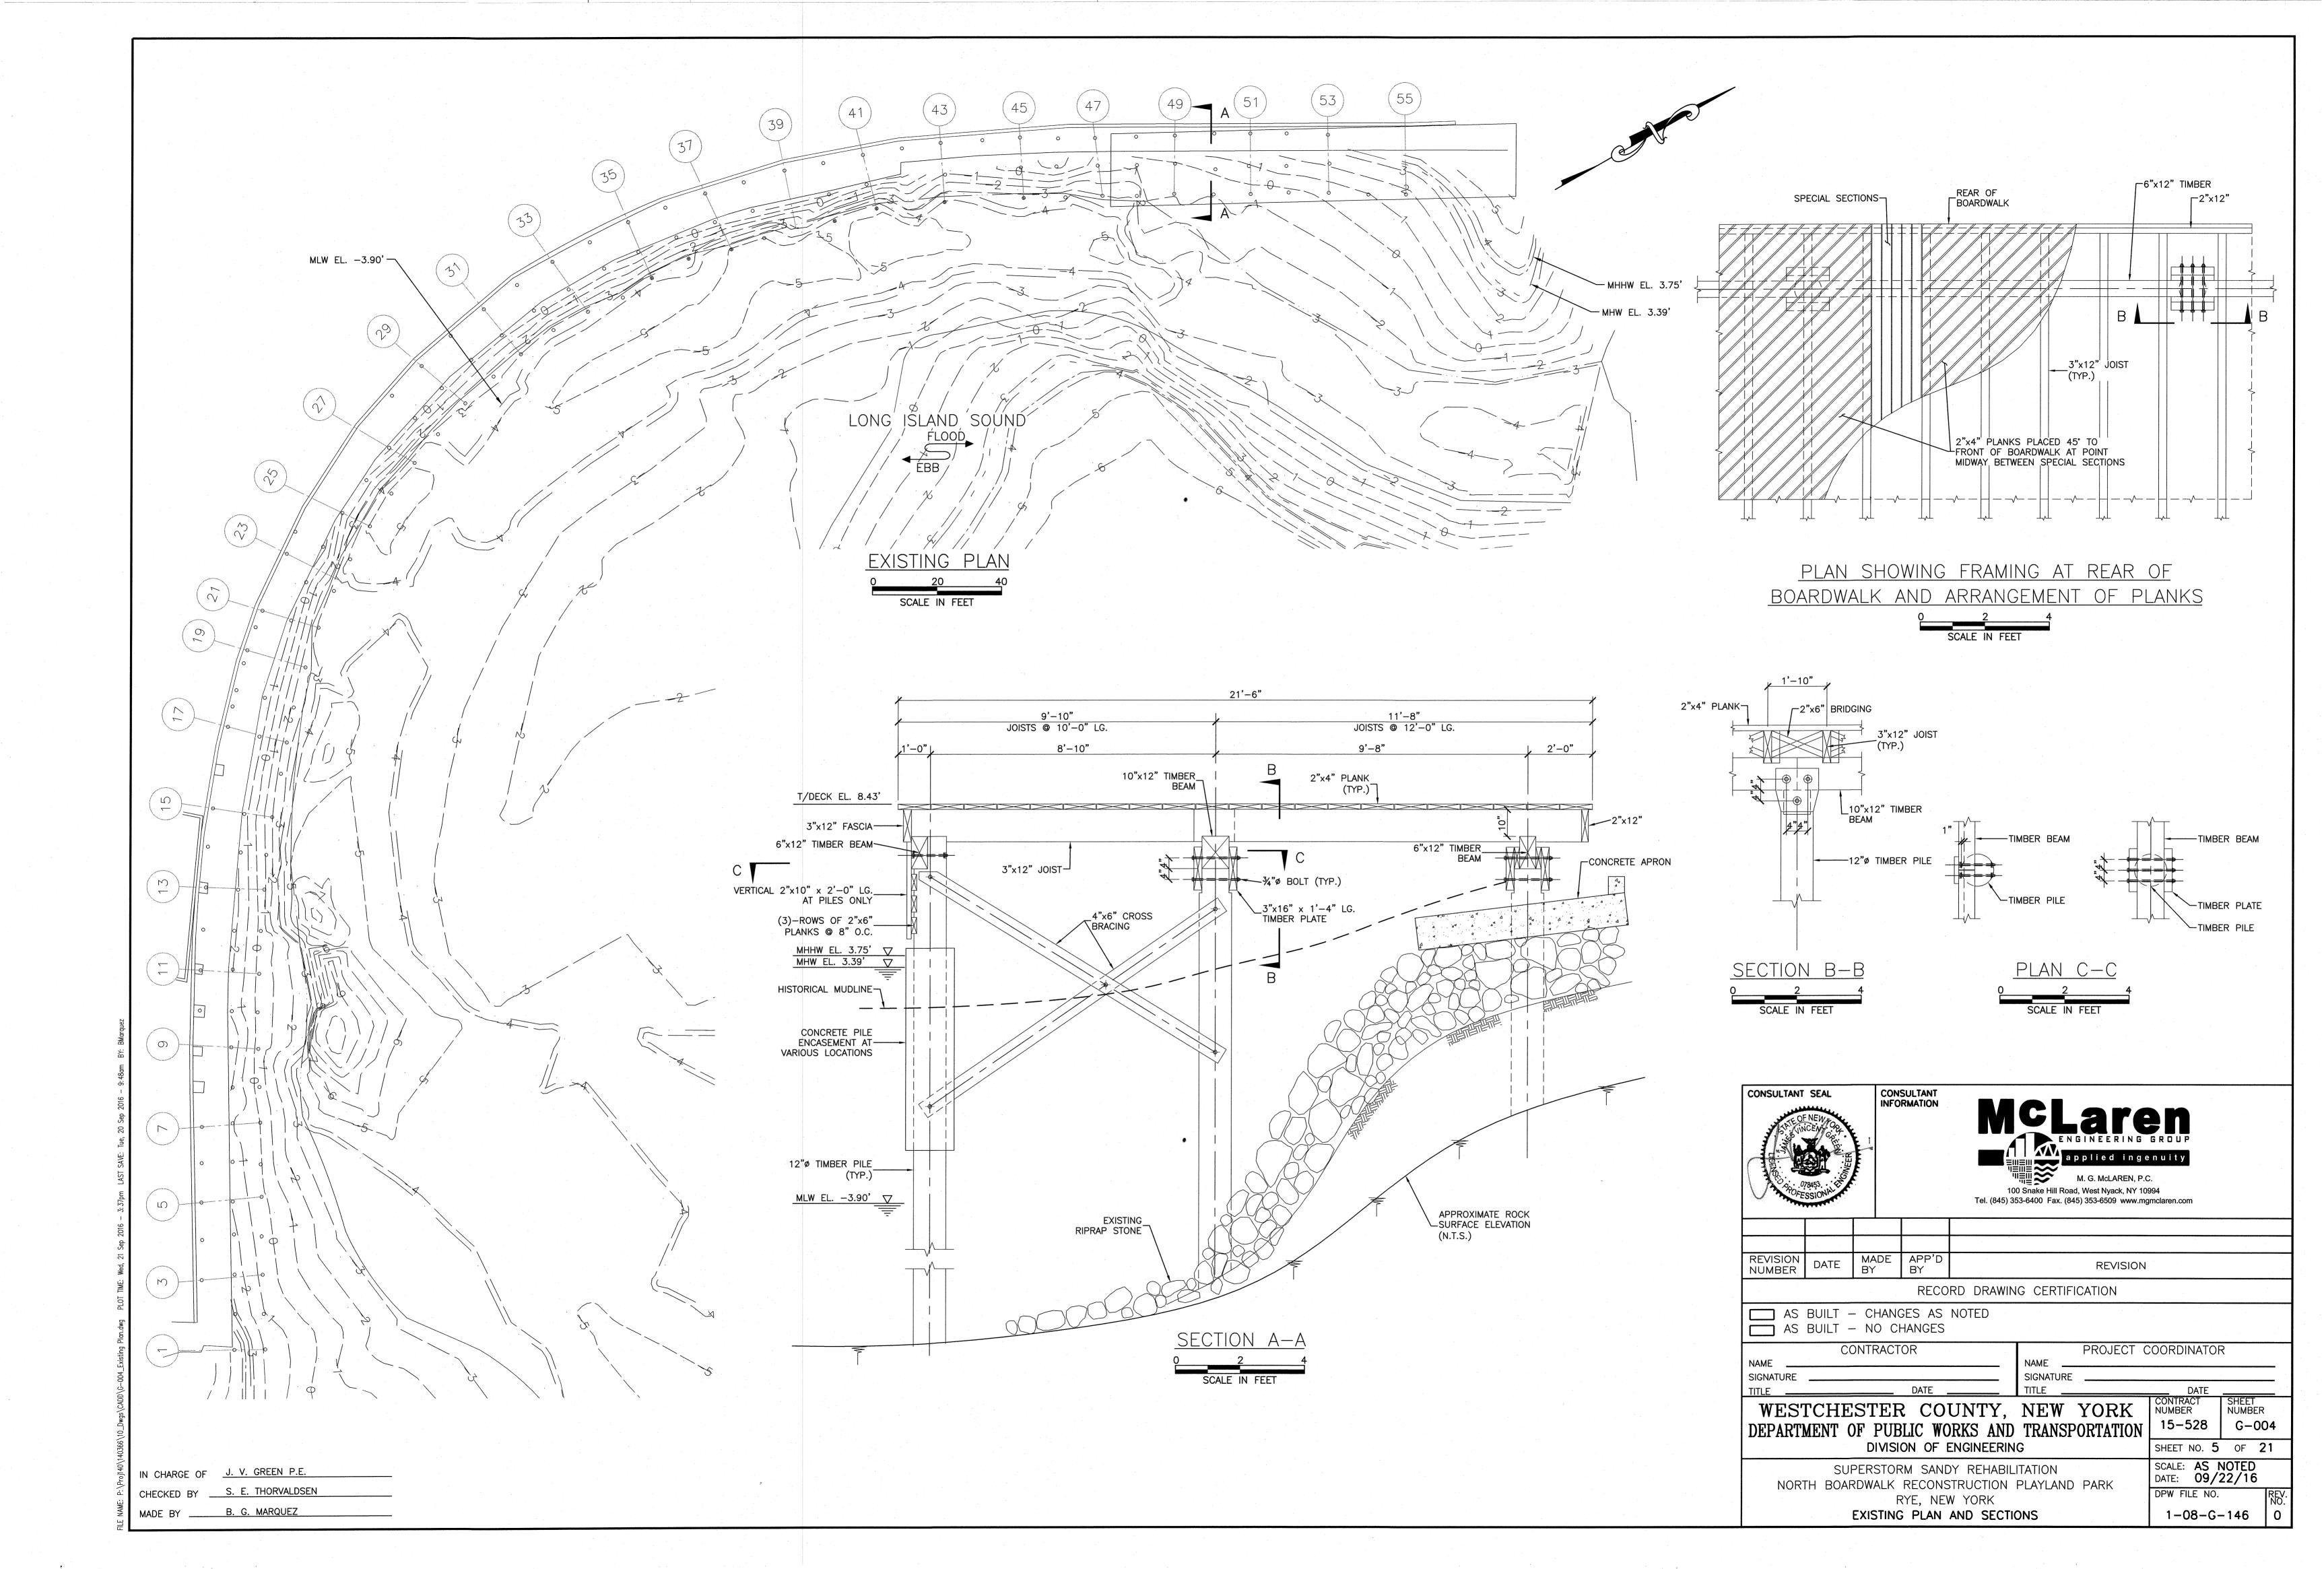


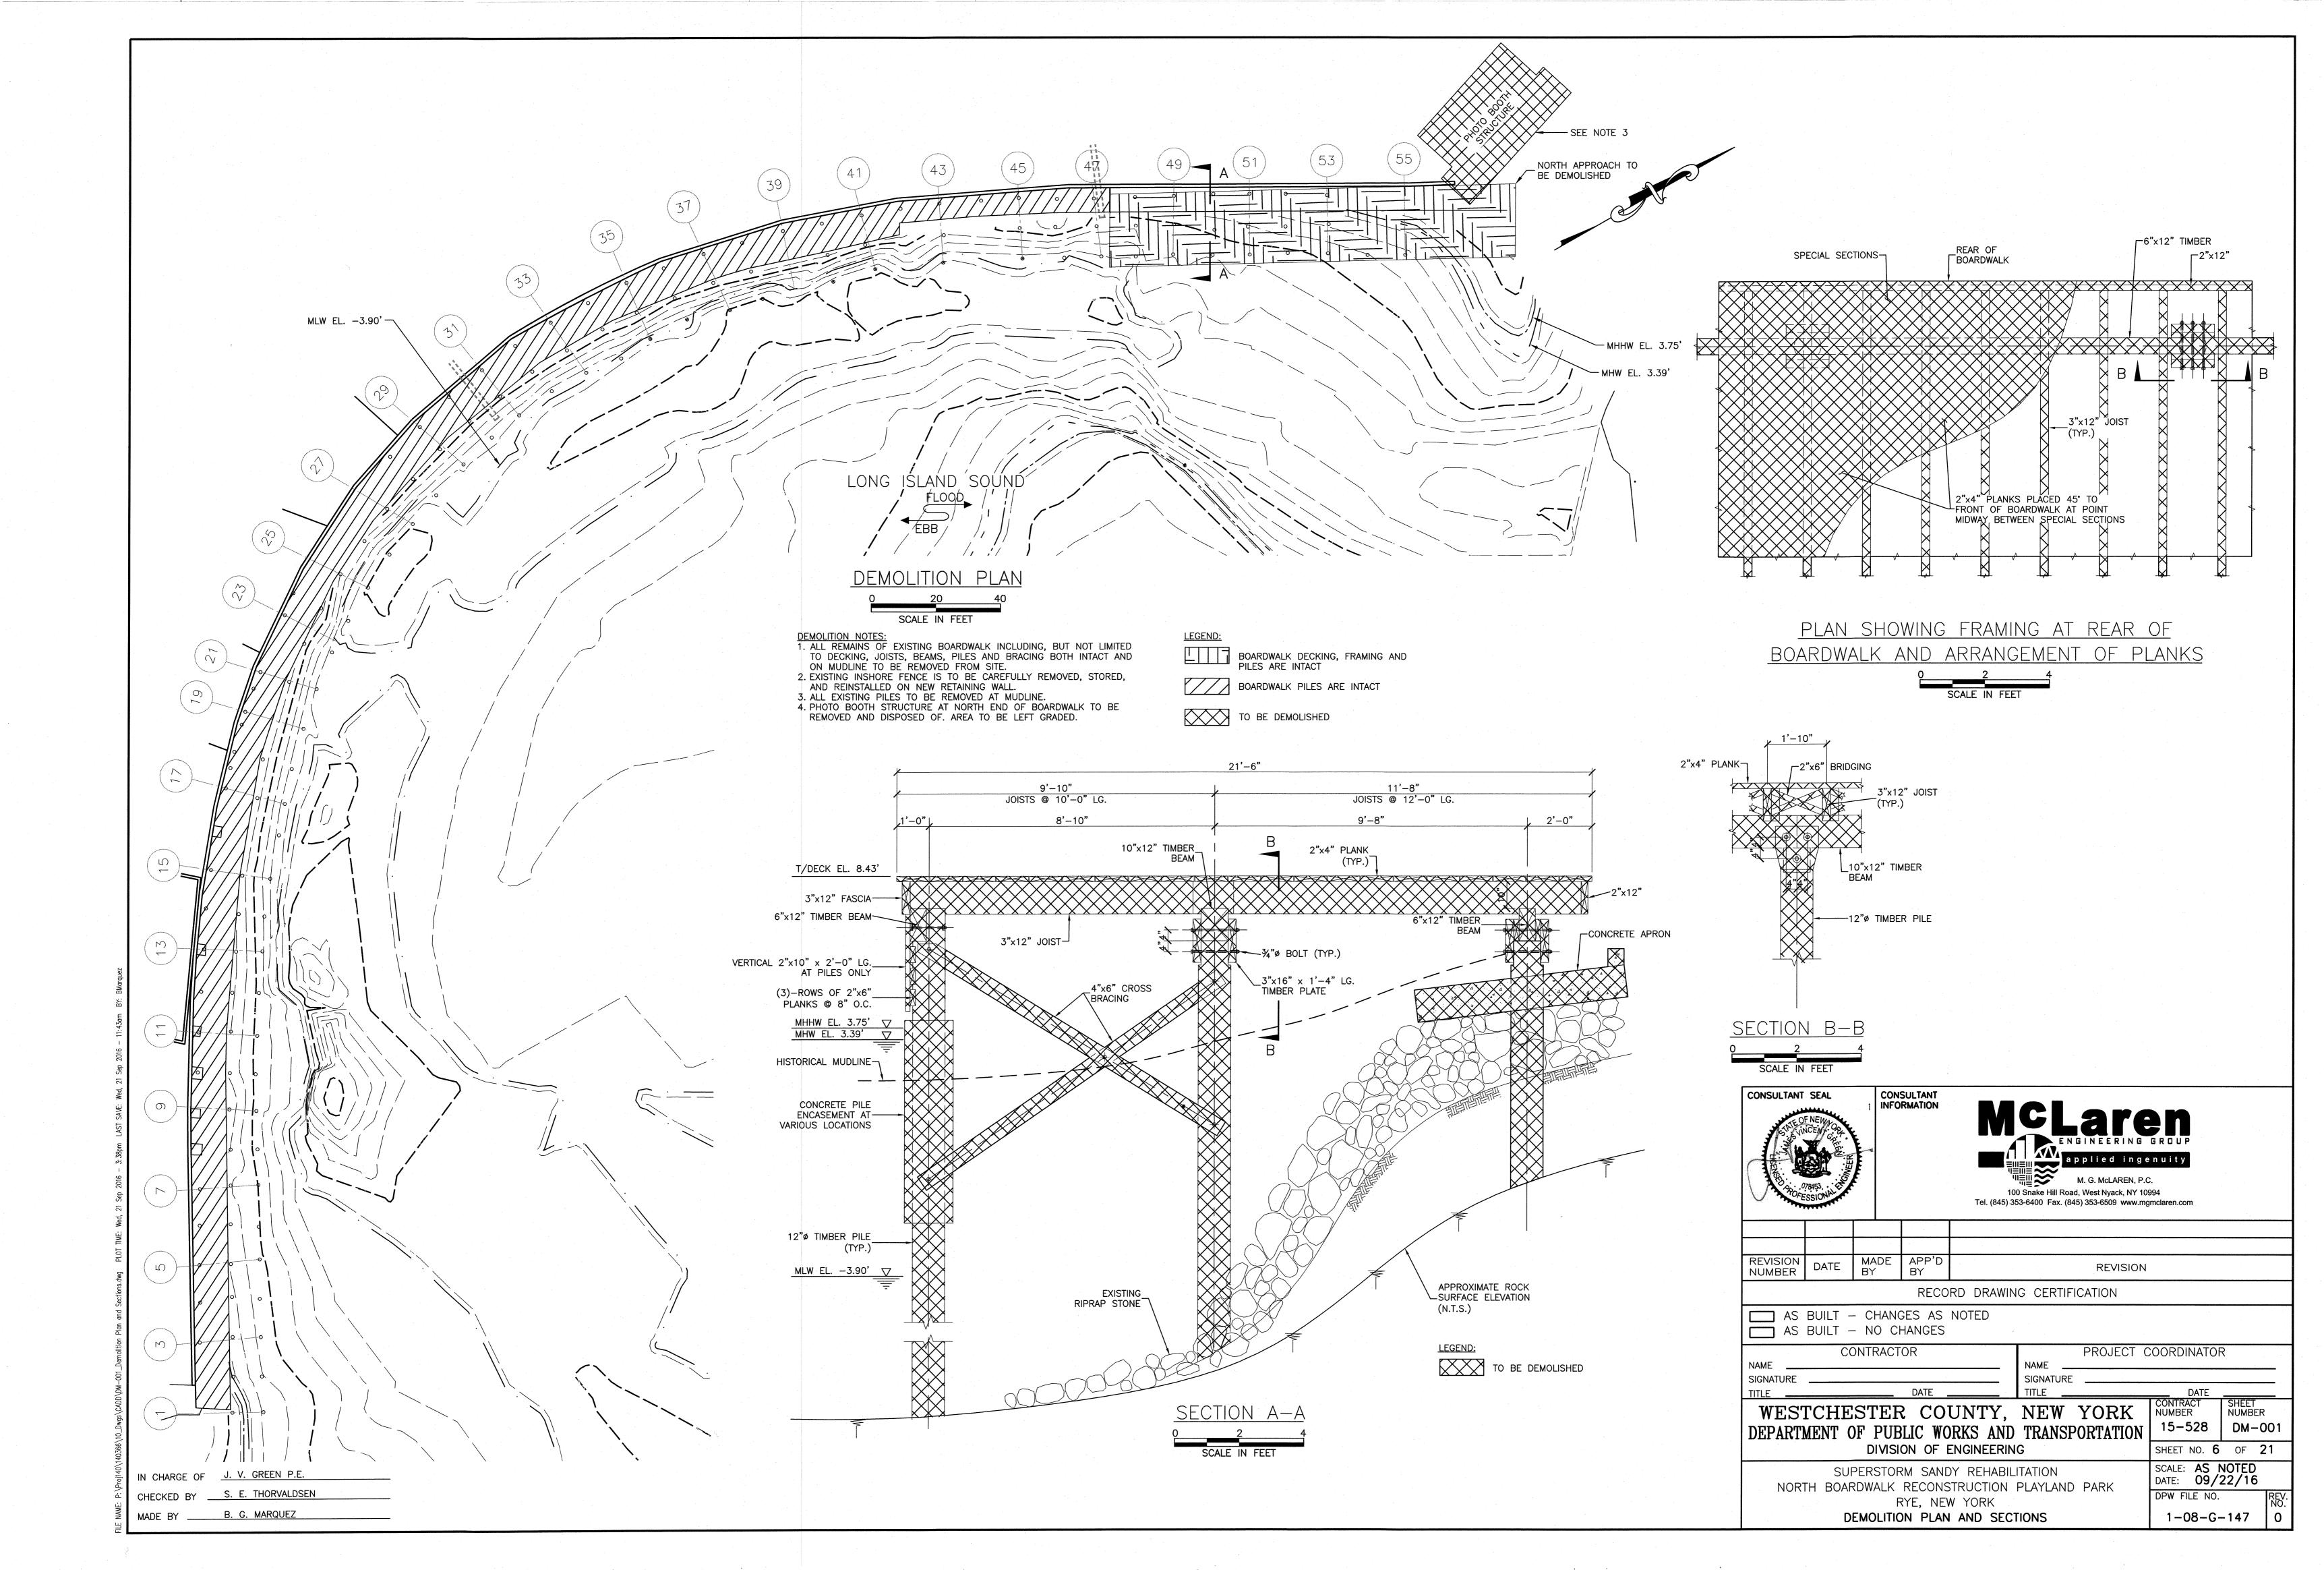


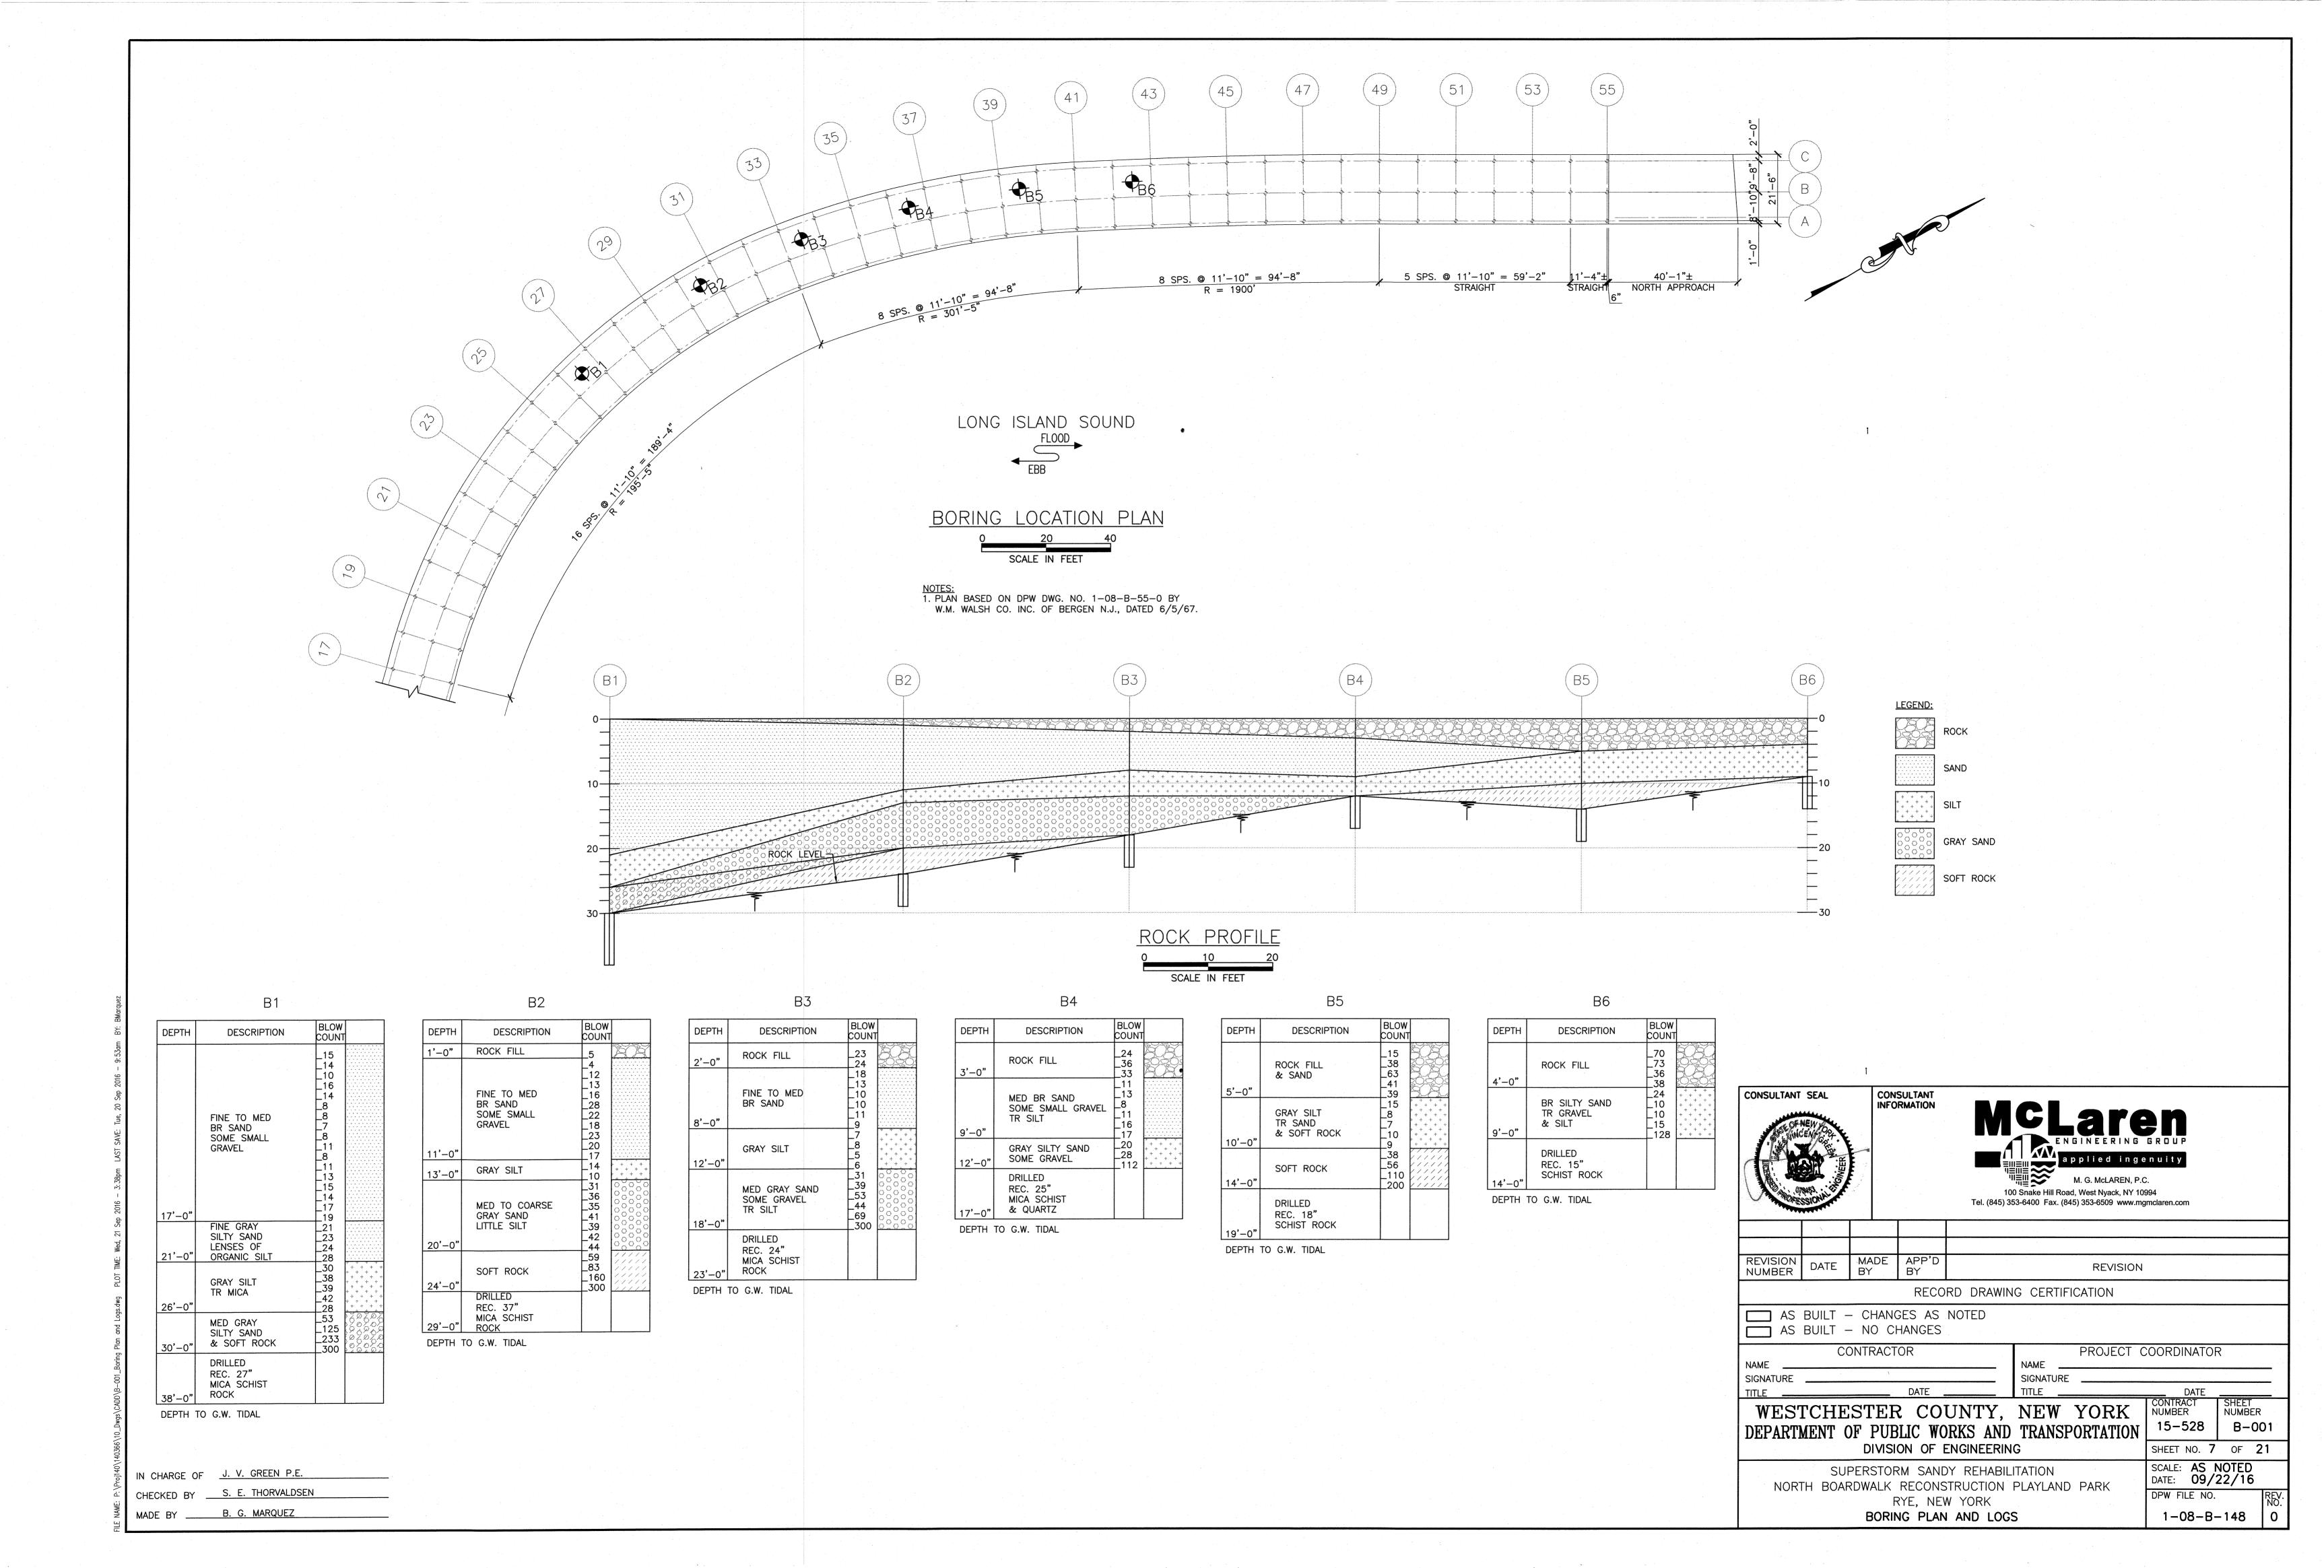


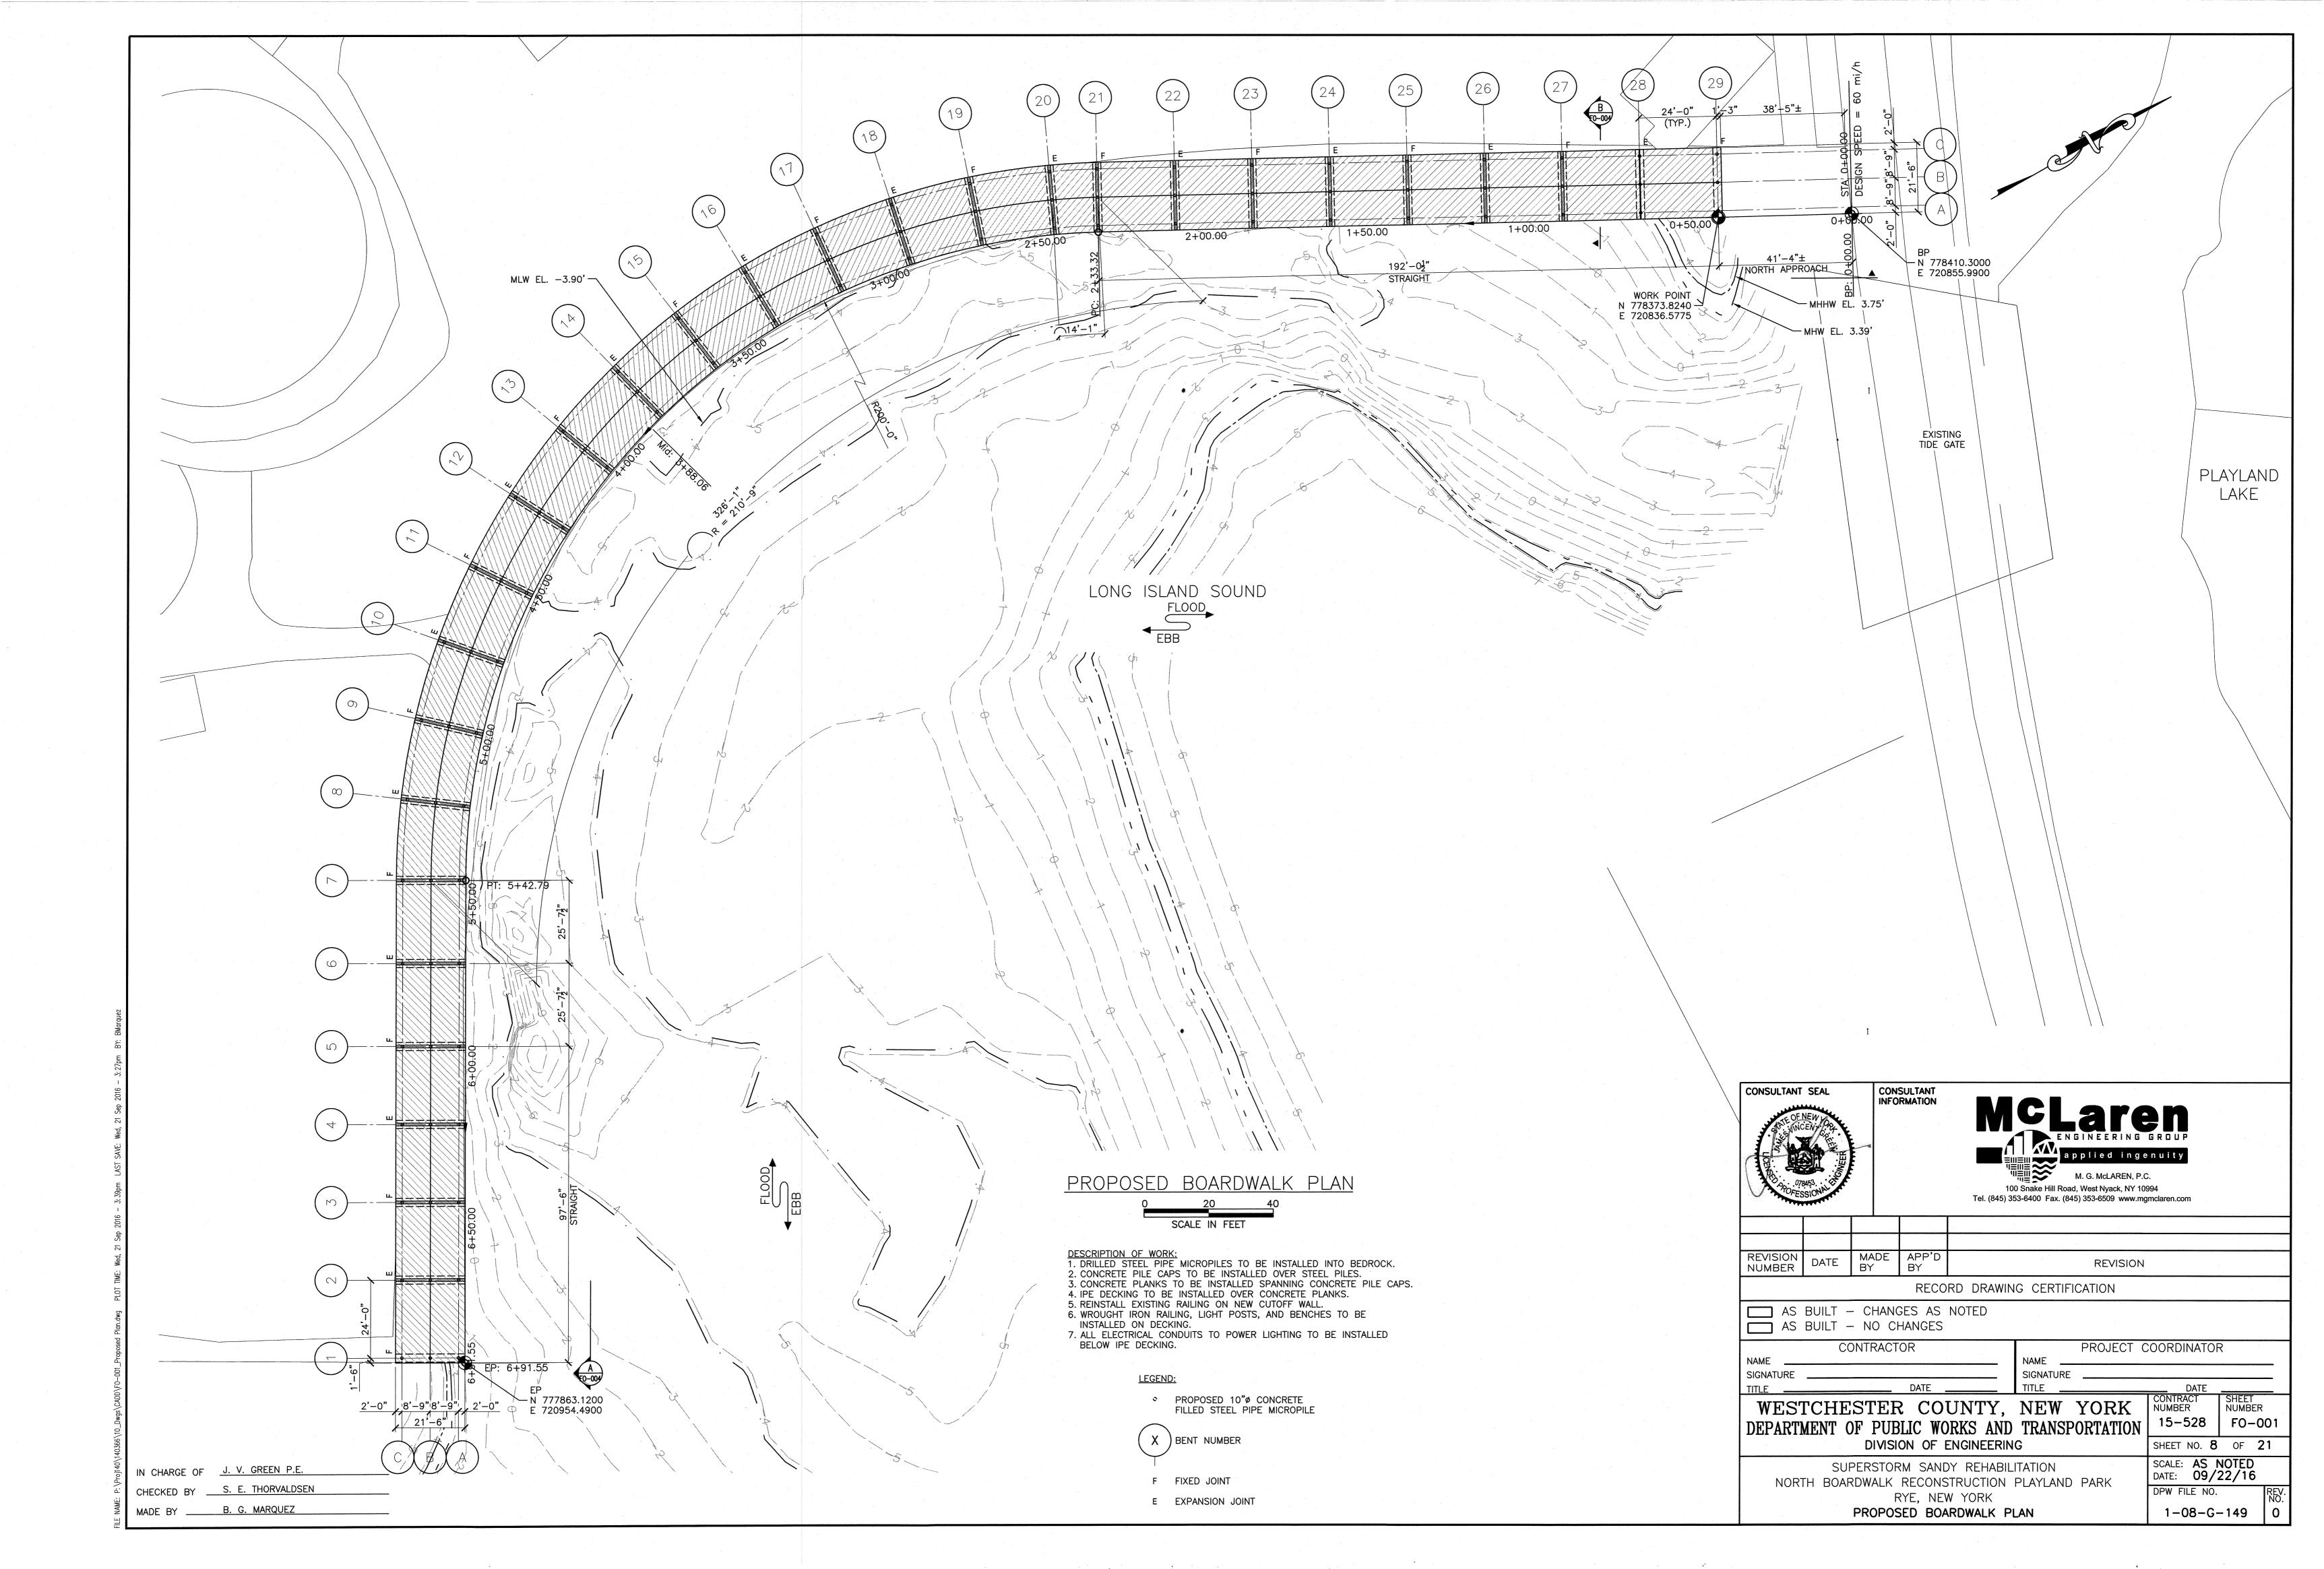

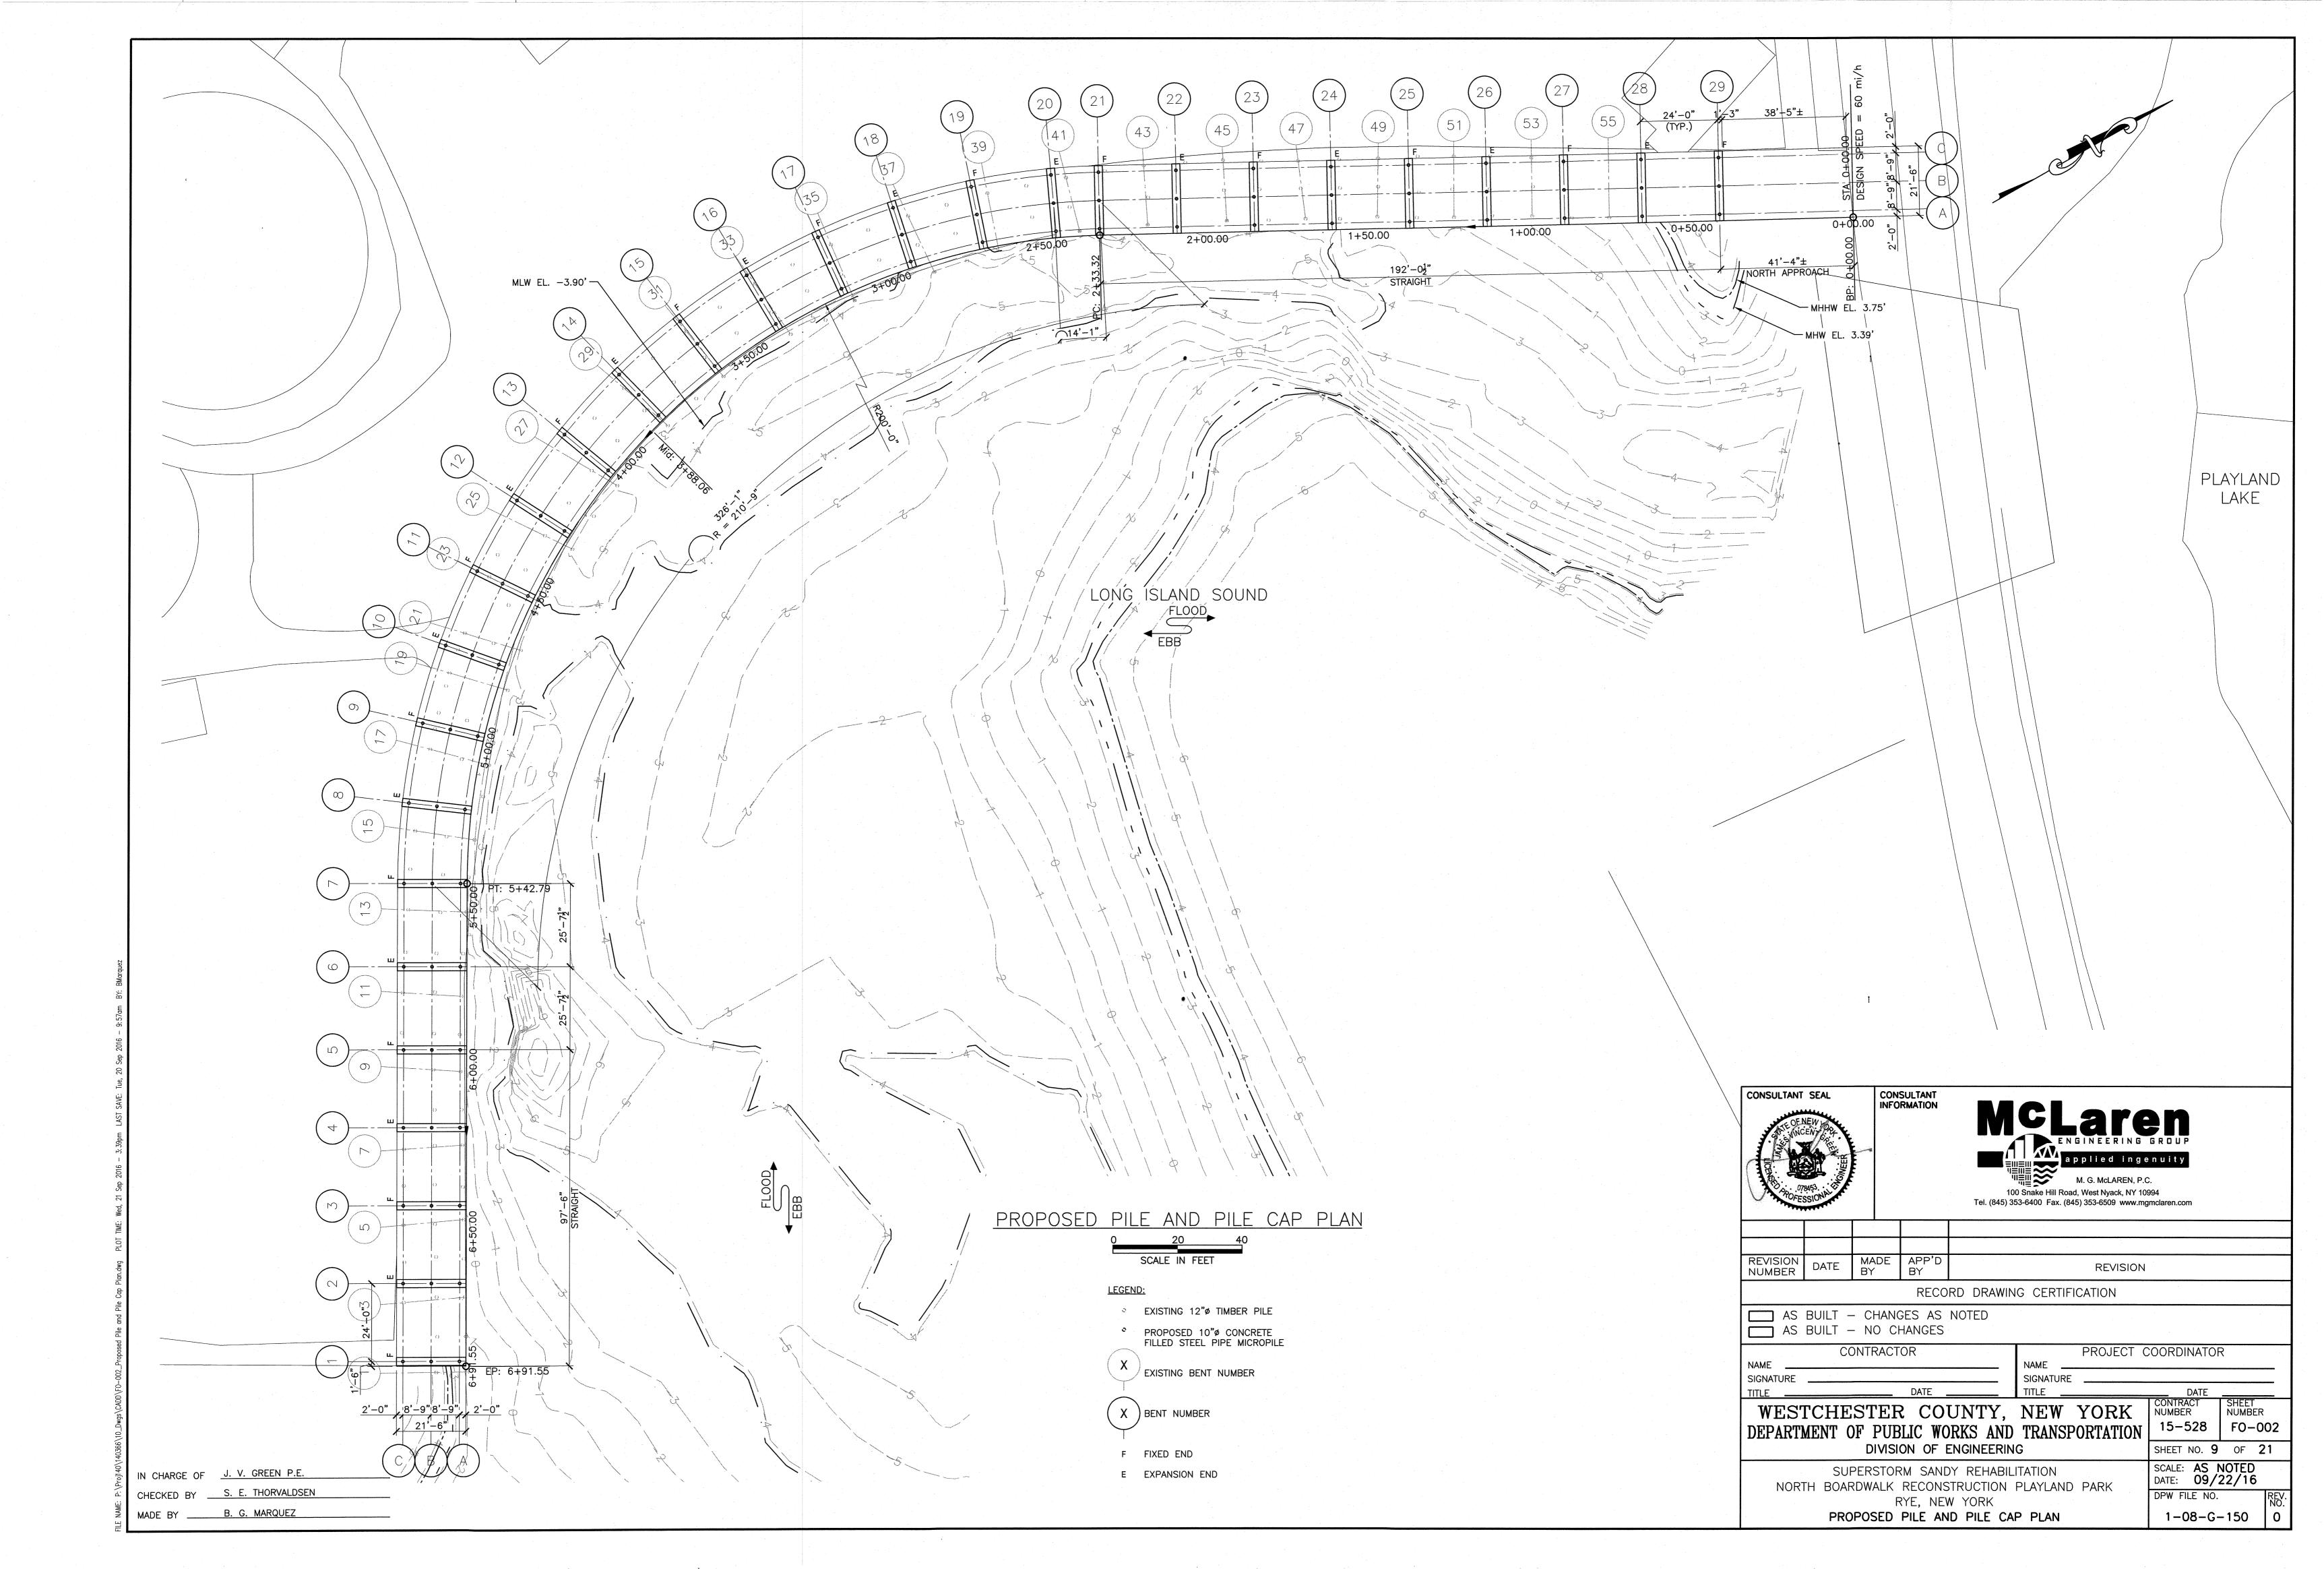

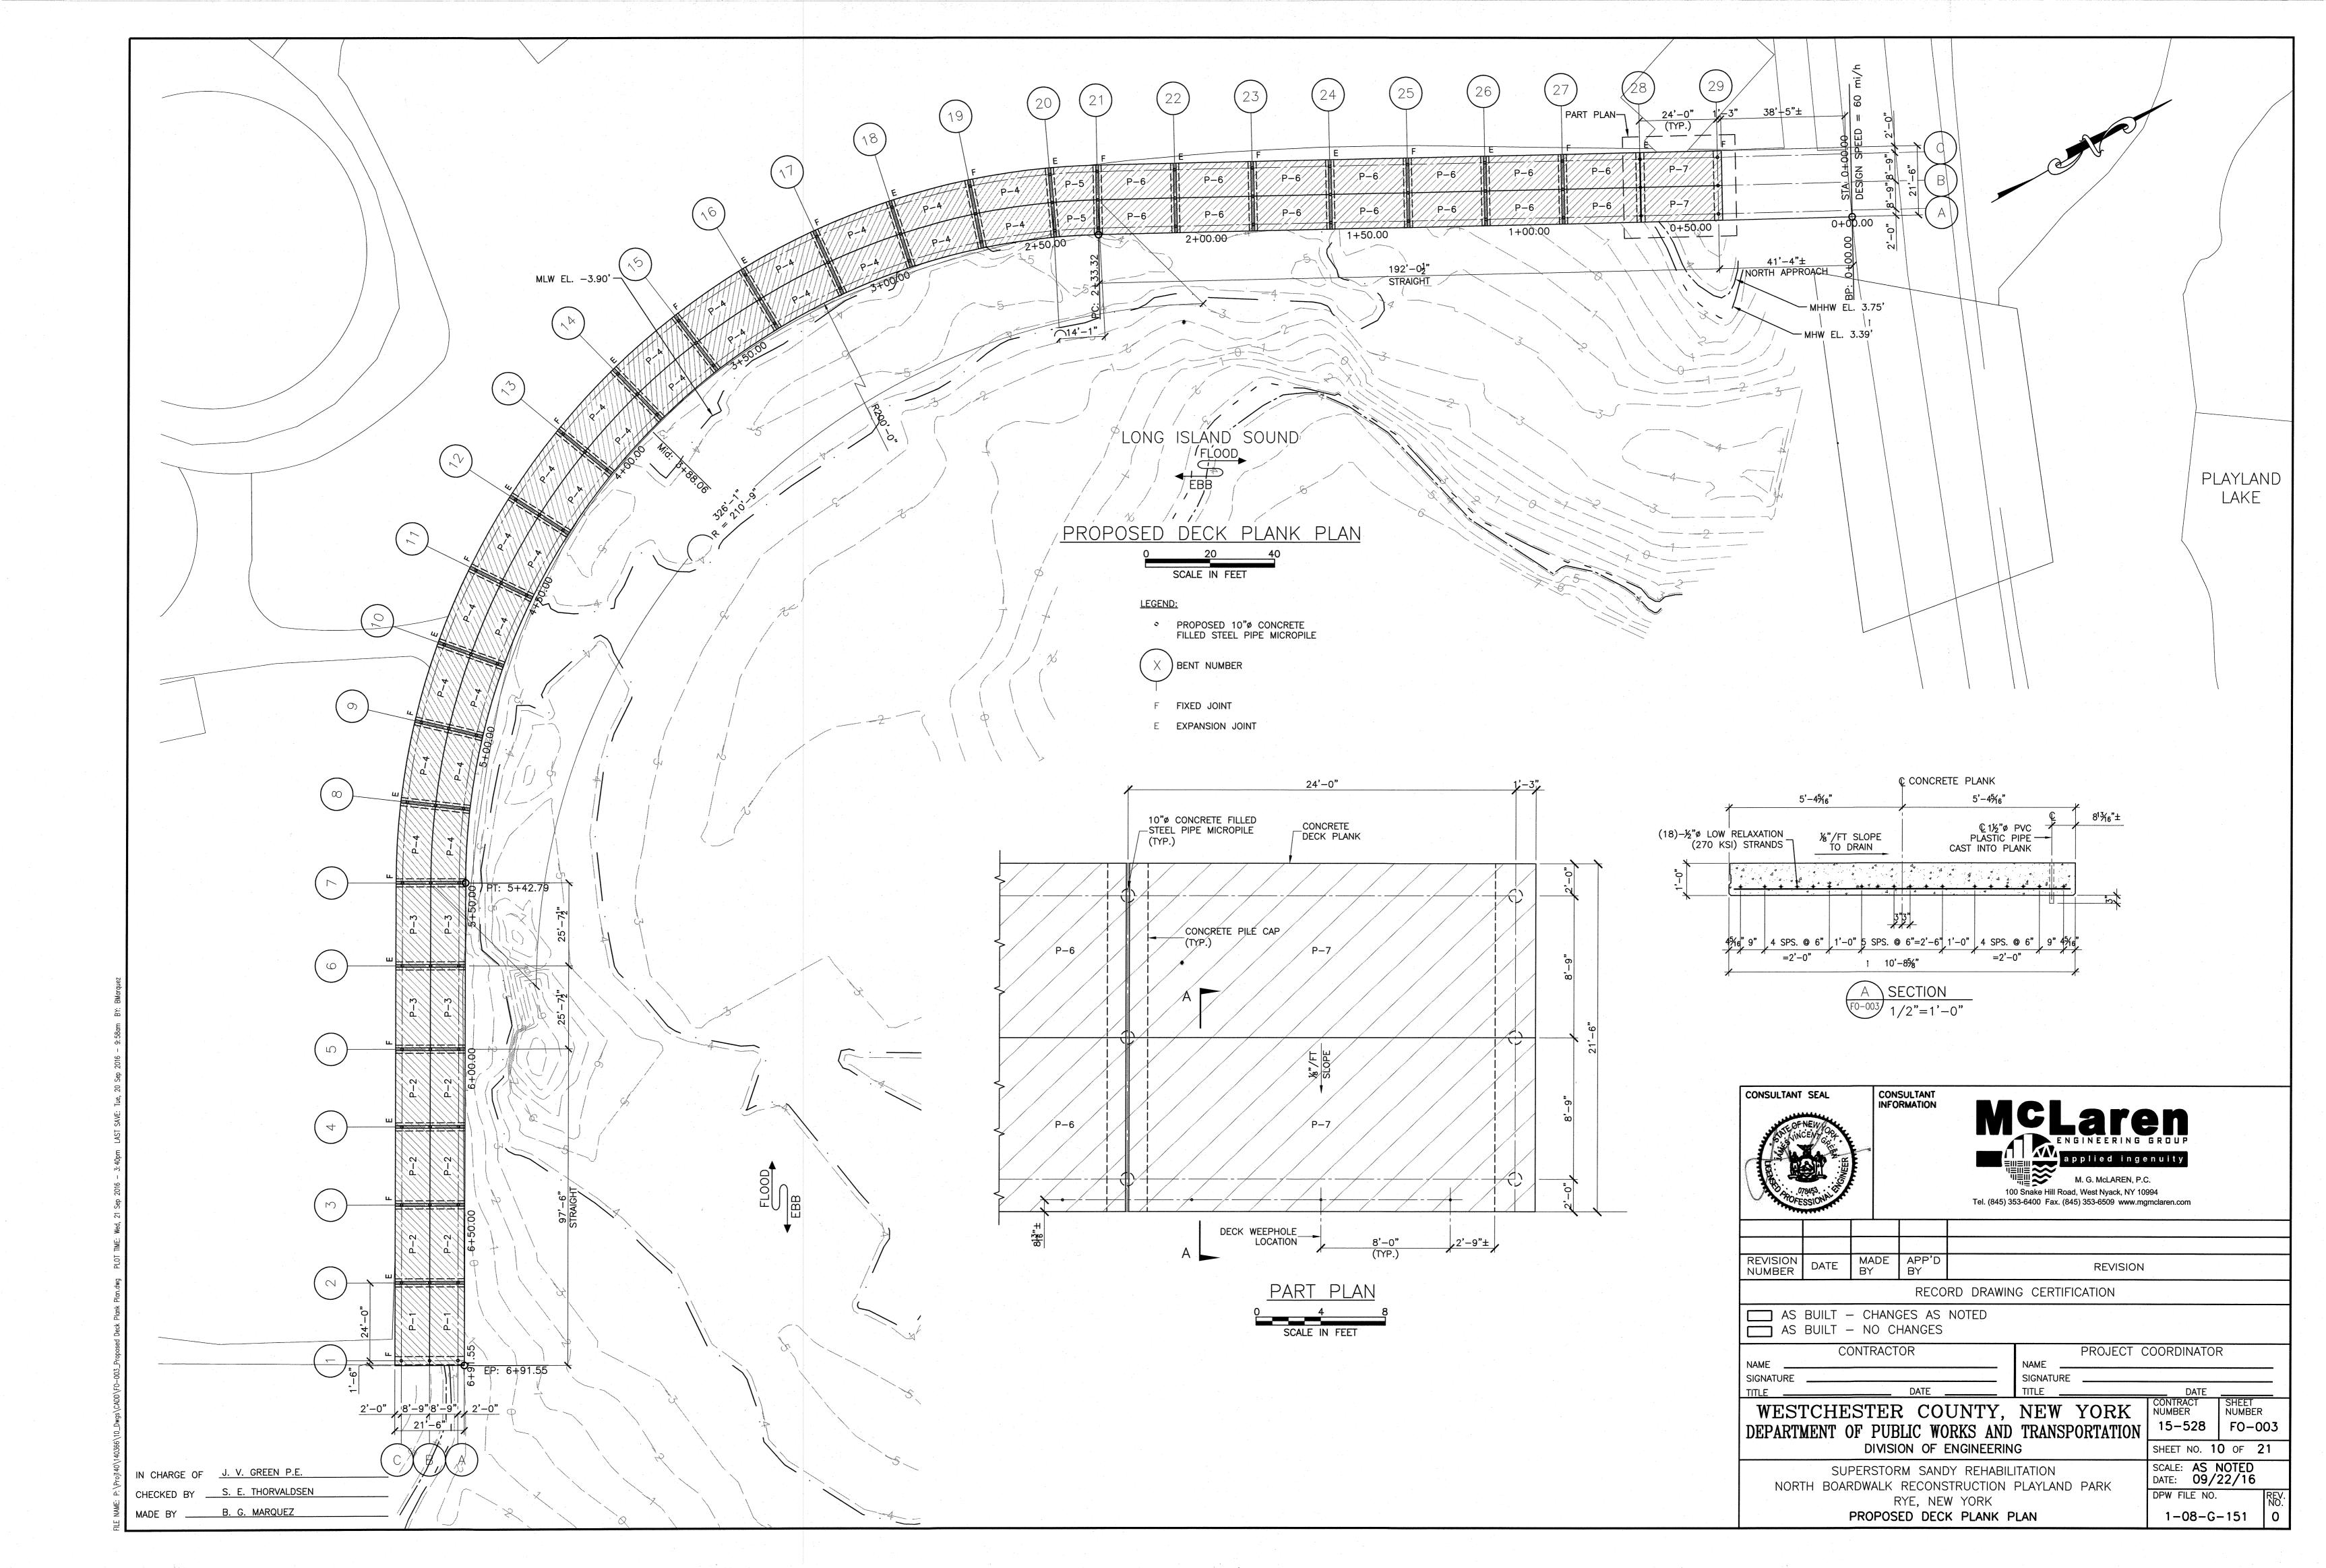


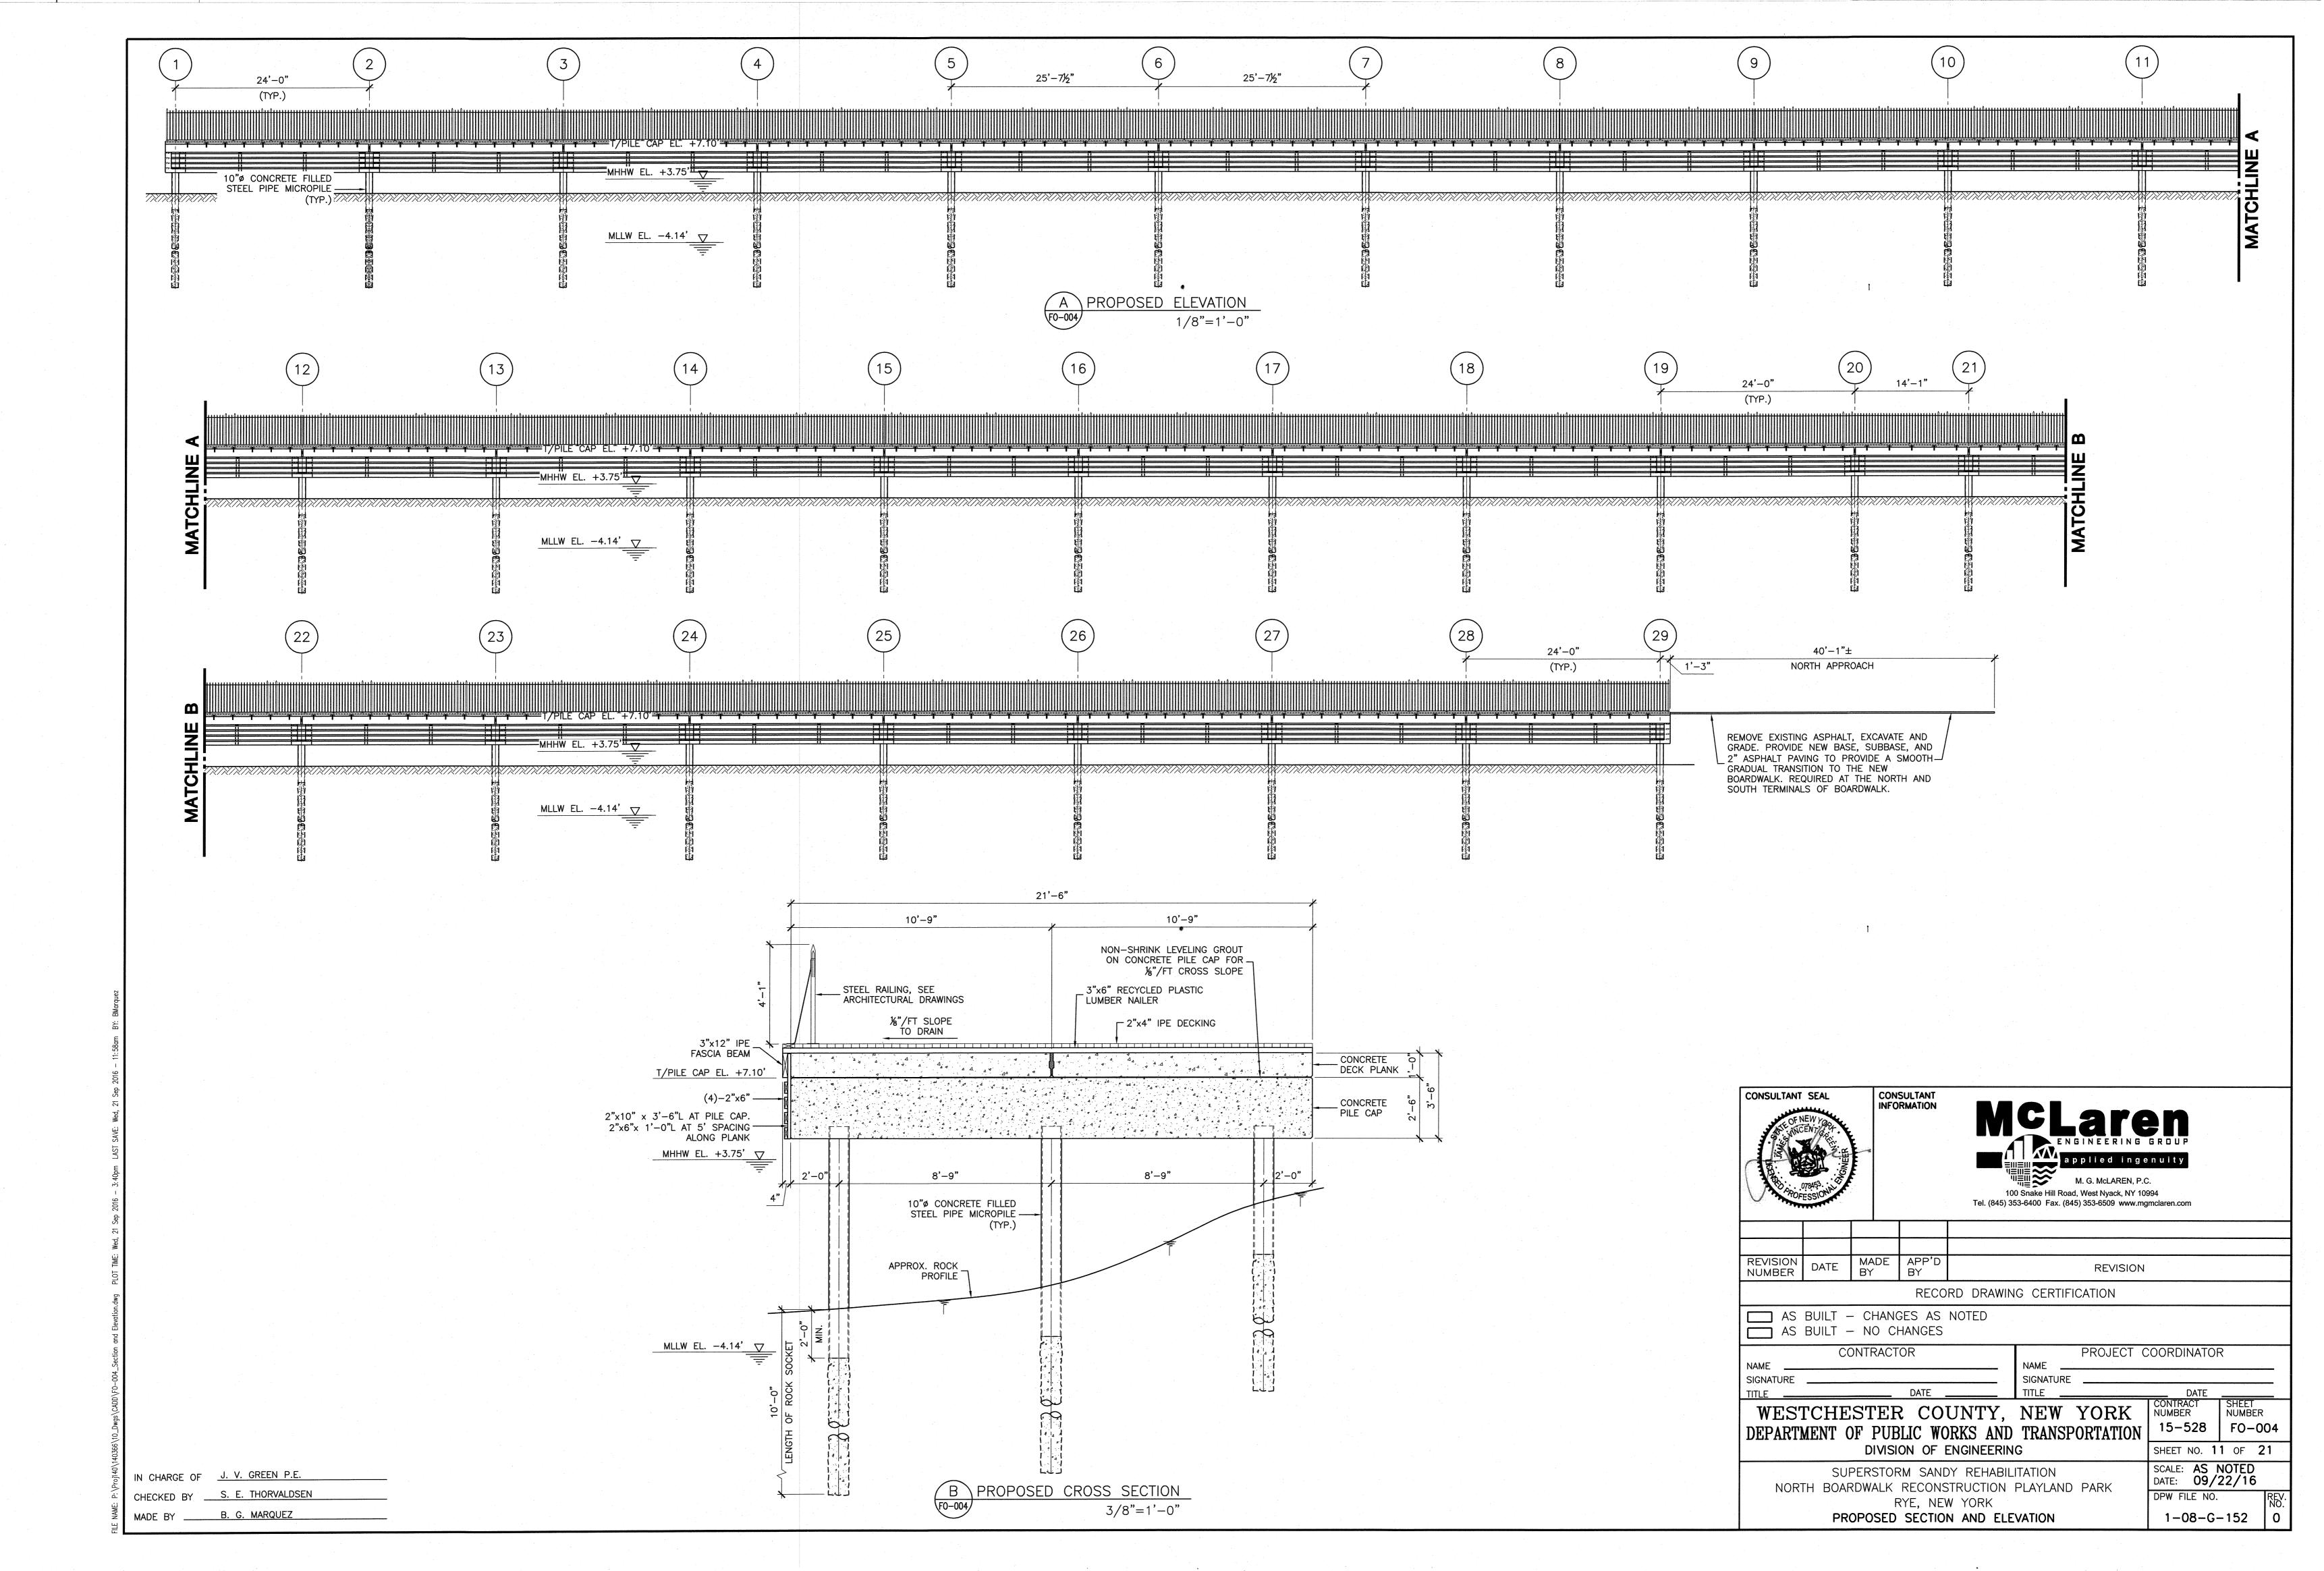


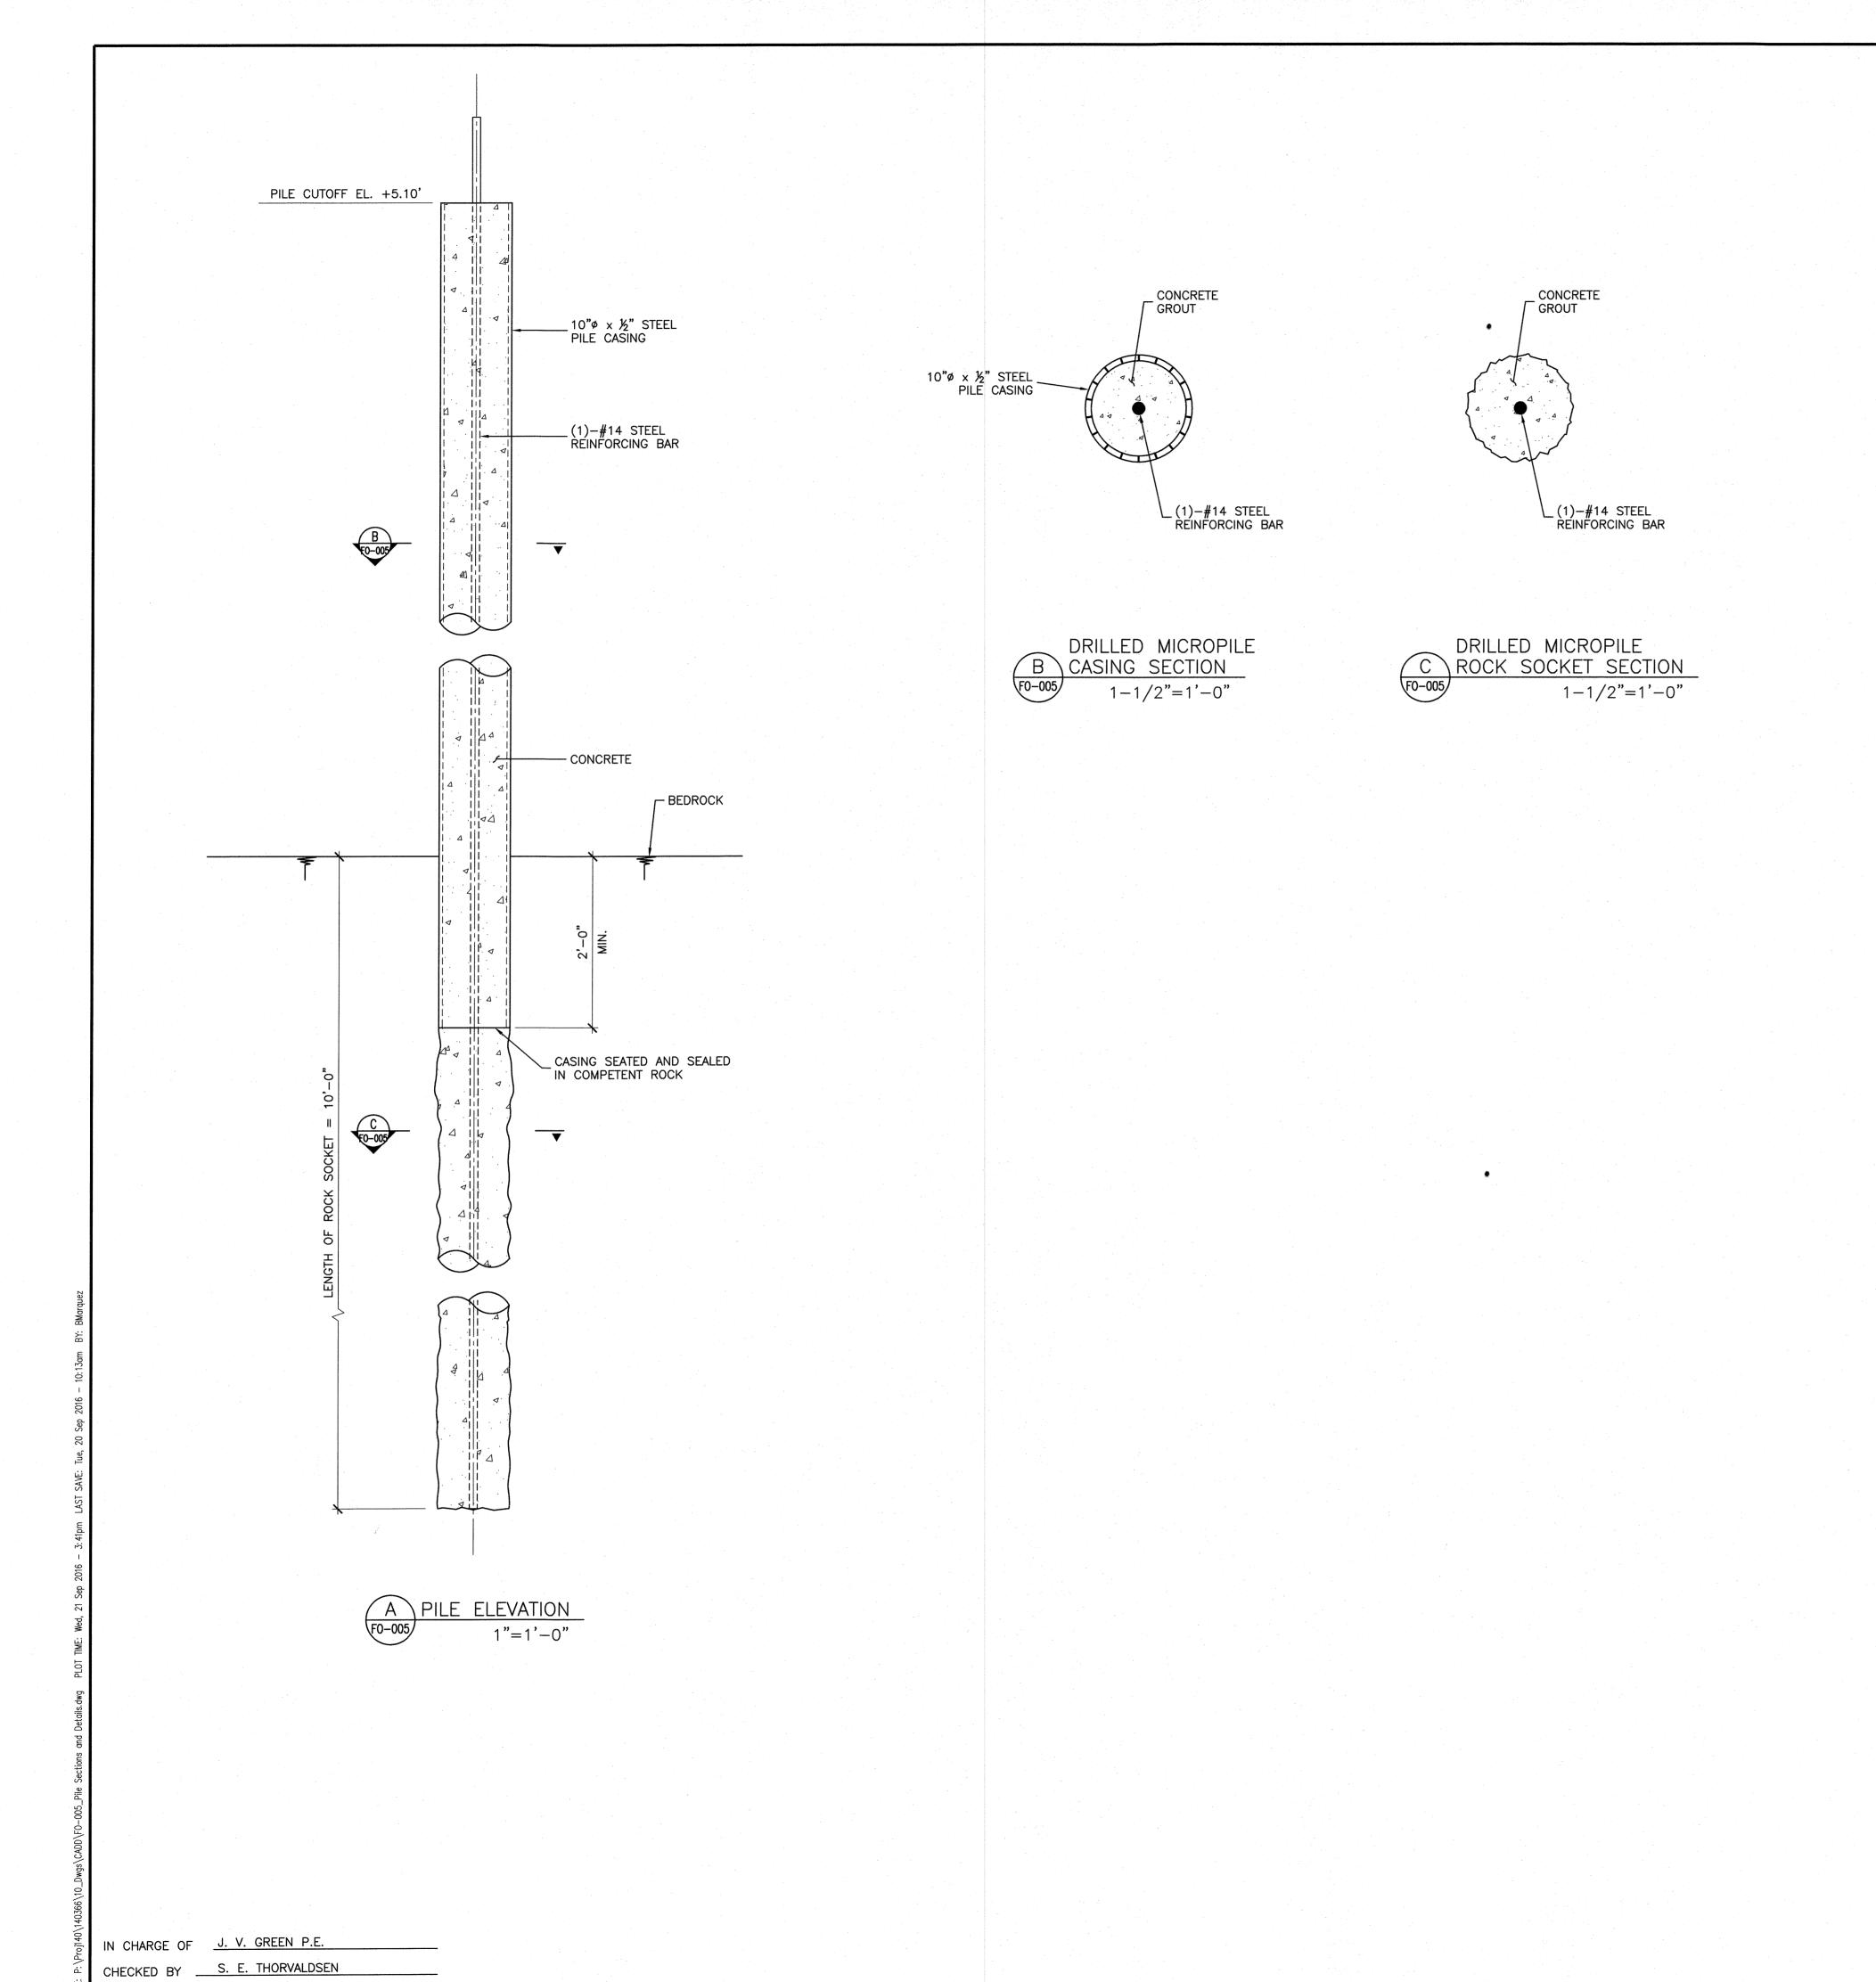



MADE BY B. G. MARQUEZ

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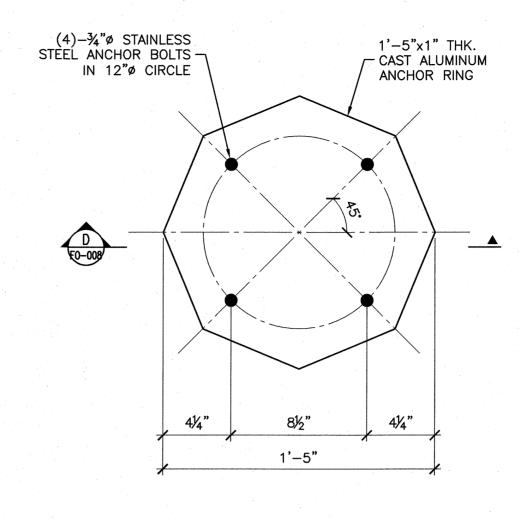


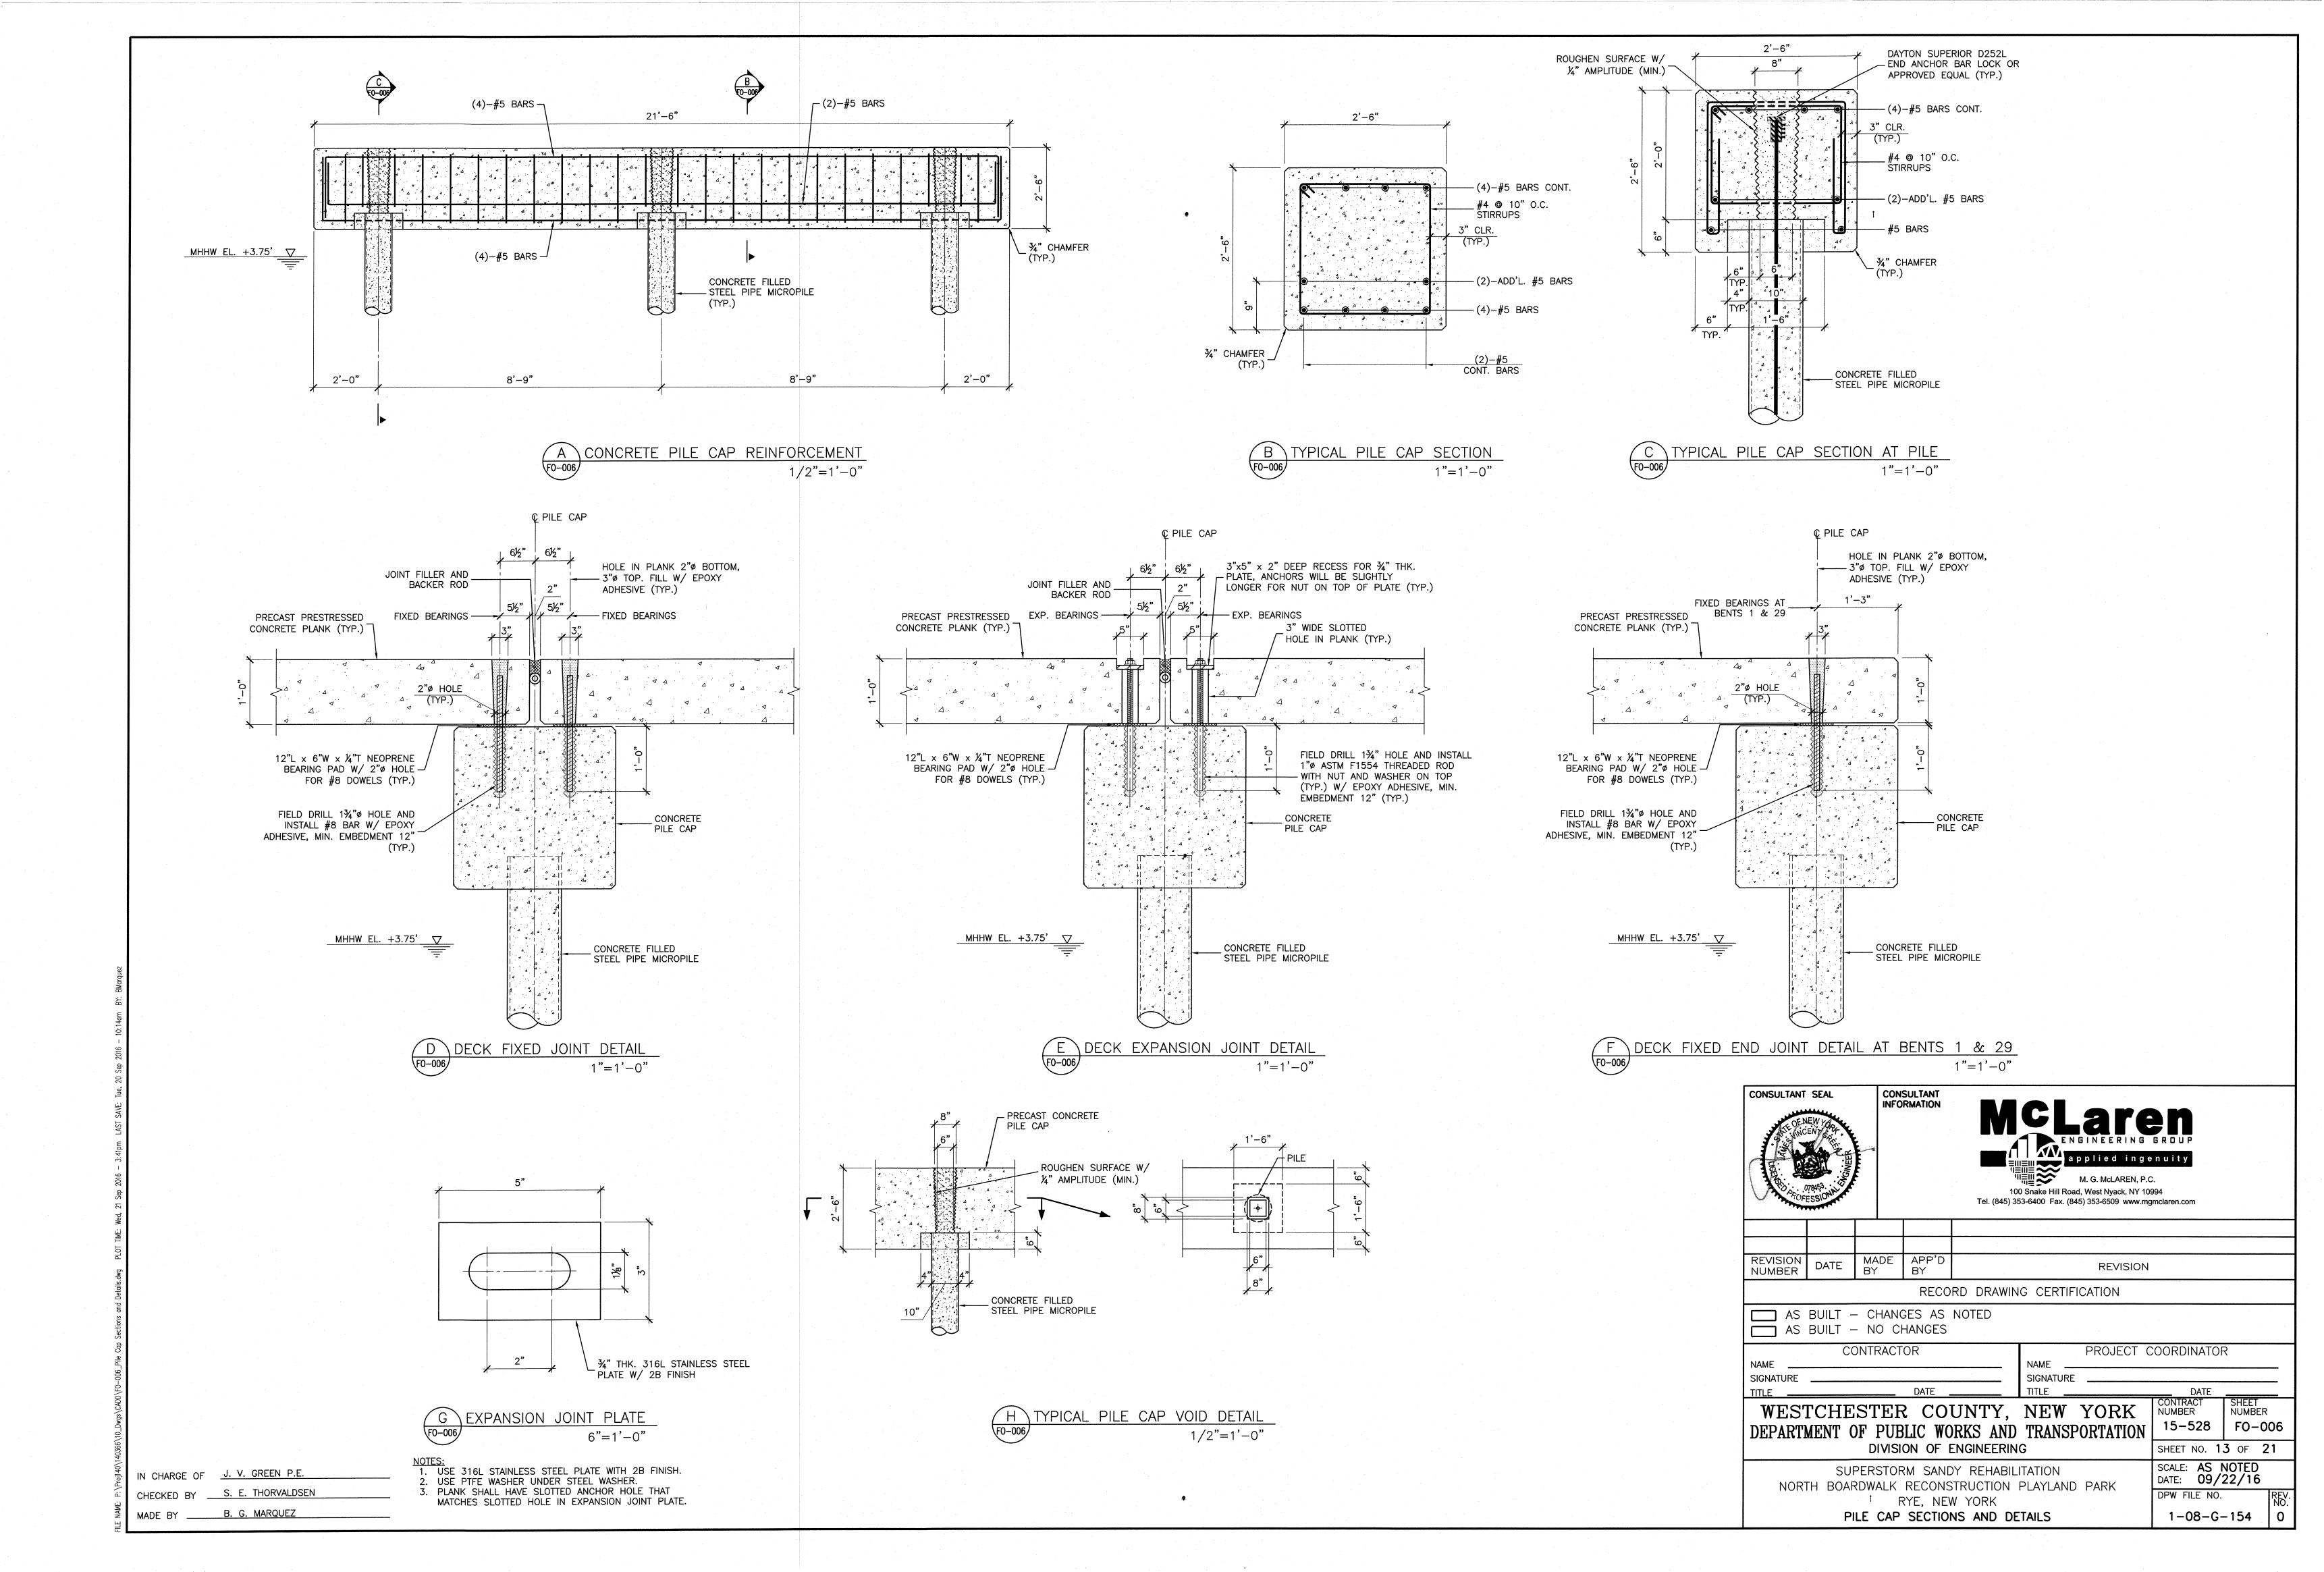

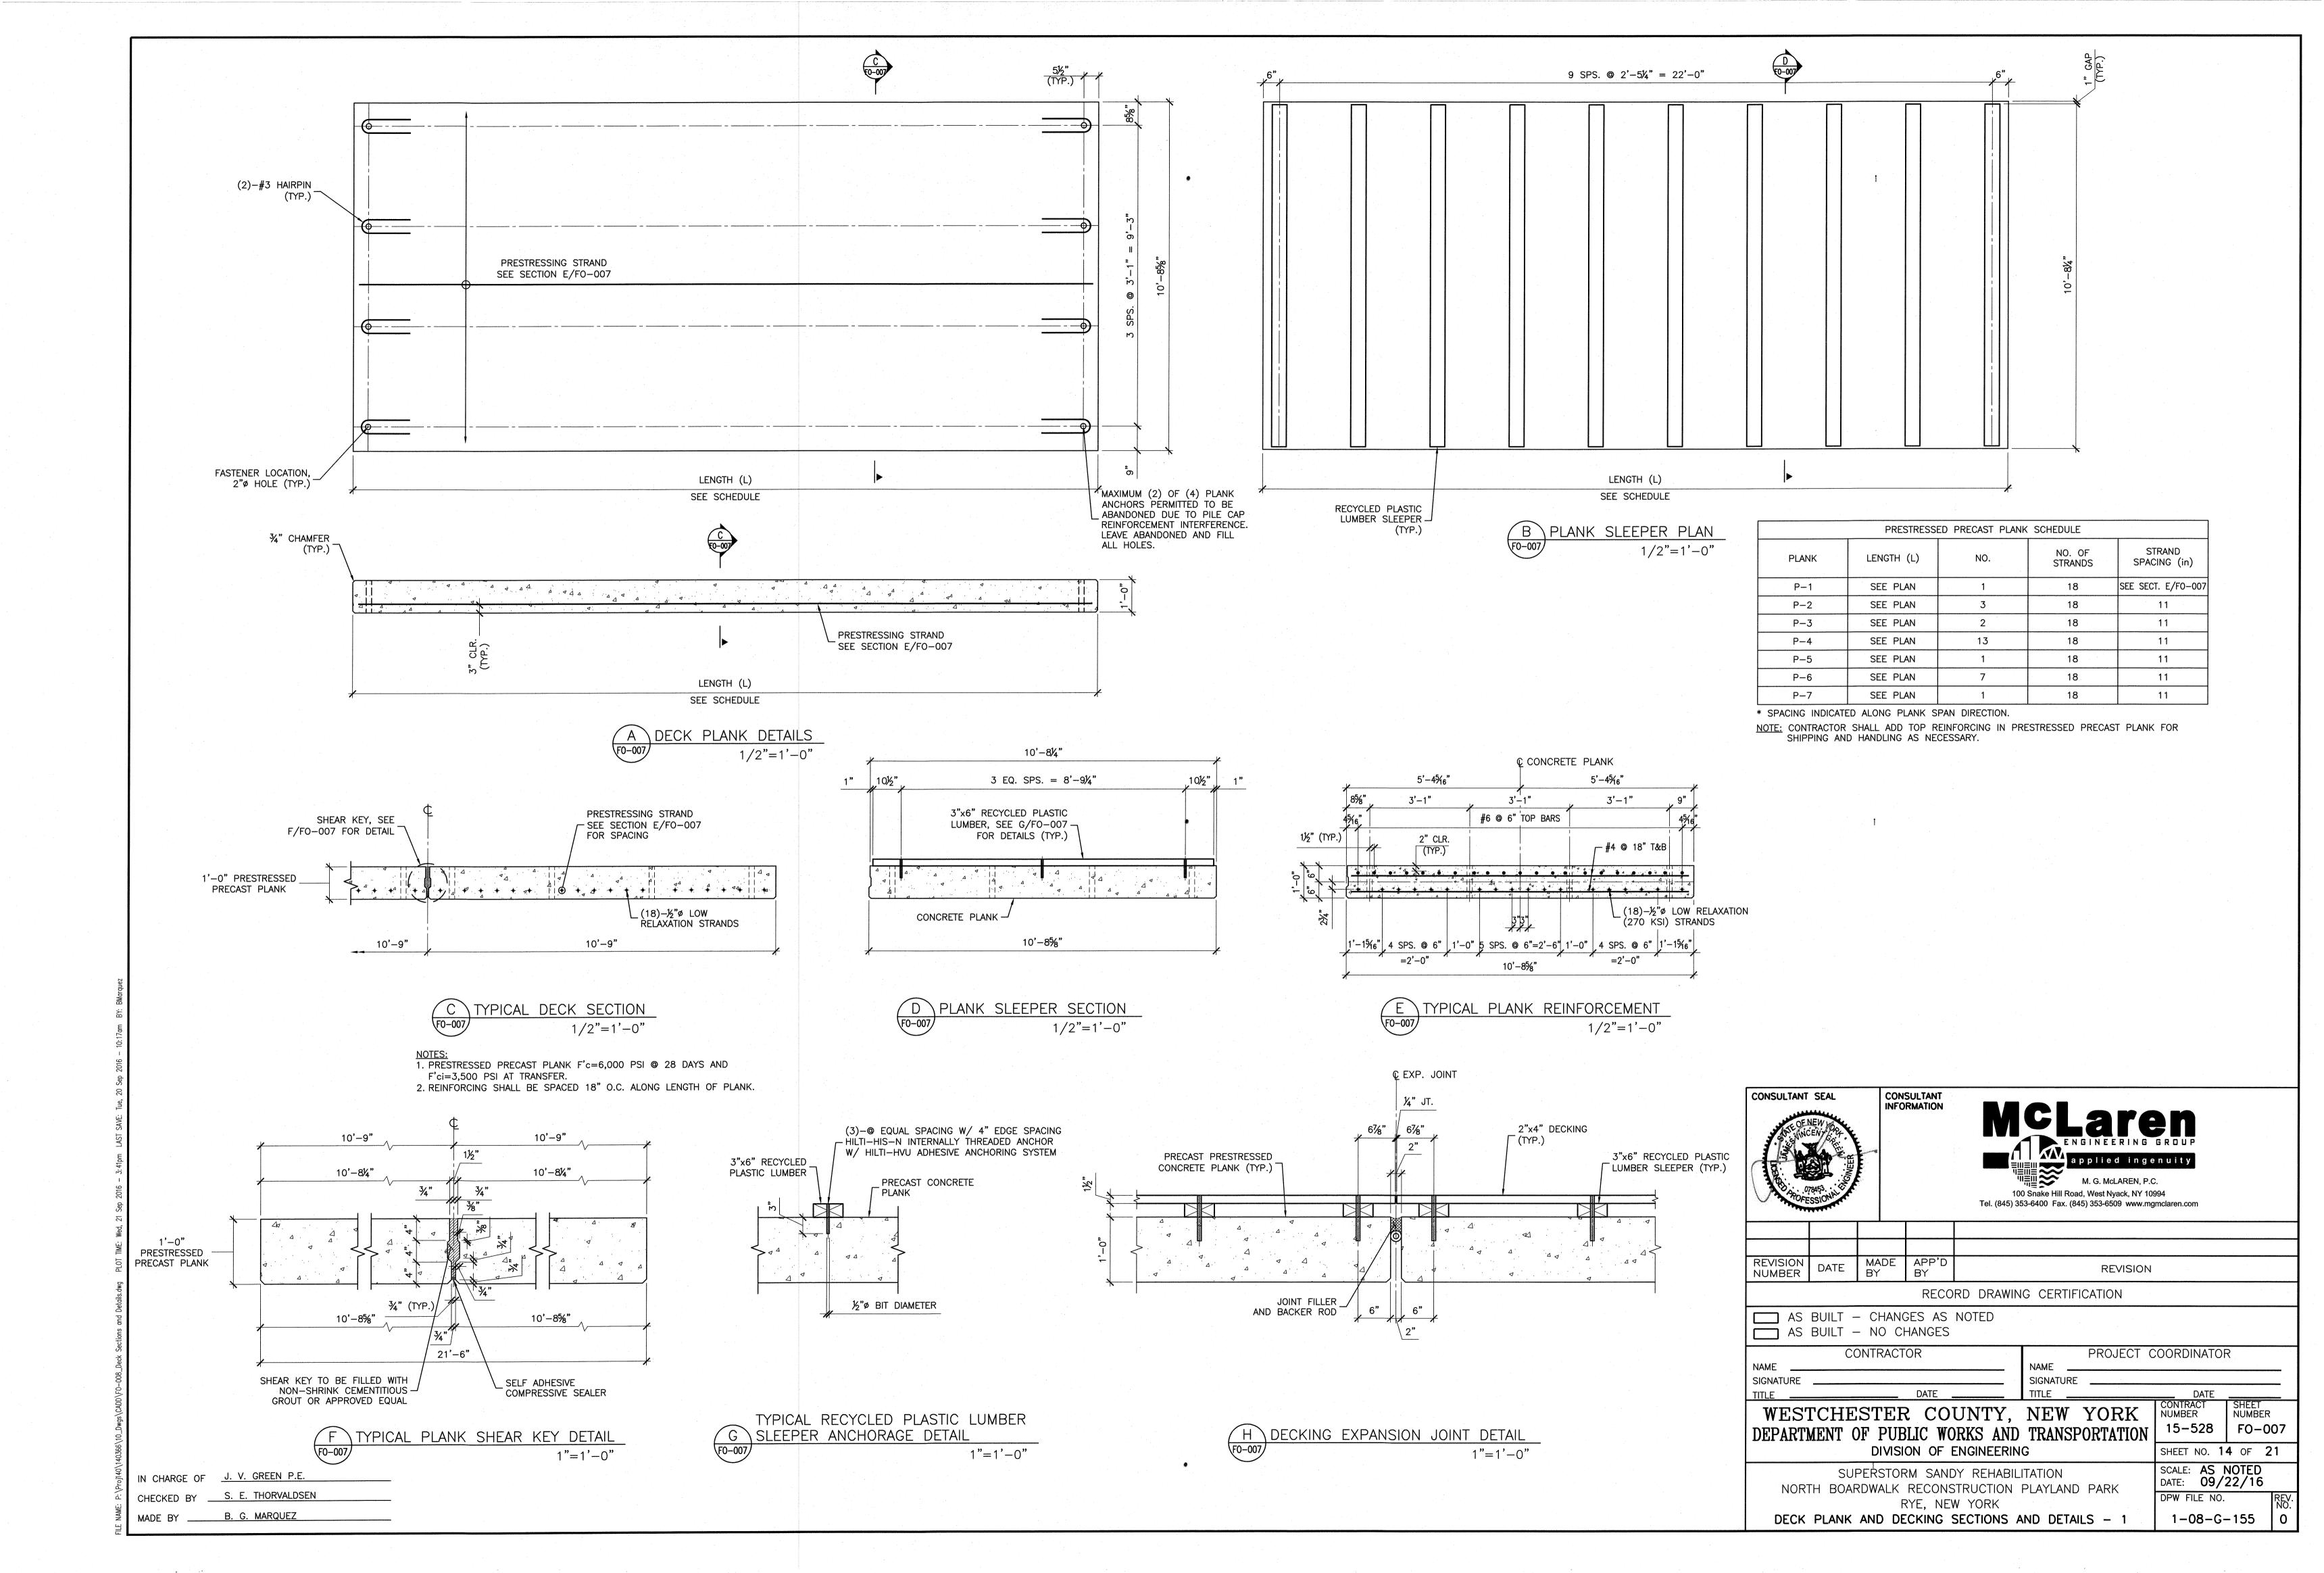

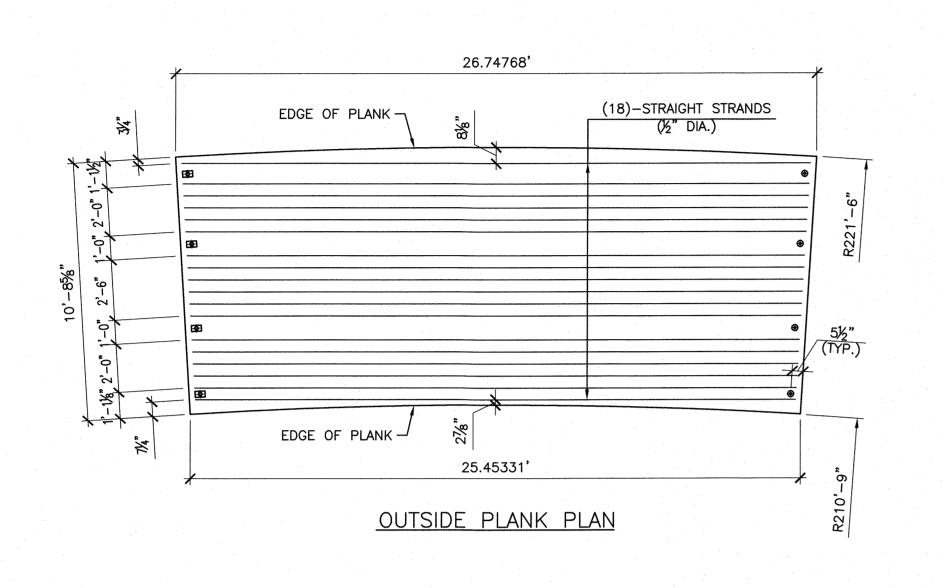
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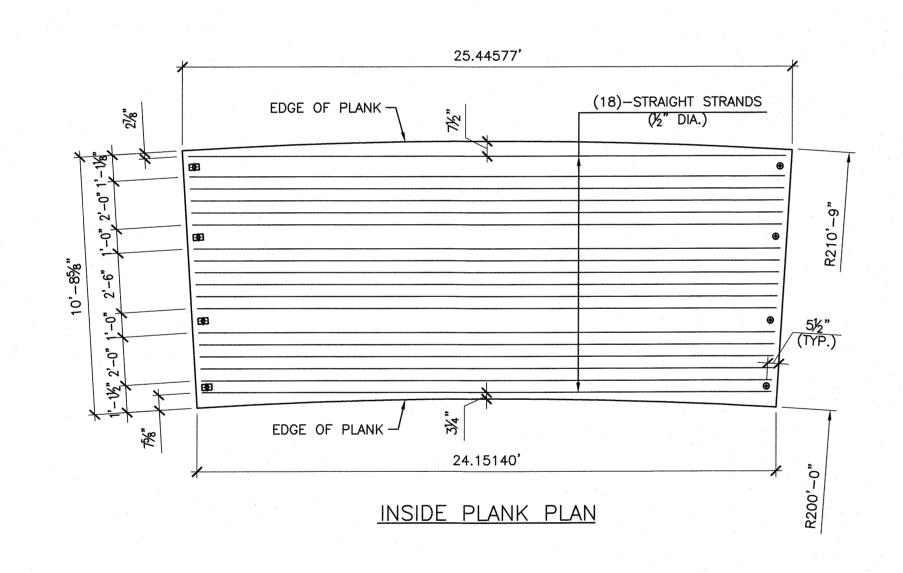
IN THE FIELD.

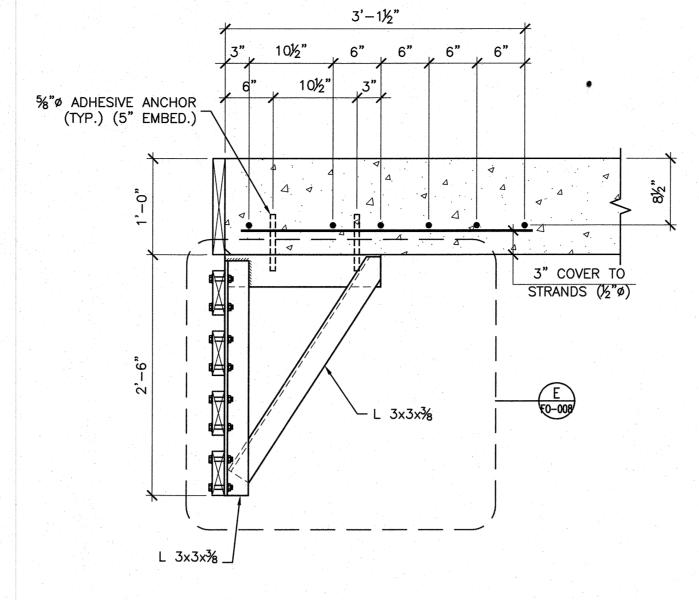






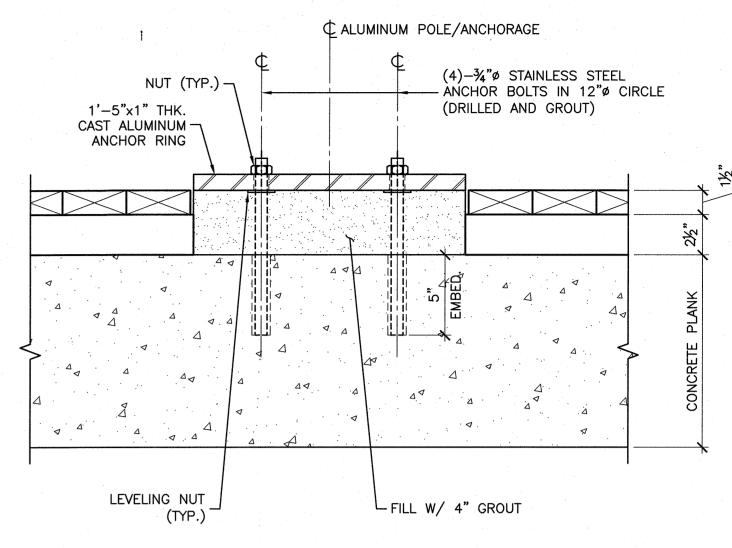






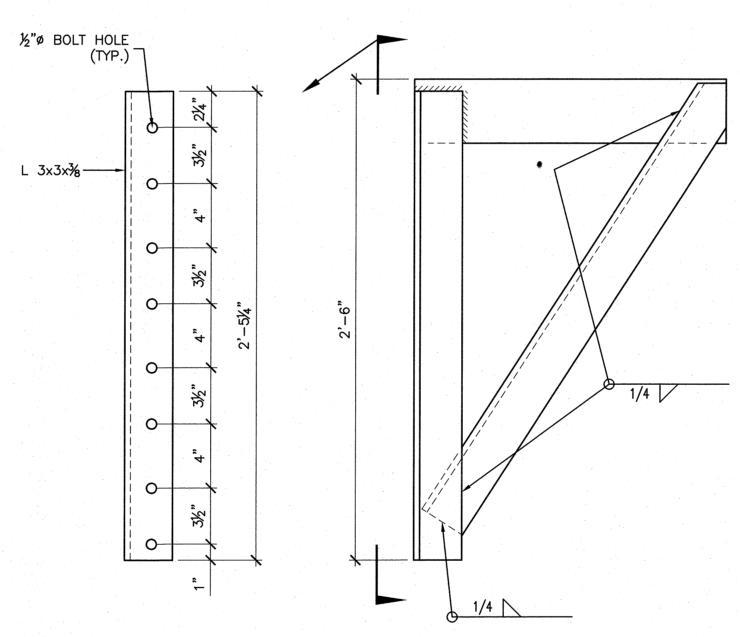

E SKIRT MOUNTING BRACKET DETAIL

2" =1'-0" 2" =1'-0"

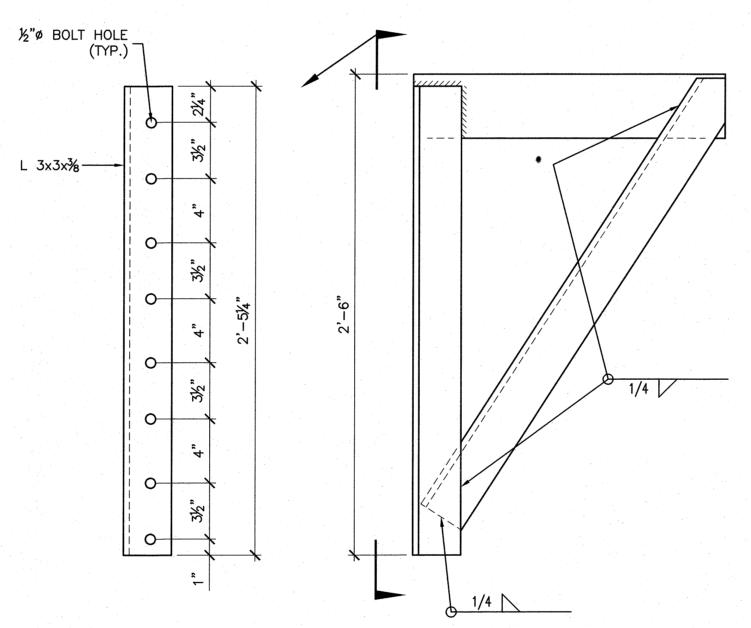

BOARDWALK SKIRT MOUNTING BRACKET

1. BRACKET TO BE WELDED IN SHOP AND ANCHORED TO PLANK

2. INSERTS TO BE CAST—IN TO PRECAST PLANK TO ACCOMMODATE BRACKET ANCHORAGE.

1"=1'-0"



CONSULTANT INFORMATION A PP LIE BOOK Wort North NY 10004

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15-528 | FO-008

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REVISION DATE MADE APP'D REVISION

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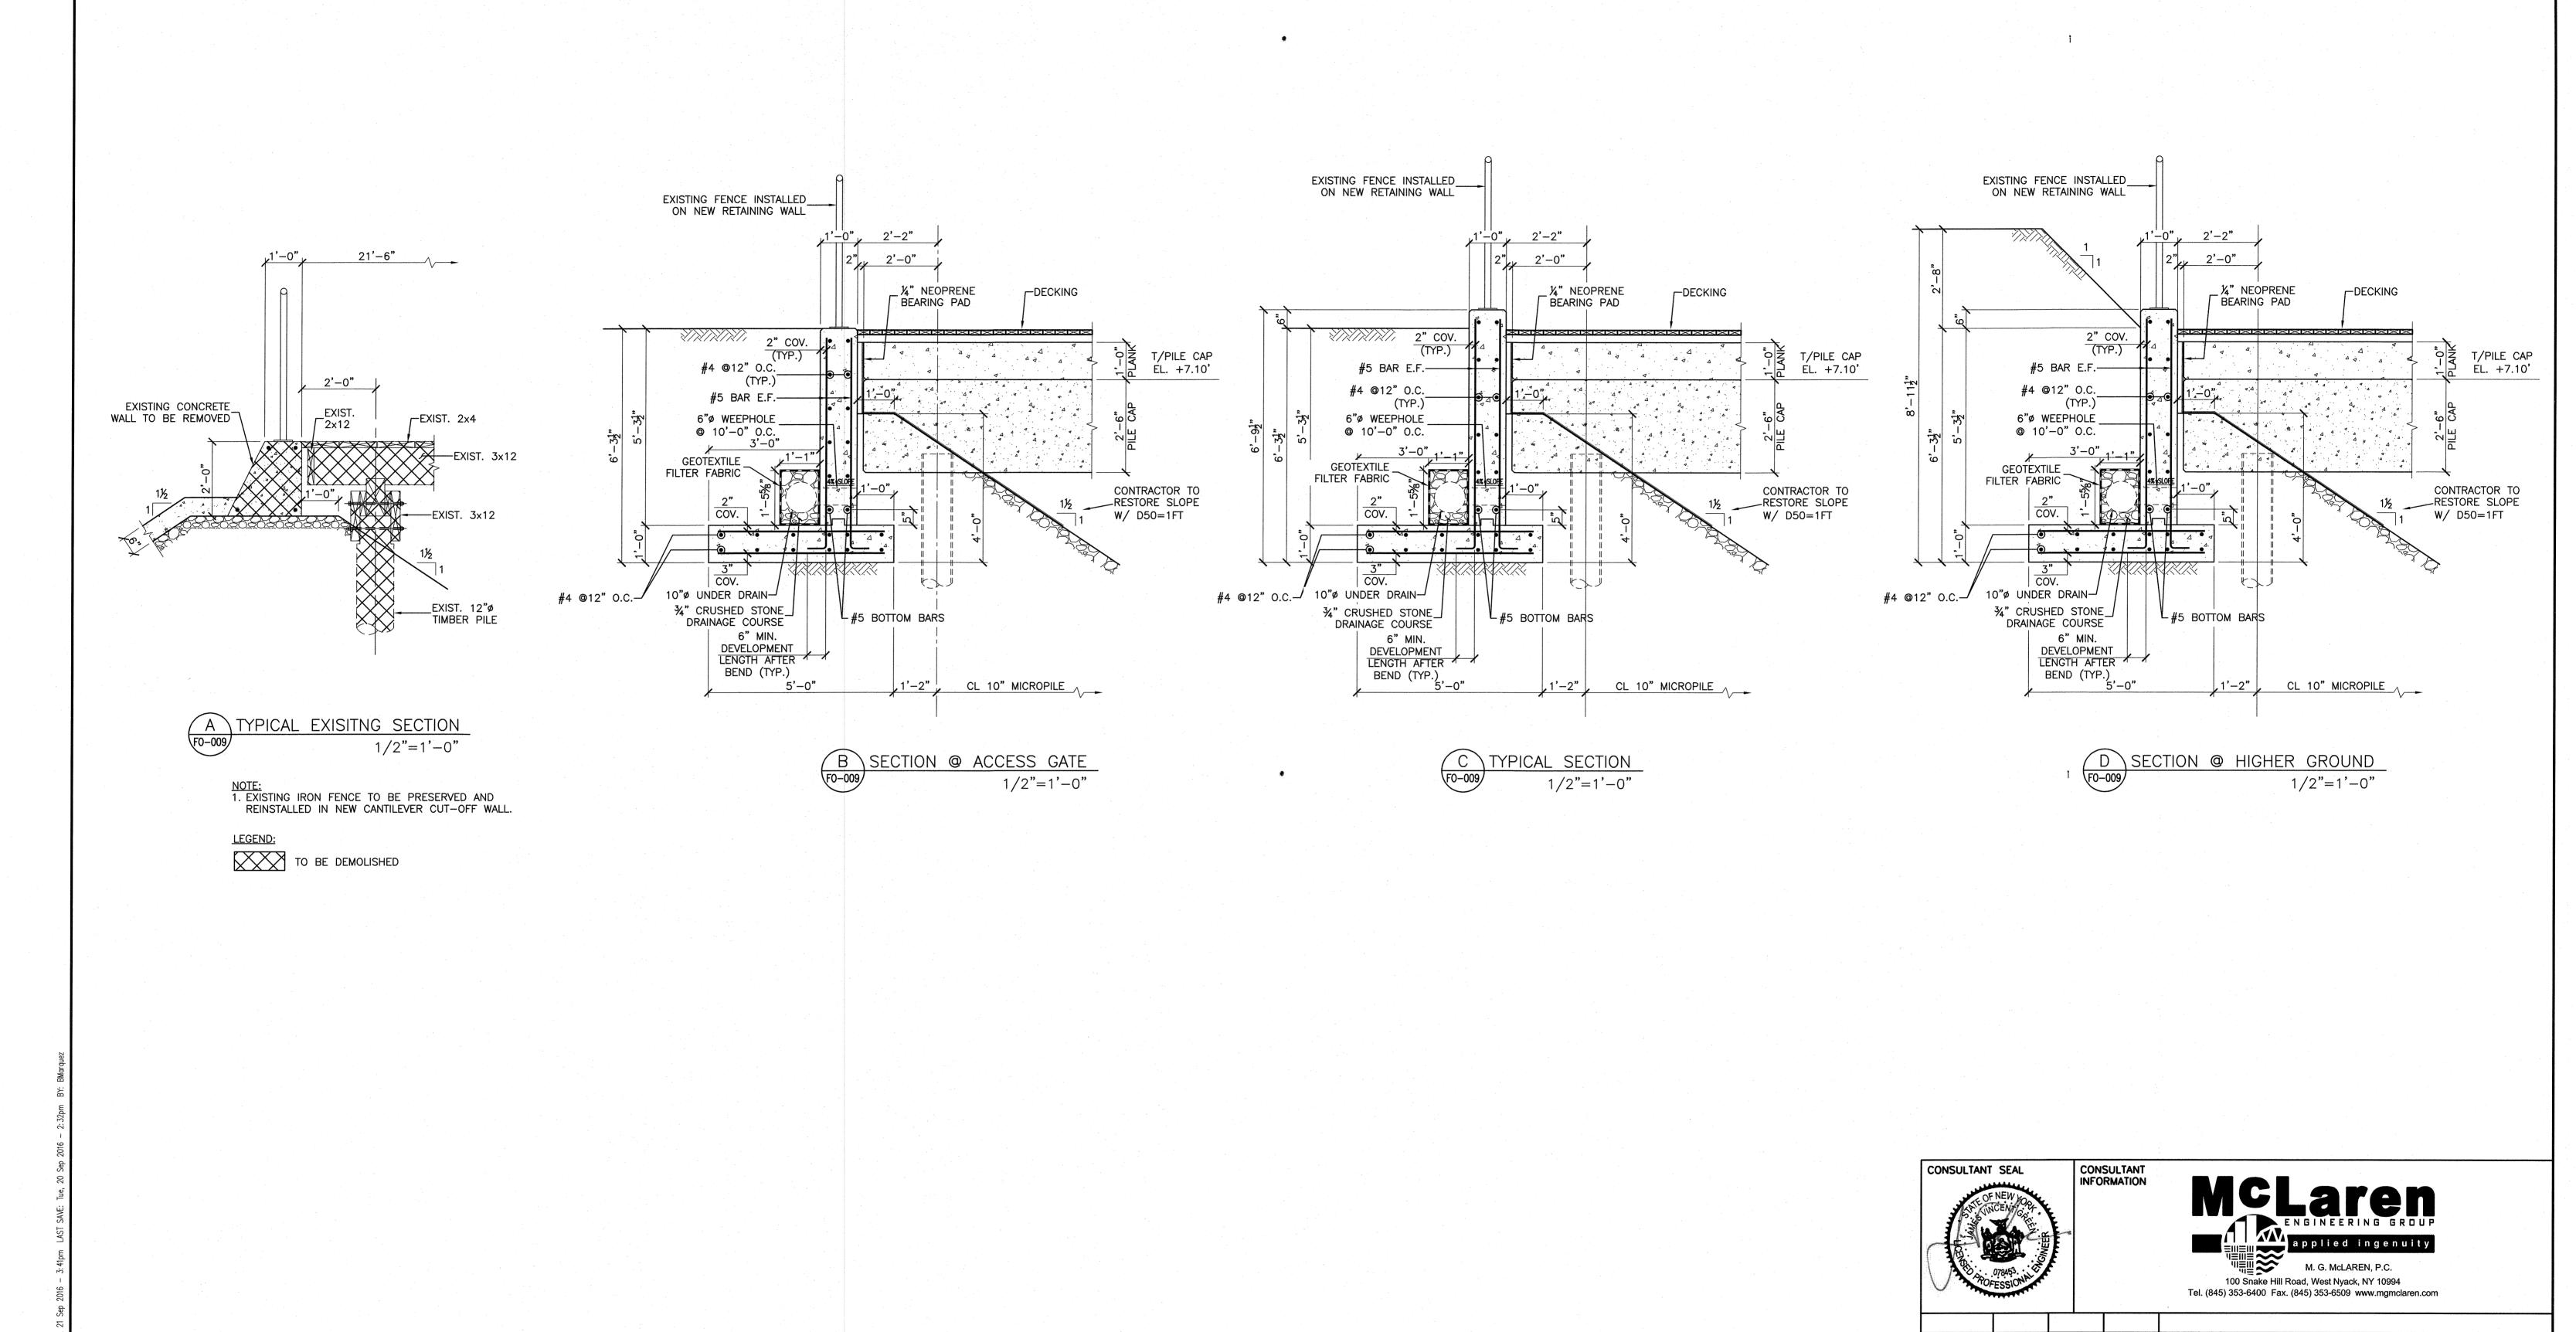
CONTRACTOR PROJECT COORDINATOR

DATE CONTRACT NUMBER WESTCHESTER COUNTY, NEW YORK DEPARTMENT OF PUBLIC WORKS AND TRANSPORTATION DIVISION OF ENGINEERING

SUPERSTORM SANDY REHABILITATION NORTH BOARDWALK RECONSTRUCTION PLAYLAND PARK RYE, NEW YORK

SHEET NO. 15 OF 21 SCALE: AS NOTED DATE: 09/22/16 DPW FILE NO. DECK PLANK AND DECKING SECTIONS AND DETAILS - 2

IN CHARGE OF J. V. GREEN P.E. CHECKED BY S. E. THORVALDSEN B. G. MARQUEZ





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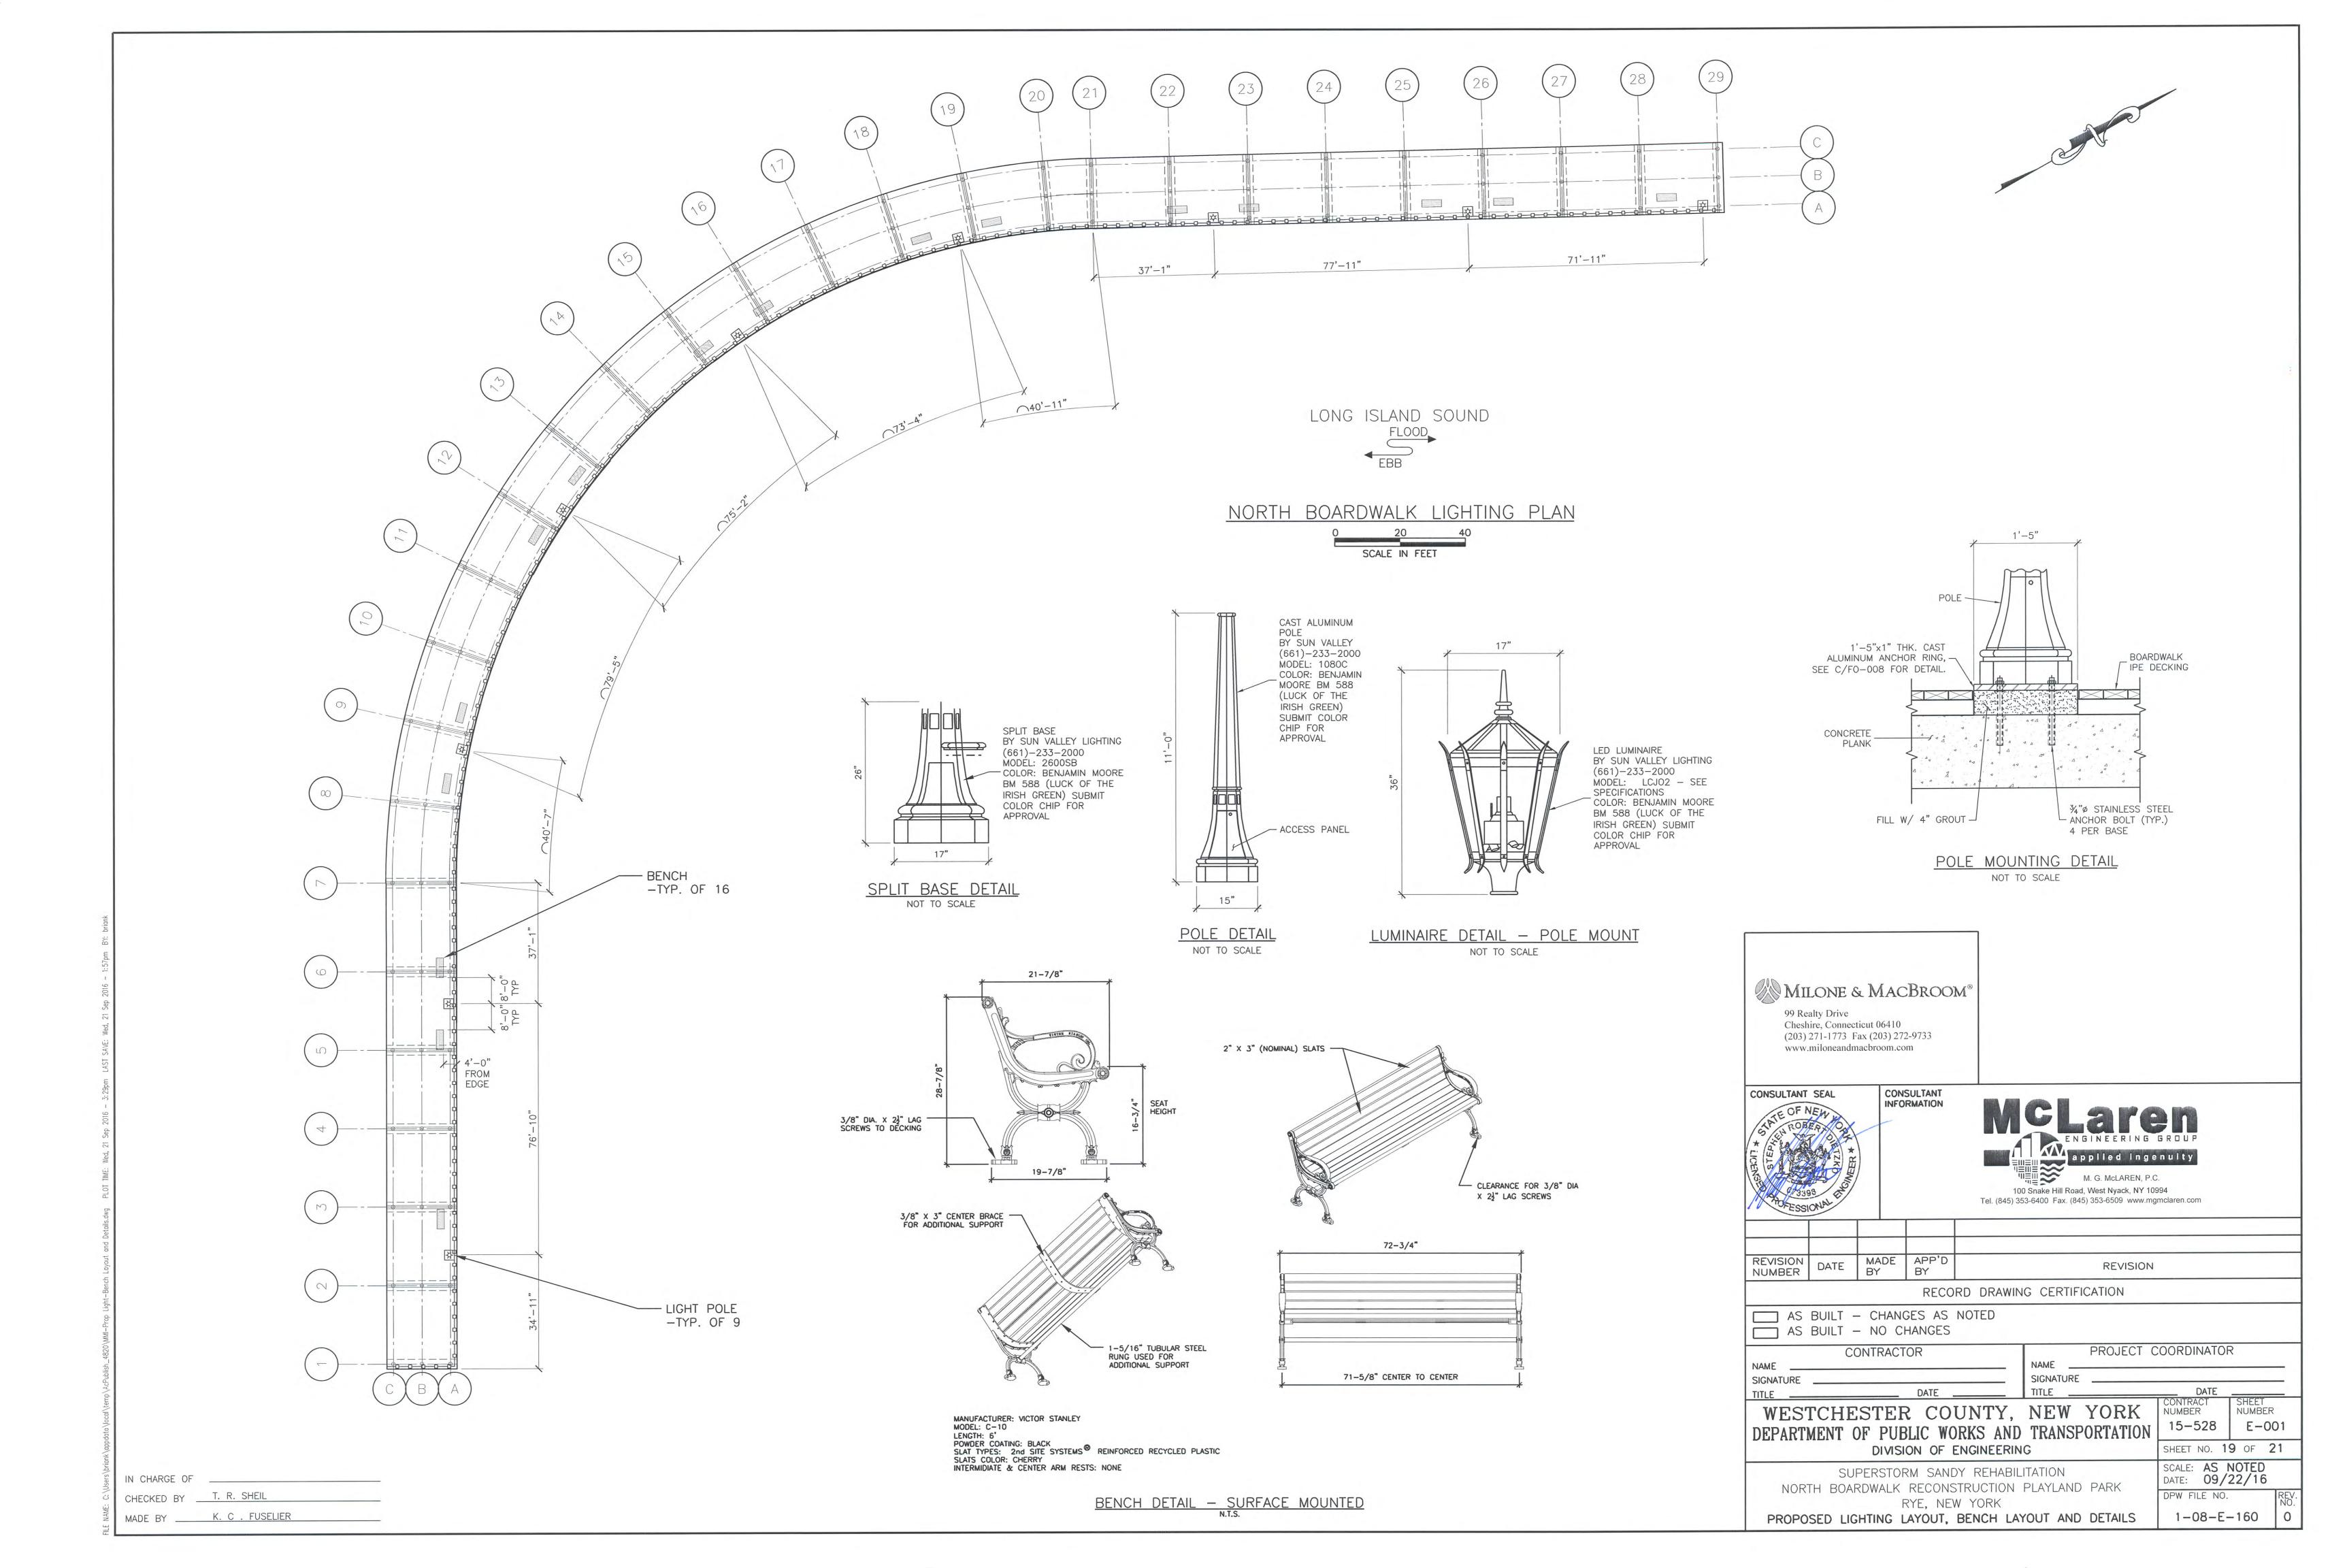
CHECKED BY S. E. THORVALDSEN


MADE BY B. G. MARQUEZ

REVISION NUMBER DATE MADE APP'D BY REVISION RECORD DRAWING CERTIFICATION AS BUILT - CHANGES AS NOTED AS BUILT - NO CHANGES CONTRACTOR PROJECT COORDINATOR NAME SIGNATURE CONTRACT NUMBER SHEET NUMBER WESTCHESTER COUNTY, NEW YORK 15-528 FO-009 DEPARTMENT OF PUBLIC WORKS AND TRANSPORTATION DIVISION OF ENGINEERING SHEET NO. 16 OF 21 SCALE: AS NOTED DATE: 09/22/16 SUPERSTORM SANDY REHABILITATION NORTH BOARDWALK RECONSTRUCTION PLAYLAND PARK DPW FILE NO. RYE, NEW YORK 1-08-G-157 (RETAINING WALL DETAILS



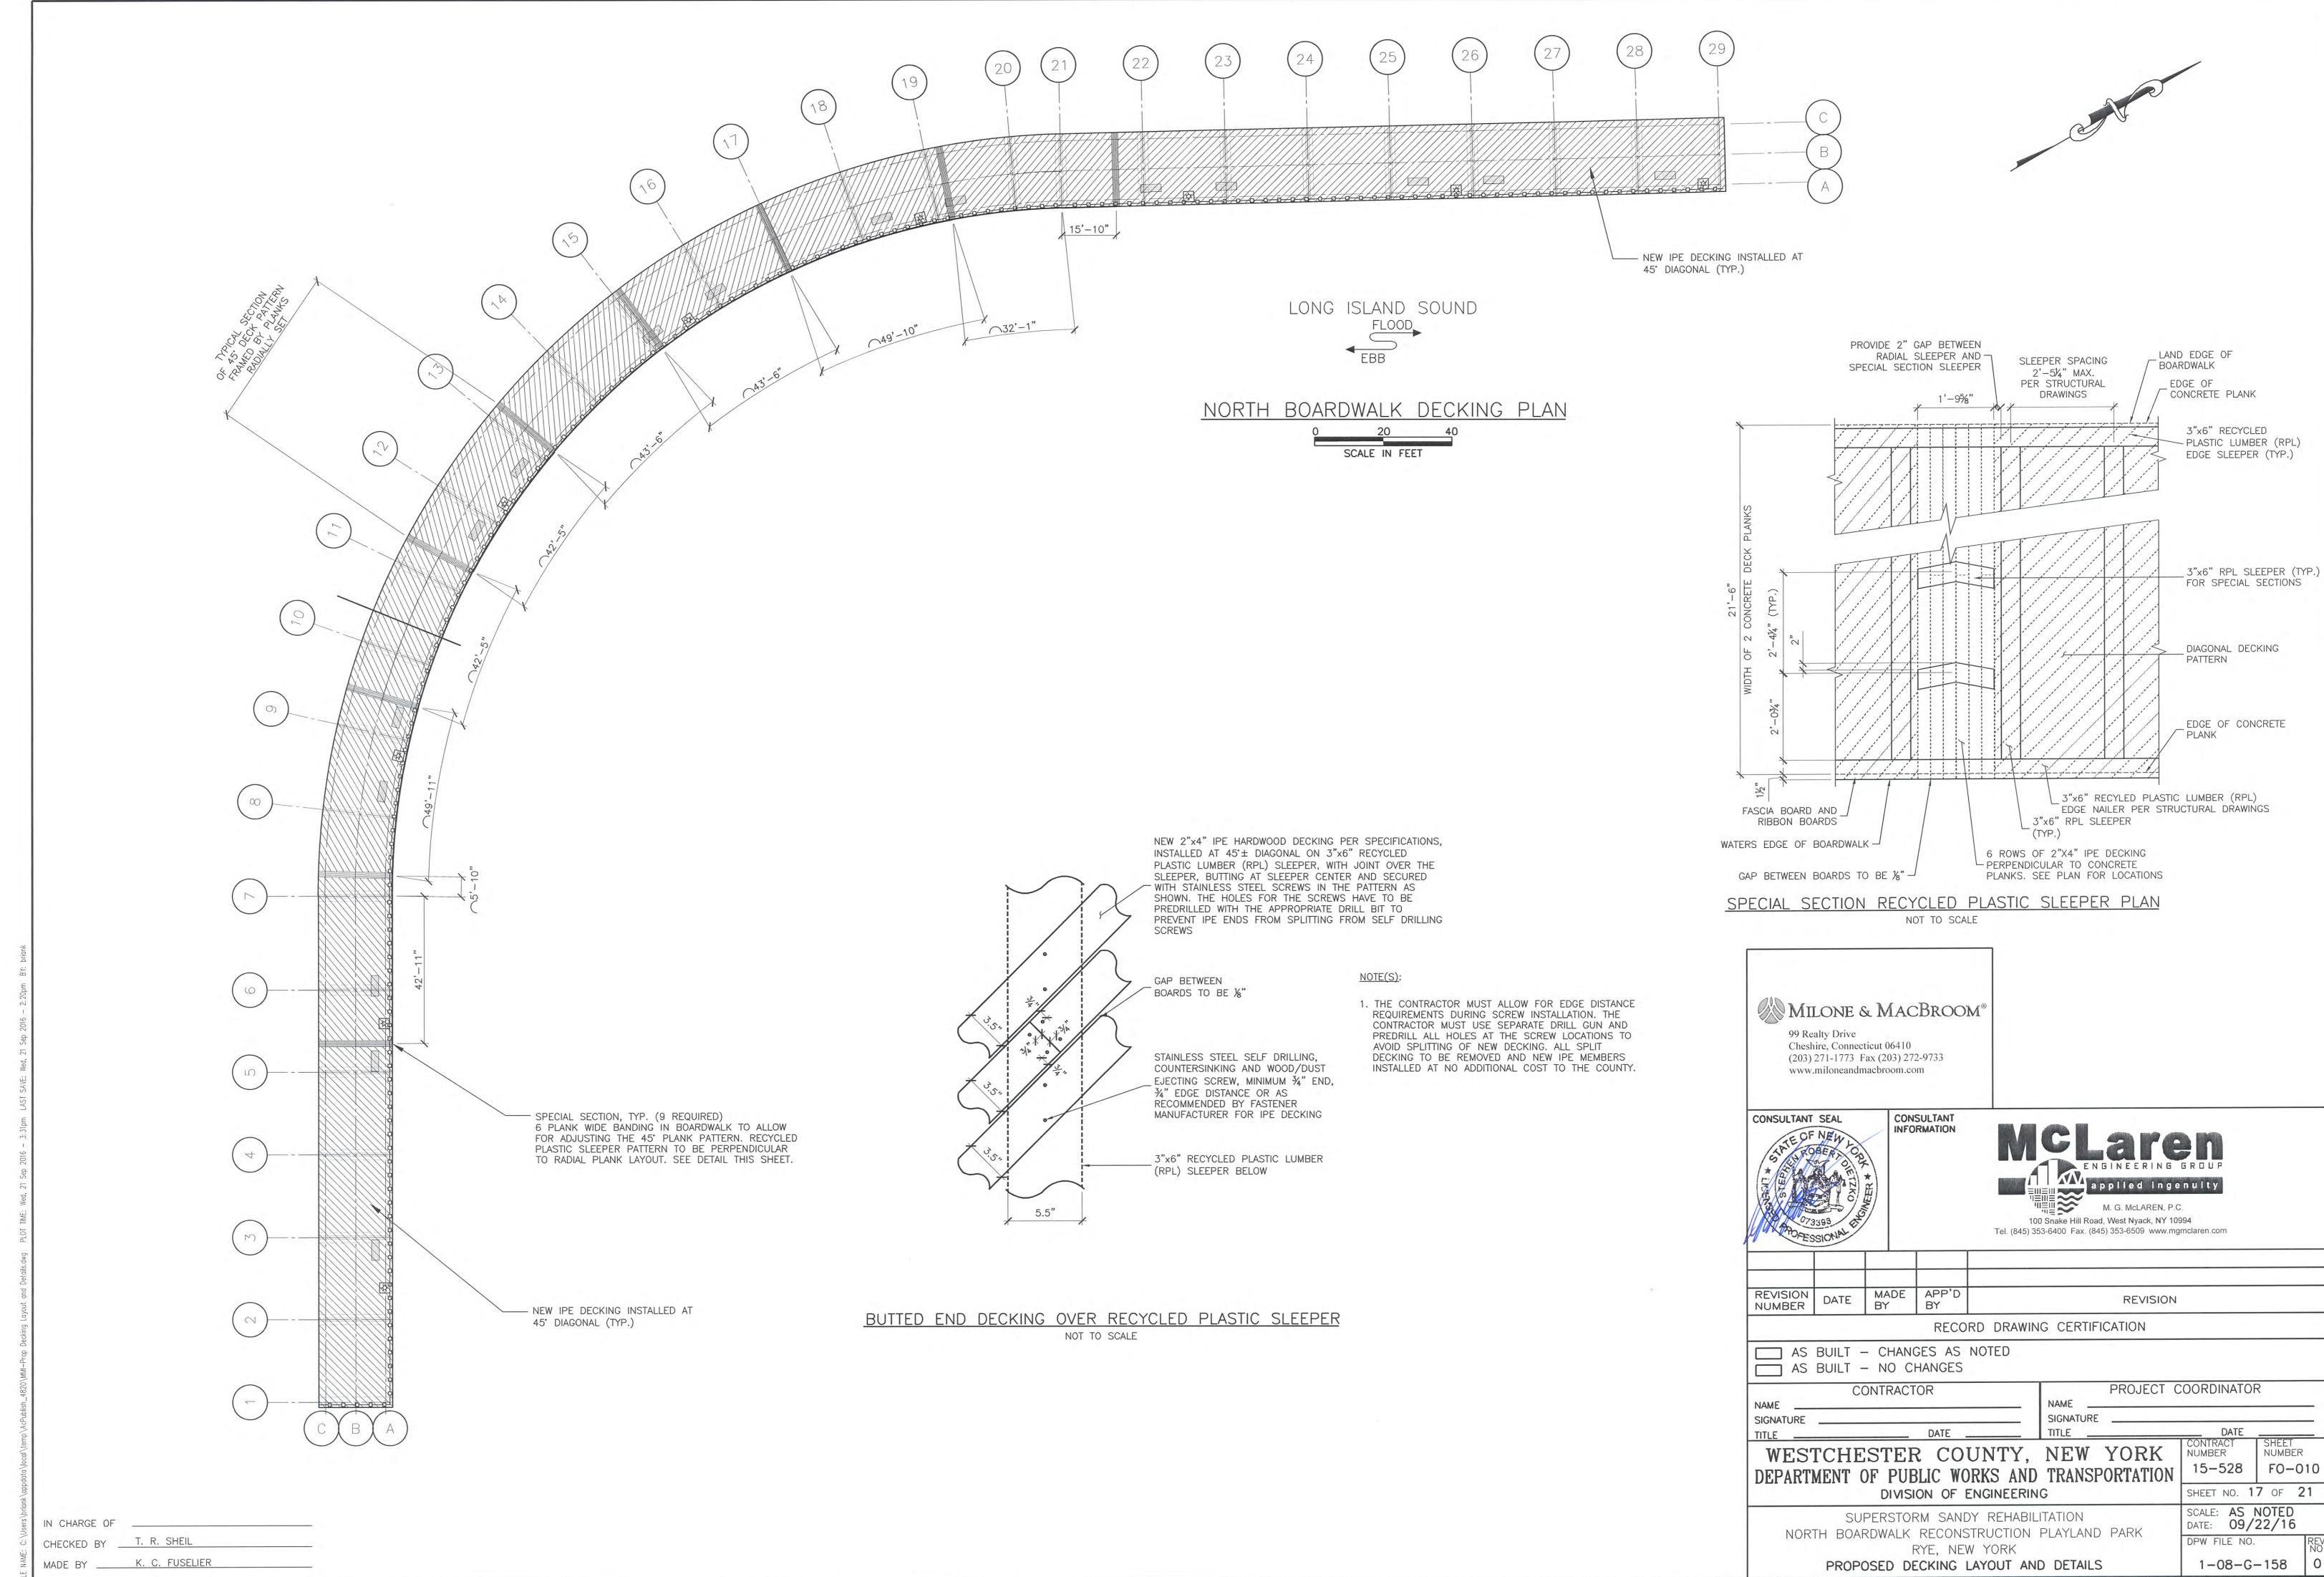

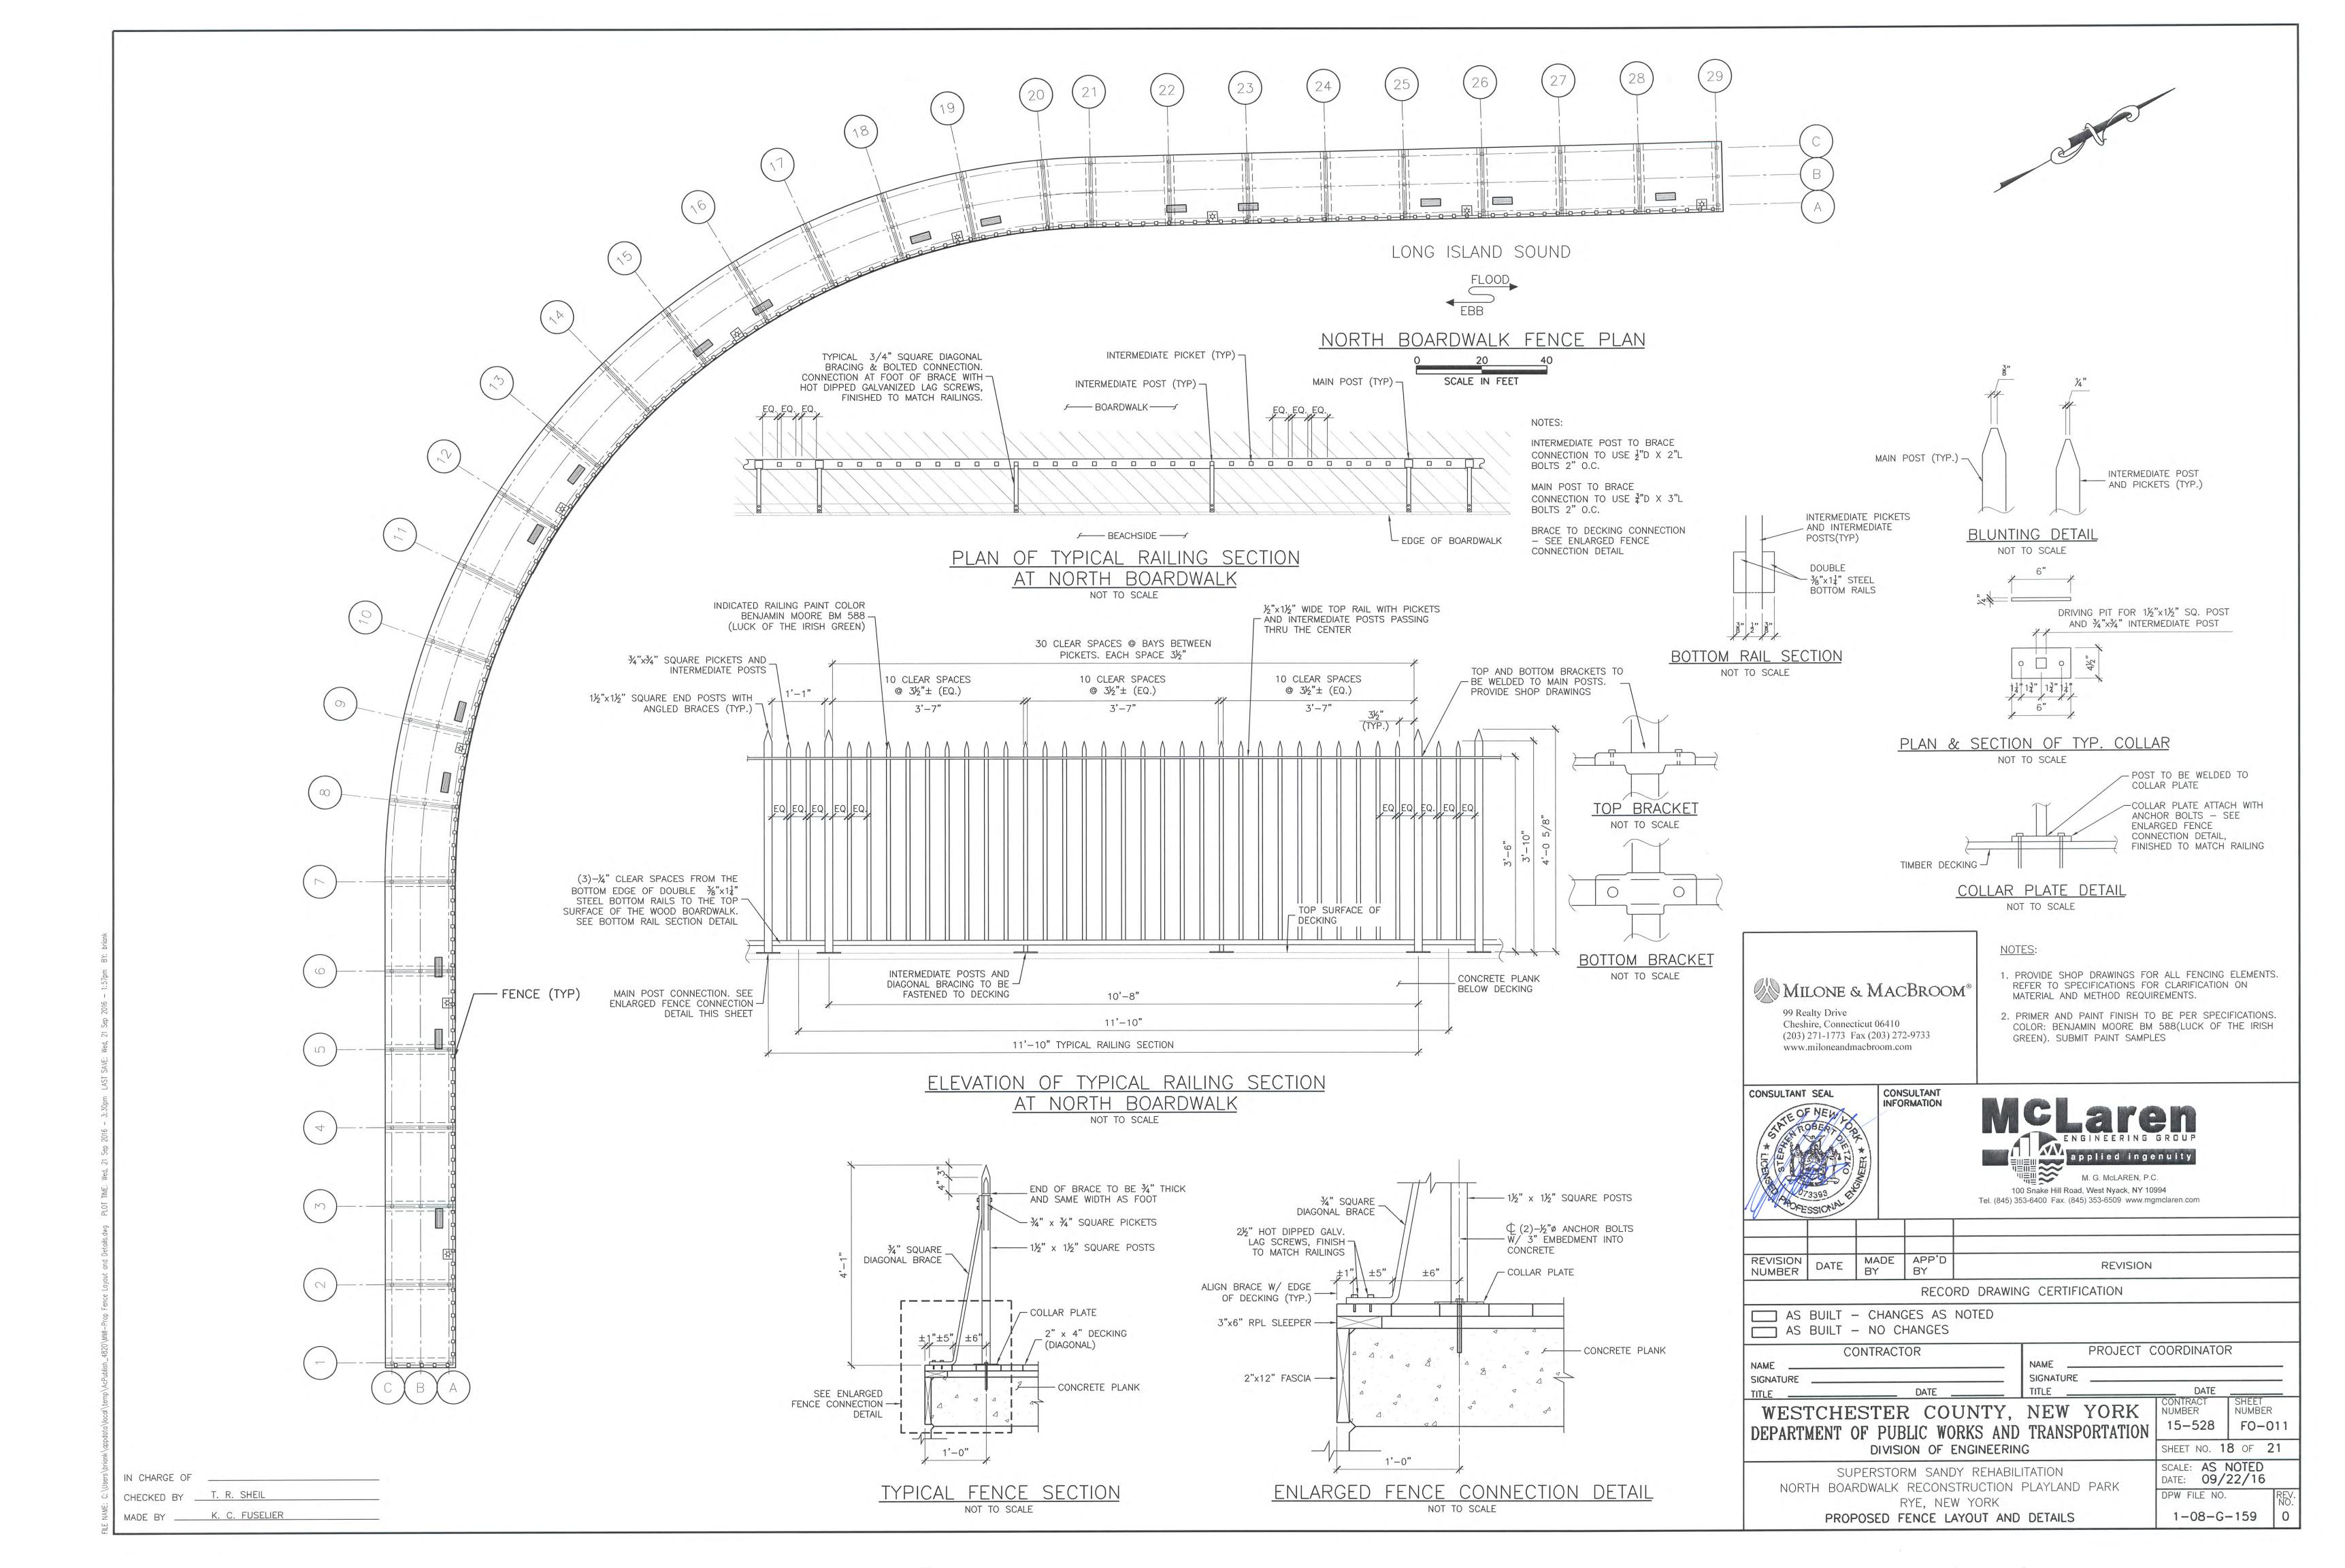

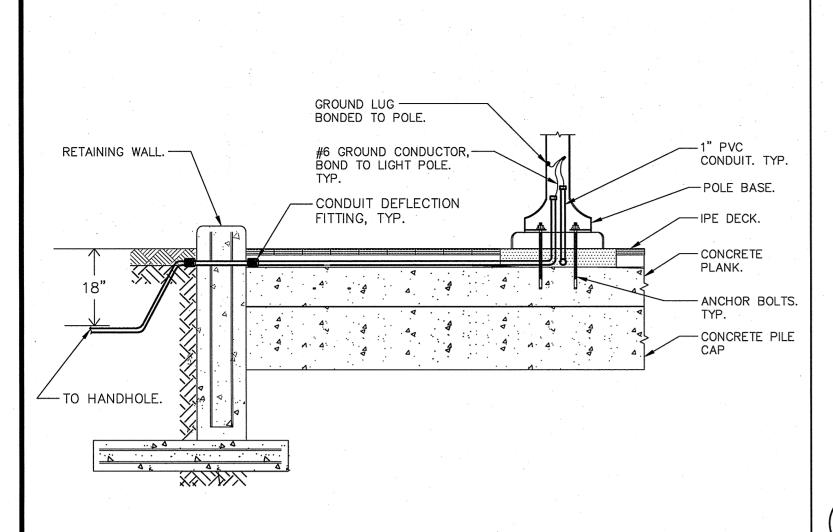


NOTE:

SCALE: NONE

1.) SEE SITE ENGINEERS DRAWINGS FOR MORE DETAIL.

BOARDWALK PENETRATION AND LIGHT POST ELECTRICAL INSTALLATION DETAIL

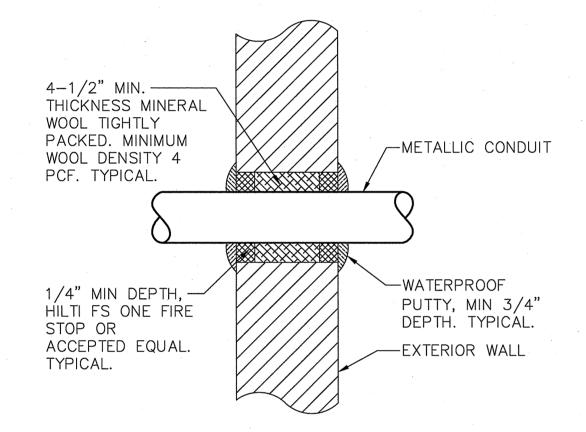


TYPICAL ABOVE GRADE CONDUIT EXTERIOR MASONRY WALL

PENETRATION DETAIL


N CHARGE OF

____J. TORRE

J. MULVEY

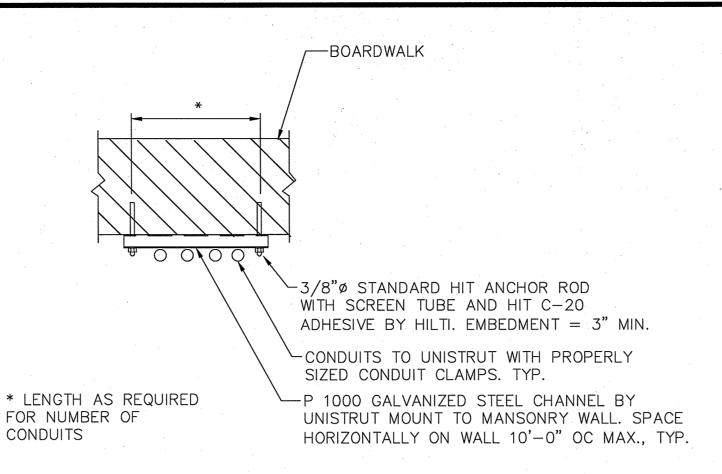

TYPICAL CONDUIT SUPPORT ON MASONRY

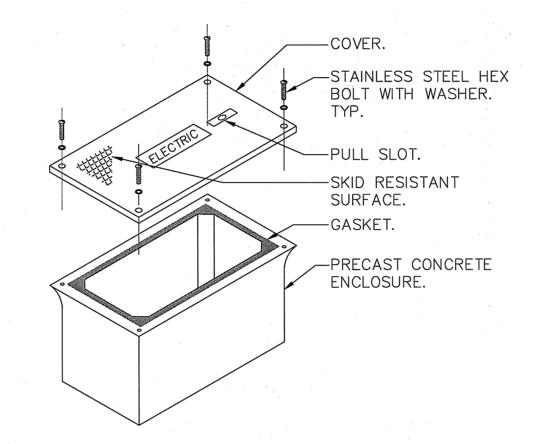


NOTES

1.) HAND HOLE SHALL BE SIZE INDICATED ON DWG E-3.1 WITH OPEN BOTTOM AND RATED FOR VEHICULAR TRAFFIC AS MANUFACTURED BY QUAZITE PD STYLE OR EQUAL. BOX SHALL BE INSTALLED IN ACCORDANCE WITH MANUFACTURER'S INSTRUCTIONS.

2.) PROVIDE 6" OF GRAVEL BELOW BOX.

3.) COVER SHALL BE IMPRINTED WITH THE APPROPRIATE DESCRIPTION OF BOX CONTENTS (I.E. ELECTRIC, TELEPHONE, DATA, CABLE TV, ETC.).

HAND HOLE DETAIL

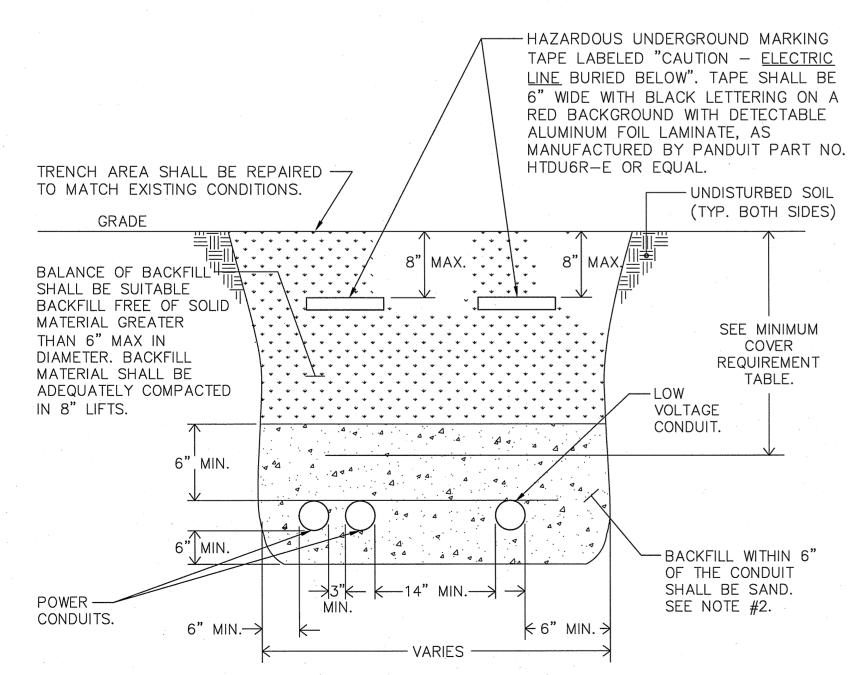

	MINIMUM COVER RE	EQUIREMENT TABLE
	LOCATION	NONMETALLIC RACEWAYS LISTED FOR DIRECT BURIAL WITHOUT CONCRETE ENCASEMENT OR OTHER APPROVED RACEWAYS
	ALL LOCATION NOT SPECIFIED BELOW.	18"
	IN TRENCH BELOW 2-IN. THICK CONCRETE OR EQUIVALENT.	12"
-	UNDER MINIMUM OF 4—IN. THICK CONCRETE EXTERIOR SLAB WITH NO VEHICULAR TRAFFIC AND THE SLAB EXTENDING NOT LESS THAN 6 IN. BEYOND THE UNDERGROUND INSTALLATION.	4" SEE NOTE #2.
	UNDER STREETS, HIGHWAYS, ROADS, ALLEYS, DRIVEWAYS, AND PARKING LOTS.	24"

NOTES:

1.) DETAIL SHOWN FOR INFORMATION PURPOSES. SAME CONCEPT SHALL ALSO APPLY FOR SINGLE CONDUITS.

2.) SAND MAY BE OMITTED FOR INSTALLATIONS WHERE COVER REQUIREMENTS ARE 6" OR LESS.

TRENCHING DETAIL FOR CONDUIT

SYMBOLS A	AND ABE	BREVIATIONS	DEFINITION OF TERMS
SYMBOL A	ABBREVIATION	DESCRIPTION	1.) WHEREVER IN THE CONTRACT DOCUMENT
	· <u>-</u>	CONDUIT AND WIRING	UNDERSTOOD THAT WESTCHESTER COUNTY IS
UG	-	BURIED CONDUIT	4.) WHEREVER IN THE CONTRACT DOCUMENT COMPANY" ARE USED, IT MUST BE UNDERST
	- .	HOMERUN TO PANEL, ARROWS INDICATE # 1P	7.) "WORK" MUST BE DEEMED TO CONSIST OF HOISTING, MATERIALS, TOOLS, EQUIPMENT, S
4	-	MULTI-POLE HOMERUN	AND SUPERVISION REQUIRED AND / OR REA REQUIRED BY THE CONTRACT DOCUMENTS.
		ELECTRICAL EQUIPMENT AS INDICATED	8.) "FURNISH" MEANS THE DESIGN, FABRICA
(W)	_	ELECTRIC METER	9.) "INSTALL OR INSTALLATION" MEANS THE
J	-	JUNCTION BOX	ERECTING, ANCHORING, SECURING, ETC., CON APPLIANCES, AND SIMILAR ITEMS SPECIFIED
	· -	FUSED DISCONNECT SWITCH	SPECIFIED ITEMS MUST BE COMPLETE IN ALL
	-	UNFUSED DISCONNECT SWITCH	10.) "PROVIDE" MEANS TO FURNISH AND INS DEFINED ABOVE.
<u></u>	CB	CIRCUIT BREAKER	11.) THE FOLLOWING ARE DEFINITIONS OF SH
OR , ,	GND	GROUND AS PER LOCAL CODE	A.) "NO EXCEPTIONS TAKEN" MEANS THAT T
No E	<u>-</u>	TRANSFER SWITCH	CAPACITY, ETC. AND SUBSTANTIAL CONFORM SPECIFICATIONS. FABRICATION AND/OR PURC
m OR T	XFMR	TRANSFORMER	B.) "MAKE CORRECTIONS NOTED" MEANS TH
E-	СТ	CURRENT TRANSFORMER	PERFORMANCE, CAPACITY, ETC. AND SUBSTA
	AS	AMPERAGE OF SWITCH	CORRECTIONS INDICATED ON THE SHOP DRA
	ATS	AUTOMATIC TRANSFER SWITCH	C.) "AMEND AND RESUBMIT" MEANS THAT THE AND IMPORTANT THAT THE REVIEWER WANTS
	AWG	AMERICAN WIRE GAUGE	ARE RESOLVED PRIOR TO RELEASE FOR FAB PURCHASE MAY <u>NOT</u> COMMENCE.
	BLDG	BUILDING	D.) "REJECTED" MEANS THAT THE SHOP DRA
	CKT	CIRCUIT	CONTRACT DRAWINGS AND/OR SPECIFICATION COMMENCE.
	CU	COPPER	DEMOLITION NOTES
	MCB	MAIN CIRCUIT BREAKER	DEMOCITION NOTES
	MLO	MAIN LUG ONLY	 ALL EQUIPMENT SHALL BE DISCONNECTOR ORIGINATION UNLESS OTHERWISE NOTED (UNLESS)
	NIC	NOT IN CONTRACT	2.) CONTRACTOR SHALL VERIFY EXTENT O
	NTS	NOT TO SCALE	AND SHALL INCLUDE ALL LABOR AND MA- CONNECTIONS, CONDUIT AND WIRE IN ORD
	PNL	PANEL	CONTINUOUS SERVICE TO DEVICES AND SY WORK REQUIRING THE SHUT—DOWN OF TH
NOTES:			OVERTIME AND SHALL BE INCLUDED IN BA

1.) ALL SYMBOLS AND ABBREVIATIONS MAY NOT BE APPLICABLE FOR THIS PROJECT. 2.) SEE LANDSCAPE PLANS FOR LIGHTING FIXTURE INFORMATION.

GENERAL NOTES

- 1.) ALL WORK SHOWN IS NEW UNLESS OTHERWISE NOTED (UON) EXISTING TO REMAIN (EX.)
- 2.) THE DRAWINGS ARE TO BE CONSIDERED SCHEMATIC ONLY AND DO NOT NECESSARILY SHOW THE EXACT LOCATIONS AND DETAILS OF THE WORK TO BE INSTALLED.
- 3.) THE ELECTRICAL CONTRACTOR SHALL BE RESPONSIBLE FOR OBTAINING ALL NECESSARY PERMITS AND PAYING ALL FEES ASSOCIATED WITH THIS WORK INCLUDING FILING WITH THE UTILITY COMPANY (AS REQUIRED), AND WITH LOCAL AUTHORITY HAVING JURISDICTION.
- 4.) ELECTRICAL CONTRACTOR SHALL BE RESPONSIBLE TO HIRE A THIRD PARTY ELECTRICAL INSPECTION AGENCY TO PROVIDE UL INSPECTIONS AND SUBMIT A CERTIFICATE OF INSPECTION PRIOR TO FINAL REQUEST FOR PAYMENT.
- 6.) ALL CONDUCTORS SHALL BE COPPER UON "ON DRAWINGS".
- 7.) ELECTRONIC FILES OF THE MECHANICAL, ELECTRICAL, PLUMBING AND FIRE PROTECTION DRAWINGS ARE AVAILABLE TO THE CONTRACTOR VIA COMPACT DISK. THE ENGINEER MAY GRANT THE CONTRACTOR A LIMITED LICENSE TO MAKE A DERIVATIVE WORK OF THE DATABASE FOR THE PURPOSE OF SHOP DRAWINGS, SUBMITTALS AND AS-BUILT DRAWINGS. UPON REQUEST, THE ENGINEER SHALL PROVIDE A RELEASE FORM THAT MUST BE SIGNED AND RETURNED BY THE CONTRACTOR ALONG WITH A LUMP SUM FEE OF TWO HUNDRED AND FIFTY (\$250.00) DOLLARS PRIOR TO RELEASE OF THE ELECTRONIC FILES. THIS FEE IS FOR TIME AND MATERIAL COSTS INCURRED IN PREPARING AND TRANSMITTING THE REQUESTED DATA.
- 8.) CIRCUIT NUMBERS ARE FOR INFORMATION PURPOSES ONLY. ACTUAL CIRCUIT NUMBERS SHALL BE DETERMINED IN THE FIELD.
- 13.) INSTALL CONDUIT EXPANSION FITTINGS AT ALL LOCATIONS WHERE CONDUITS CROSS BUILDING OR STRUCTURE EXPANSION JOINTS.
- 14.) INSTALL CONDUIT DEFLECTION FITTINGS AT ALL LOCATIONS WHERE CONDUITS TRANSITION FROM GROUND TO BOARDWALK.

TRENCHING NOTES

- 1.) CONTRACTOR SHALL LOCATE ALL EXISTING UNDERGROUND UTILITIES THAT ARE NOT PART OF N.Y. STATE "CODE 753" PRIOR TO DIGGING.
- 2.) ALL EXCAVATING IN THE AREA OF THE EXISTING UNDERGROUND EQUIPMENT. PIPES AND CONDUITS SHALL BE PERFORMED BY HAND.
- 3.) ANY AREA/PLANTS OR LANDSCAPING OR PAVEMENTS DISTURBED DURING THE EXCAVATION SHALL BE RESTORED OR REPLACED TO MATCH EXISTING CONDITIONS BY THE CONTRACTOR AT NO COST TO THE OWNER.
- 4.) ANY EXISTING BURIED CONDUITS, DRAINAGE, SPRINKLER PIPING, ETC. THAT IS DISTURBED AND/OR DAMAGED DURING CONSTRUCTION SHALL BE REPAIRED BY THE CONTRACTOR AT NO COST TO THE OWNER.
- 5.) THE PLANS SHOW SOME KNOWN SUBSURFACE STRUCTURES, ABOVE GROUND STRUCTURES AND/OR UTILITIES BELIEVED TO EXIST IN THE WORKING AREA, EXACT LOCATION OF WHICH MAY VARY FROM THE LOCATIONS INDICATED. IN PARTICULAR, THE CONTRACTOR IS WARNED THAT THE EXACT OR EVEN APPROXIMATE LOCATION OF SUCH PIPELINES, SUBSURFACE STRUCTURES AND/OR UTILITIES IN THE AREA MAY OR MAY NOT BE SHOWN; AND IT SHALL BE HIS RESPONSIBILITY TO PROCEED WITH GREAT CARE IN EXECUTING ANY WORK. 48 HOURS BEFORE YOU DIG, DRILL OR BLAST, CALL 1-800-962-7962 (NY STATE).


DEFINITION OF TERMS

- WHEREVER IN THE CONTRACT DOCUMENTS THE WORD "CLIENT" IS USED, IT MUST BE IDERSTOOD THAT WESTCHESTER COUNTY IS INTENDED.
- WHEREVER IN THE CONTRACT DOCUMENTS THE WORDS "ELECTRICAL UTILITY" OR "POWER MPANY" ARE USED. IT MUST BE UNDERSTOOD THAT "CON EDISON" IS INTENDED.
- "WORK" MUST BE DEEMED TO CONSIST OF ALL LABOR AND OPERATIONS, TRANSPORTATION, DISTING, MATERIALS, TOOLS, EQUIPMENT, SERVICES, INSPECTIONS, INVESTIGATIONS, COORDINATION ND SUPERVISION REQUIRED AND / OR REASONABLY NECESSARY TO PRODUCE THE CONSTRUCTION
- "FURNISH" MEANS THE DESIGN, FABRICATION, PURCHASE AND DELIVERY TO THE JOB SITE.
- "INSTALL OR INSTALLATION" MEANS THE ACT OF PHYSICALLY PLACING, APPLYING, SETTING, RECTING, ANCHORING, SECURING, ETC., CONSTRUCTION MATERIALS, EQUIPMENT, FURNISHINGS, PLIANCES, AND SIMILAR ITEMS SPECIFIED AND FURNISHED AT THE JOB SITE. INSTALLATION OF PECIFIED ITEMS MUST BE COMPLETE IN ALL RESPECTS.
-) "PROVIDE" MEANS TO FURNISH AND INSTALL CONSTRUCTION MATERIAL, EQUIPMENT, ETC. AS EFINED ABOVE.
- 1.) THE FOLLOWING ARE DEFINITIONS OF SHOP DRAWING STAMP ACTIONS:
-) "NO EXCEPTIONS TAKEN" MEANS THAT THE SHOP DRAWING IS CORRECT AS TO PERFORMANCE, APACITY, ETC. AND SUBSTANTIAL CONFORMANCE TO THE CONTRACT DRAWINGS AND PECIFICATIONS. FABRICATION AND/OR PURCHASE MAY COMMENCE
- "MAKE CORRECTIONS NOTED" MEANS THAT THE SHOP DRAWING IS CORRECT AS TO RFORMANCE, CAPACITY, ETC. AND SUBSTANTIAL CONFORMANCE TO THE CONTRACT DRAWINGS ND/OR SPECIFICATIONS, SUBJECT TO AND IN COMPLIANCE WITH THE ANNOTATIONS AND/OR PRRECTIONS INDICATED ON THE SHOP DRAWING. FABRICATION AND/OR PURCHASE MAY COMMENCE.
- "AMEND AND RESUBMIT" MEANS THAT THE COMMENTS AND/OR CORRECTION ARE SO EXTENSIVE ND IMPORTANT THAT THE REVIEWER WANTS TO SEE HOW THE COMMENTS AND/OR CORRECTIONS RE RESOLVED PRIOR TO RELEASE FOR FABRICATION AND/OR PURCHASE, FABRICATIONS AND/OR RCHASE MAY NOT COMMENCE.
-) "REJECTED" MEANS THAT THE SHOP DRAWING DOES NOT COMPLY OR CONFORM TO THE NTRACT DRAWINGS AND/OR SPECIFICATIONS. FABRICATION AND/OR PURCHASE MAY NOT

EMOLITION NOTES

- ALL EQUIPMENT SHALL BE DISCONNECTED AND REMOVED BACK TO POWER SOURCE RIGINATION UNLESS OTHERWISE NOTED (UON) EXISTING TO REMAIN (EX.).
- .) CONTRACTOR SHALL VERIFY EXTENT OF DEMOLITION WORK IN THE FIELD PRIOR TO BID ND SHALL INCLUDE ALL LABOR AND MATERIALS IN BASE BID INCLUDING ALL TEMPORARY ONNECTIONS, CONDUIT AND WIRE IN ORDER TO ACCOMMODATE CONSTRUCTION AND PROVIDE ONTINUOUS SERVICE TO DEVICES AND SYSTEMS TO REMAIN, TEMPORARY AND PERMANENTLY ORK REQUIRING THE SHUT—DOWN OF THE BUILDING POWER SHALL BE PERFORMED DURING VERTIME AND SHALL BE INCLUDED IN BASE BID.
- 3.) CIRCUIT BREAKER, CONDUIT AND CONDUCTOR SIZES INDICATED SHALL BE FIELD VERIFIED PRIOR TO BID.
- 4.) ALL EXISTING ELECTRICAL EQUIPMENT NO LONGER IN USE, SUCH AS DISCONNECT SWITCHES, MOTOR CONTROLLERS, MOTOR STARTER PANELS, ETC. SHALL BE REMOVED UON.
- 5.) ALL DISCONNECTED & REMOVED EXISTING ELECTRICAL ITEMS THAT ARE NOT BEING REUSED
- 6.) THE CONTRACTOR SHALL INCLUDE IN THE BASE BID FOR ALL MATERIAL & LABOR RÉQUIRED FOR THE EXTENSIONS. REROUTING & RELOCATION OF EXISTING SYSTEM COMPONENTS, EQUIPMENT, WIRING, CONDUITS & CABLING SO AS TO MAINTAIN OPERATION OF ALL SYSTEMS THROUGHOUT THE BUILDING DURING DEMOLITION & CONSTRUCTION PHASES.

OLA P/NO.: NMEGO040

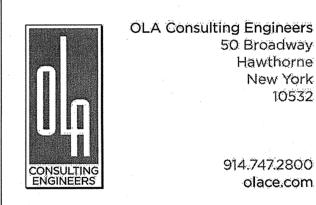

INFORMATION

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New York

10532

applied ingenuity M. G. McLAREN, P.C. 330 West 42nd Street, 14th Flr, New York NY 10036

Tel. (212) 548-1440 Fax. (212) 548-1431 www.mgmclaren.com

REVISION MADE APP'D DATE REVISION NUMBER

RECORD DRAWING CERTIFICATION

AS BUILT — CHANGES AS NOTED AS BUILT - NO CHANGES

CONTRACTOR PROJECT COORDINATOR NAME ____ NAME SIGNATURE SIGNATURE

DATE WESTCHESTER COUNTY, NEW YORK NUMBER 15-528

DEPARTMENT OF PUBLIC WORKS AND TRANSPORTATION DIVISION OF ENGINEERING

SUPERSTORM SANDY REHABILITATION NORTH BOARDWALK RECONSTRUCTION PLAYLAND PARK TOWN OF RYE. NEW YORK


ABBREVIATIONS, NOTES AND DETAILS

SHEET NO. 20 OF 21 SCALE: AS NOTED DATE: 7/26/16 DPW FILE NO. 1-08-E-161

DATE

SHEET NUMBER

E-002

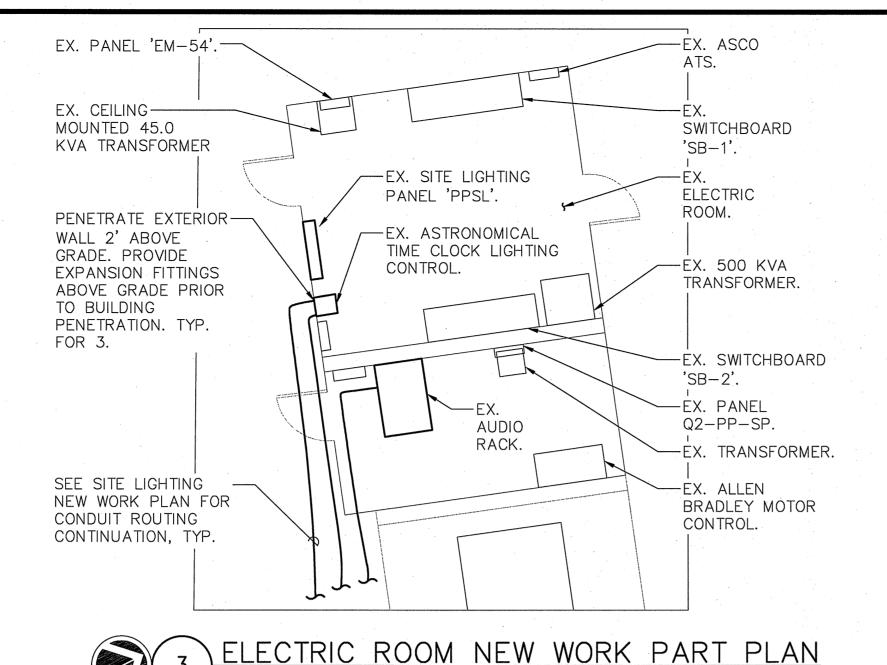

--TO SPEAKERS. 12 AWG MODEL-#AQ296 AQUASEAL CONDUCTORS BY -EX. AUDIO PATCH WEST PENN. PANEL. 12 AWG TYPE CL2P-CONDUCTORS BY WEST PENN. -EX. BOARDWALK AUDIO AMPLIFIER AUDIO INPUT, -#4 BY PASO, TYP. MODEL #DMS4361B. 12 AWG TYPE CL2P-CONDUCTORS BY WEST PENN. EX. 8X8 AUDIO PROCESSOR BY ASHLEY, MODEL AUDIO OUTPUT,-EX. AUDIO RACK —EX. SYSTEM

AUDIO SYSTEM CONTROL WIRING DIAGRAM

INPUT.

AUDIO SYSTEM NOTES:


1.) PROVIDE NEW CONDUCTORS INDICATED.

- EX. CONNECTION

TO PANEL

Q2-PP-SP.

	MAIN RATING: 100A	MA	IN C.B.:	MLO		KAIC RATING: 14KAIC	
	VOLTAGE: 480Y/277V	PH	ASE: <u>3</u>	WIF	RE: 4	MOUNTING: <u>SURFACE</u>	
CIRC. NO.	LOAD DESCRIPTION	BKR. AMPS	NO. OF POLES	NO. OF POLES	BKR. AMPS	LOAD DESCRIPTION	CIRC NO.
1	* BOARDWALK LIGHT FIXTURES	20	1	· -	_	-	2
3	* BOARDWALK LIGHT FIXTURES	20	1			-	4
5	_	- <u>-</u>	_	·	. –	-	6
7	· —		_		_	<u> </u>	8
9				_	_	<u> </u>	10
11				_	. —		12
13	–		_	· _	_	_	14
15	<u> </u>		. –				16
17		<u> </u>		1	20	EX. SITE LIGHTING	18
19	EX. SITE LIGHTING	20	1	1	20	EX. SITE LIGHTING	20
21	EX. SITE LIGHTING	20	1	1	20	EX. SITE LIGHTING	22
23	EX. SITE LIGHTING	20	1	1	20	EX. SITE LIGHTING	24
25	EX. SITE LIGHTING	20	1	1	20	EX. SITE LIGHTING	26
27	EX. SITE LIGHTING	20	1	1	20	EX. SITE LIGHTING	28
29	EX. SITE LIGHTING	20	1	1	20	EX. SITE LIGHTING	30
31	EX. SITE LIGHTING	20	1	1,	20	EX. SITE LIGHTING	32

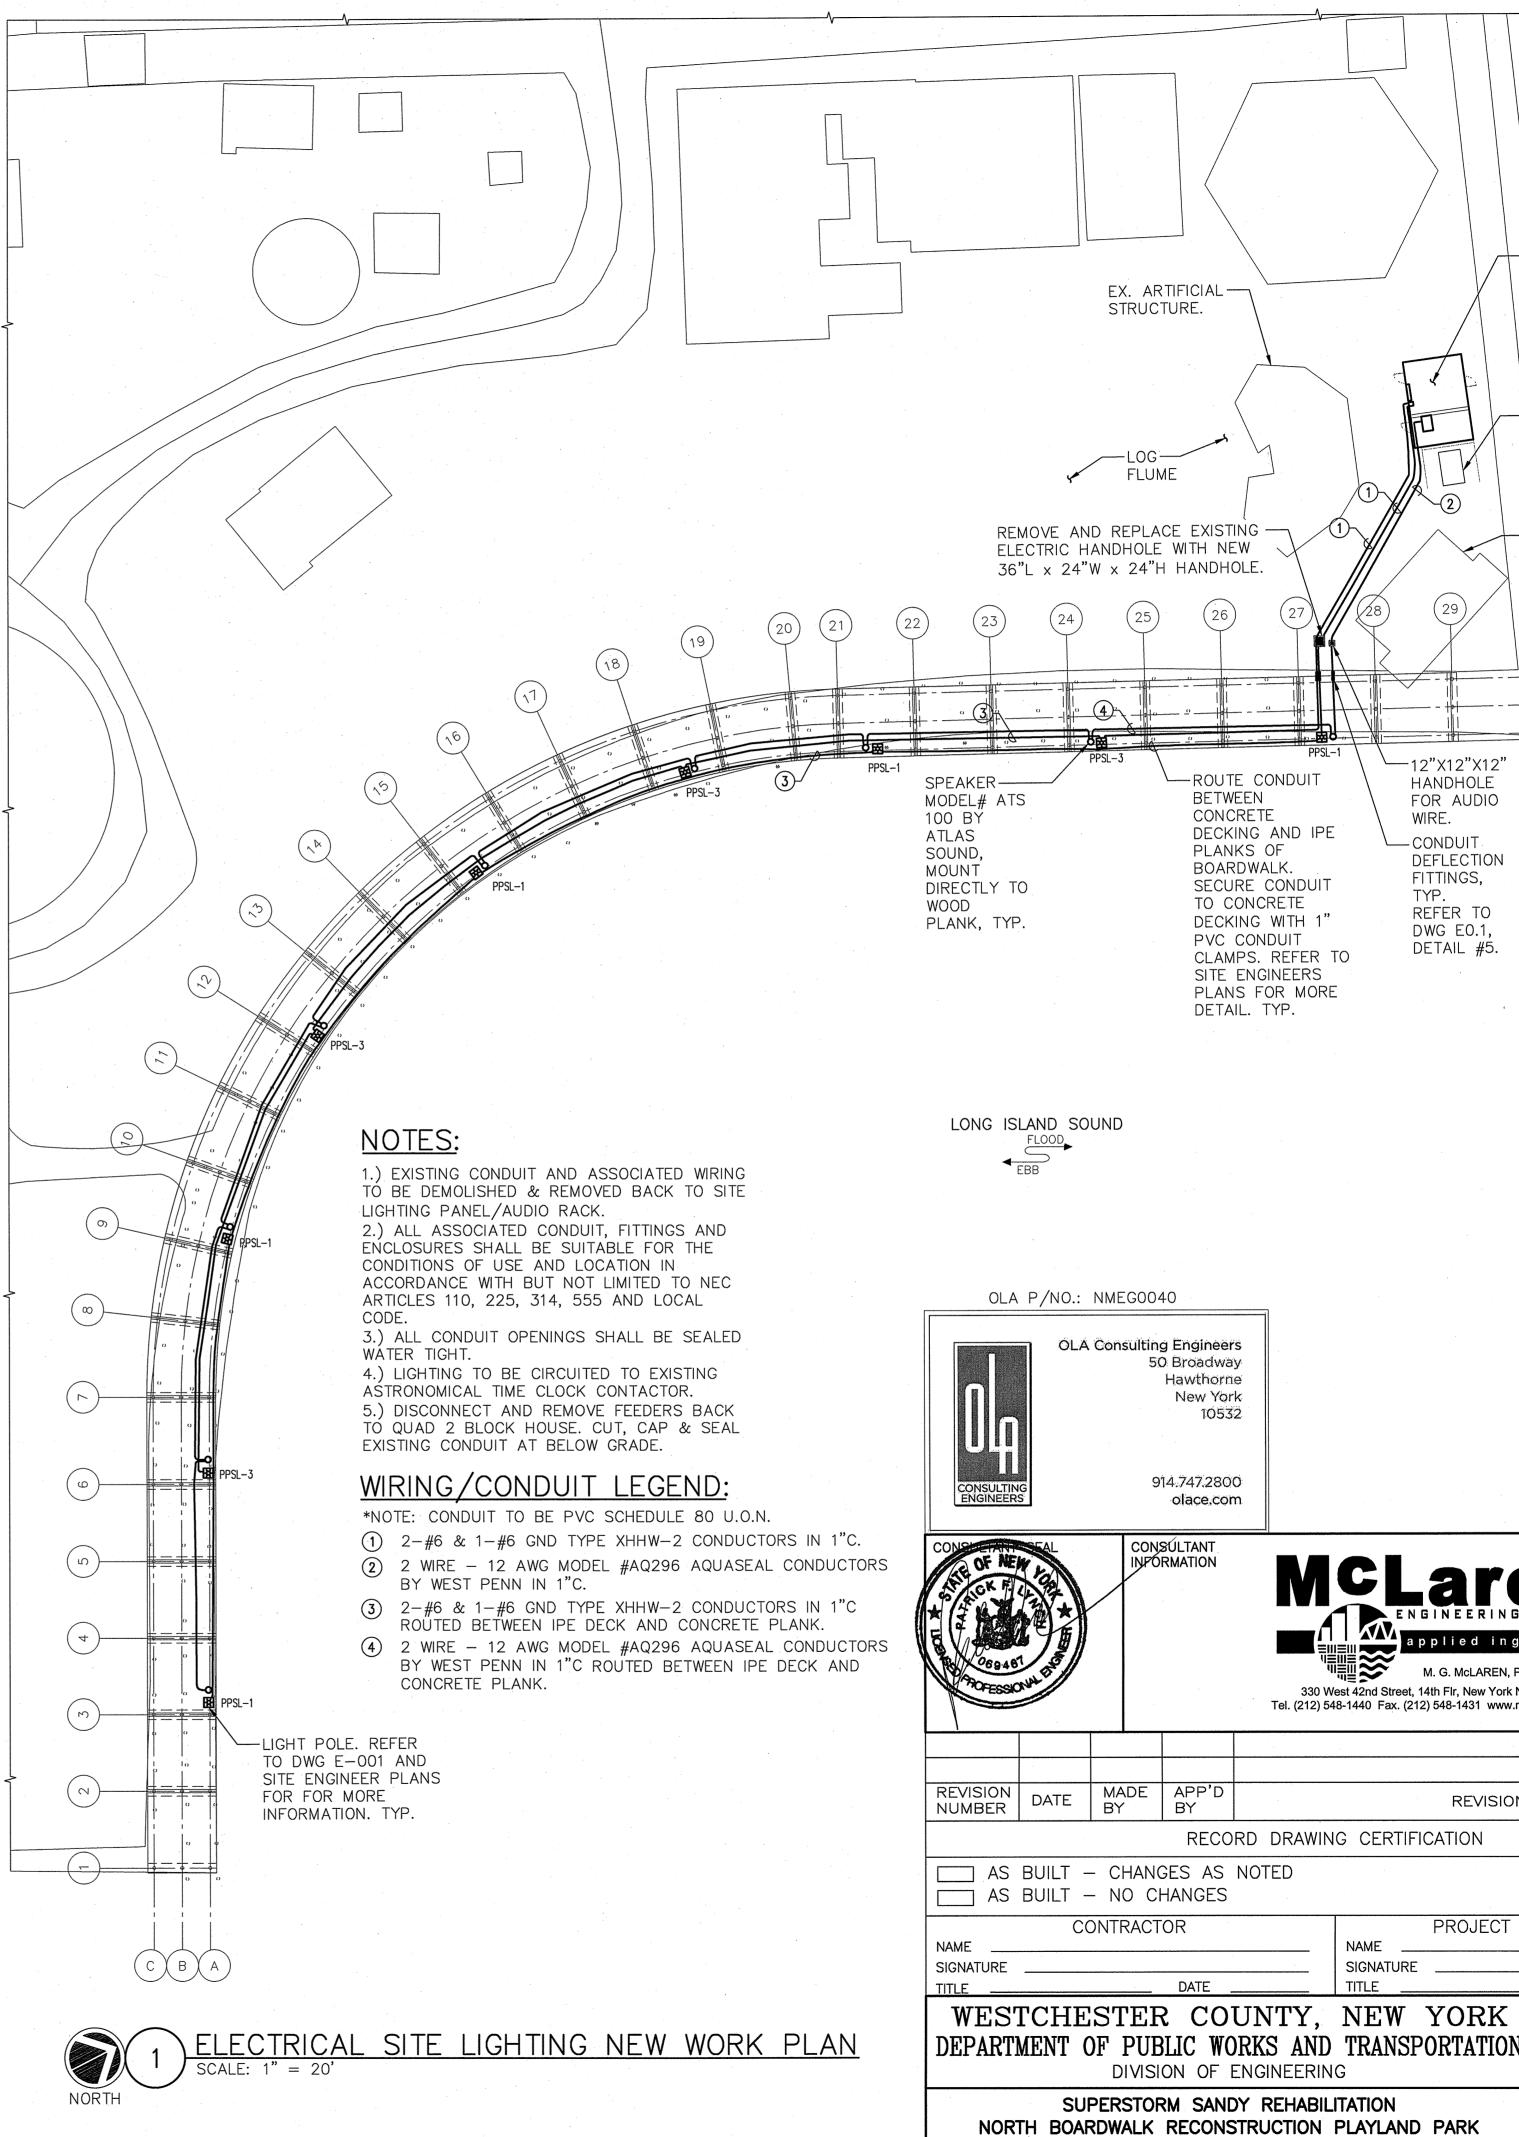

+EX. QUAD 2

ELECTRIC

BLOCK HOUSE

ROOM. REFER

TO ELECTRIC

ROOM NEW

WORK PART

__EX. GENERATOR.

-EXISTING BUILDING TO BE REMOVED.

REFER TO NOTE

'PLAN.

-12"X12"X12"

HANDHOLE

WIRE.

-CONDUIT

FITTINGS,

REFER TO

DWG EO.1,

DETAIL #5.

ENGINEERING GROUP

applied ingenuity

M. G. McLAREN, P.C.

REVISION

PROJECT COORDINATOR

15-528

DPW FILE NO.

SHEET NO. 21 OF 21

SCALE: AS NOTED DATE: 7/26/16

1-08-E-162

SHEET NUMBER

E-003

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RECORD DRAWING CERTIFICATION

SIGNATURE

FOR AUDIO

DEFLECTION

-ROUTE CONDUIT

DECKING AND IPE

SECURE CONDUIT

DECKING WITH 1"

SITE ENGINEERS

PLANS FOR MORE

CLAMPS. REFER TO

TO CONCRETE

PVC CONDUIT

DETAIL. TYP.

50 Broadway

Hawthorne

New York

914.747.2800 olace.com

DATE

TOWN OF RYE, NEW YORK

ELECTRICAL SITE LIGHTING NEW WORK PLAN

CONSULTANT INFORMATION

10532

BETWEEN

CONCRETE

PLANKS OF

BOARDWALK.

IN CHARGE OF J. MULVEY